

Agenda Item No. 15

Staff Report

Date:March 9, 2023To:Mayor Kuhl and Council MembersFrom:Alex Lopez-Vega, Assistant PlannerSubject:Whittington Residence, 41 Poplar Avenue

Recommendation

It is recommended that the Town Council adopt Resolution No. 2293 (see **Attachment 1**) approving Design Review, and a Variance for the subject project as described below.

Property Address:	41 Poplar Avenue
A.P.N.:	073-273-04
Applicant:	Eric M. Spletzer
Property Owner:	Michael and Mindy Whittington
Zoning:	R-1:B-7_5
General Plan:	ML (Medium Low Density)
Flood Zone:	AE (Floodway)

Project Description:

The applicant is requesting approval for Design Review and a Variance. The project proposes to lift the existing two-story single-family residence 4'3" above its existing elevation in its current location in order to raise the habitable space out of the floodplain. The maximum building height would increase from 18'-6" to a proposed 22'9" which would comply with the maximum allowed 30 – foot building height limit. The project includes expanding the second-story deck and removing the existing stairs. A new rear porch is proposed below the new second-story deck which will encroach into the side yard setback. The project will include interior work which will exchange some existing floor area for new floor area, replace and install new windows, and update the front entry stairs with a new handrail.

Project Data

	Code Standard	Existing	Proposed
Lot Area	7,500SF	8,962 SF	No change
Floor Area (FAR)	20%	2,709 SF (30.23%)	No Change
Building Coverage	20%	1,626 SF (18.15%)	1,670 SF (18.64%)
Front Setback	25′	26'	No Change
Side Setback (West)	15′	21′	No Change
Side Setback (East)	15′	9'-3"	No Change
Rear Setback	40'	100'	No Change
Building Height	30'	18' 6"	22'9"
Parking	2 (1 Covered)	2 (1 Covered)	2 (1 Covered)
Impervious Surface Coverage	Minimize and/or mitigate for any increase.	1,438 SF	1,217 SF

Project plans are included as **Attachment 2**; Project Application and Materials are included as **Attachment 3**.

The proposed project is subject to the following permit approval:

Design Review Permit is required pursuant to RMC Section 18.41.010 to allow for construction of a new building exceeding 200 square feet of a new floor area; fences and gates greater than 48" in height adjacent to the street right-of-way; a project resulting in more than 50 cubic yards of grading or filling; a project resulting in over 1,000 square feet of new impervious landscape surface; and redevelopment, rehabilitation, and/or renovation of existing landscape over 2,500 square feet.

 Variance Permit is required pursuant to RMC Section 18.48.010 to allow for the construction of a new porch which is nonconforming with respect to the side yard setback.

Background

The project site is an 8,962 square-foot rectangular lot on the west side of Poplar Avenue. The property is located within the Federal Emergency Management Agency (FEMA) Special Flood Hazard Area Zone AE, which is defined as an area subject to inundation by the 1- percent-annual-chance flood event (also referred to as the base flood or 100-year flood).

Advisory Design Review

Pursuant to Resolution No. 1990, Advisory Design Review is required for all applicants seeking discretionary land use permits, such as Design Review, a Demolition Permit, a Nonconformity Permit, Exceptions for Attics, a Hillside Lot Permit, and/or a Variance.

On February 15, 2023, the ADR Group unanimously recommended that the project is consistent with the purpose of Design Review and the Design Review criteria and standards per Section 18.41.100, and, therefore, supported approval of Design Review. Four of the ADR members supported the project but could not support the expansion of the second story deck. One of the ADR members supported the second story deck because there is an existing deck there and the expansion would not change the use. The ADR members discussed privacy concerns for the second story deck. The applicant is proposing additional privacy screening to the south with a planted trellis wall, and the applicant is also working with the neighbors on a landscape plan to include more privacy screening at ground level. The revised plans included as Attachment 2 reflect the ADR suggestions.

A few of the ADR members had some architectural advice for the applicant, they suggested lifting the house as much as possible to avoid the house from flooding as well as making the front/ west elevation downstairs windows bigger in proportion to the new height. As a result, the applicant will lift the entire mass another 7" which will increase the home up to 22' 9", as for the front window, the applicant will increase the height of the window accordingly to the new height. The project architect has also included a narrative of the changes to **(Attachment 2)** based on the ADR comments.

Draft minutes of the February 15, 2023, ADR meeting are included as Attachment 4.

Discussion

The proposed project is subject to the following permit approvals pursuant to the Ross Municipal Code:

Design Review

Design Review is intended to guide new development to preserve and enhance the special qualities of Ross and to sustain the beauty of the town's environment. Other specific purposes

include: provide excellence of design for all new development which harmonizes style, intensity and type of construction with the natural environment and respects the unique needs and features of each site and area; preserve and enhance the historical "small town," low-density character and identity that is unique to the Town of Ross, and maintain the serene, quiet character of the town's neighborhoods; and preserve lands which are unique environmental resources including scenic resources (ridgelines, hillsides and trees), vegetation and wildlife habitat, creeks, threatened and endangered species habitat, open space and areas necessary to protect community health and safety.

The Town Council may approve, conditionally approve or deny an application for design review. The Town Council shall include conditions necessary to meet the purpose of Design Review pursuant to Chapter 18.41 and for substantial compliance with the criteria set forth in this chapter. If Council intends to approve Design Review, staff recommends that the required findings for approval be satisfied for the proposed project, as follows:

- The project is consistent with the purpose of Design Review as outlined in Section 18.41.010. (Section 18.41.070 (b) (1))
- The project is in substantial compliance with the design criteria of Section 18.41.100. (Section 18.41.070 (b) (2))
- The project is consistent with the Ross General Plan and zoning ordinance. (Section 18.41.070 (b) (3))

Staff recommends approval of Design Review, as summarized below and as supported by the findings in Exhibit "A" of the attached Resolution.

The project provides excellence of design consistent with the scale and quality of existing development; preserves and enhances the historical "small town," low-density character and identity that is unique to the Town of Ross; preserve lands which are unique environmental resources; enhances the area in which the project is located; and promotes and implements the design goals, policies, and criteria of the Ross General Plan. The proposed project is not monumental or excessively large size and is compatible with others in the neighborhood and do not attract attention to themselves. The project proposes materials and colors that minimize visual impacts, blend with the existing landforms and vegetative cover, are compatible with structures in the neighborhood and do not attract attention to the structures. Exterior lighting is shielded and directed downward to avoid creating glare, hazard or annoyance to adjacent property owners or passersby. Landscaping protects privacy between properties, all proposed lighting is down lit with covered bulbs. The post-project stormwater runoff rates from the site would be no greater than pre-project rates.

Variance

Pursuant to RMC Section 18.48.010, where practical difficulties, unnecessary hardships and results inconsistent with the general purpose of the zoning ordinance may result from the strict

application of certain provisions thereof, variances, exceptions and adjustments may be granted, by the Town Council in appropriate cases, after public notice and hearing as provided in the zoning ordinance. Variances shall be granted only when, because of special circumstances applicable to the property, including size, shape, topography, location or surroundings, the strict application of the zoning ordinance deprives such property of privileges enjoyed by other property in the vicinity and under identical zoning classification.

In accordance with RMC Section 18.48.010 (c), a Variance is recommended for approval to allow the construction of a new porch within the minimum required side yard setback based on the following mandatory findings:

1) That there are special circumstances or conditions applicable to the land, building or use referred to in the application.

<u>Analysis:</u> The special circumstances and conditions applicable to the land include the narrow shape of the subject lot. The existing nonconforming building occupies the majority of the non-setback area of the lot. Consequently, the strict application of the minimum required side yard setback on the property would deprive the subject property of privileges enjoyed by other properties of similar size in the vicinity and under identical zoning classifications, such as the ability to construct a new porch.

2) That the granting of the application is necessary for the preservation and enjoyment of substantial property rights.

<u>Analysis:</u> Rear yards and patios are commonly enjoyed by owners of residential properties in the immediate vicinity. Granting of the variance request, in a neighborhood where existing nonconforming setbacks are not uncommon, may be deemed necessary for the preservation and enjoyment of the owner's substantial property rights. Granting of the variance would not constitute a grant of special privileges inconsistent with the limitations upon other properties in the vicinity and zone in which such property is situated.

3) That the granting of the application will not materially affect adversely the health or safety of persons residing or working in the neighborhood of the property of the applicant and will not be materially detrimental to the public welfare or injurious to property or improvements in the neighborhood.

<u>Analysis:</u> The proposed new porch will not adversely affect the health or safety of the persons residing or working in the neighborhood as the porch will have a physical wall with a window matching the existing house providing privacy to the adjacent property. The existing mature landscaping and shrubs would also provide visual screening from adjacent properties. The applicant also consulted with the homeowners most affected at 43 Poplar Avenue, who currently reside along the southern edge of the Whittington property line and approve of the project.

Fiscal, Resource and Timeline Impacts

If approved, the project would be subject to one-time fees for a building permit and associated impact fees, which are based on the reasonable expected cost of providing the associated services and facilities related to the development. The improved project site may be reassessed at a higher value by the Marin County Assessor, leading to an increase in the Town's property tax revenues. Lastly, there would be no net funding impacts associated with the project.

Alternative actions

- 1. Continue the item to gather further information, conduct further analysis, or revise the project; or
- 2. Make findings to deny the application.

Environmental Review

The project is categorically exempt from the requirement for the preparation of environmental documents under the California Environmental Quality Act (CEQA) under CEQA Guidelines Section 15301 (Existing Facilities), because it consists of the operation, repair, maintenance, permitting, leasing, licensing, or minor alteration of existing public or private structures, facilities, mechanical equipment, or topographical features, involving negligible or no expansion of use beyond that existing at the time of the lead agency's determination.

Public Comment

Public Notices were mailed to property owners within 300 feet of the project site 10 days prior to the meeting date and no comments have been received at the time of writing this report.

Attachments

- 1. Resolution No. 2293
- 2. Project Plans
- 3. Project Application Materials
- 4. ADR Meeting Minutes, February 15, 2023

ATTACHMENT 1

TOWN OF ROSS

RESOLUTION NO. 2293 RESOLUTION OF THE TOWN OF ROSS APPROVING DESIGN REVIEW, AND A VARIANCE PERMIT TO ELEVATE THE EXISTING TWO-STORY SINGLE-FAMILY RESIDENCE 4'3" FEET AND CONSTRUCT A NEW PORCH LOCATED AT 41 POPLAR AVENUE, A.P.N. 073-273-04

WHEREAS, applicant Eric M. Spletzer, on behalf of property owners Michael and Mindy Whittington has submitted an application requesting approval of Design Review, and a Variance Permit to lift the existing two-story single-family residence 4'3" above its existing elevation in its current location in order to raise the habitable space out of the floodplain and construct a new porch within the side yard setback at 41 Poplar Avenue APN 073-273-04 (herein referred to as "the Project").

WHEREAS, the Project is determined to be categorically exempt from the requirement for the preparation of environmental documents under the California Environmental Quality Act (CEQA) Guidelines 15301 (Existing Facilities), because it consists of the operation, repair, maintenance, permitting, leasing, licensing, or minor alteration of existing public or private structures, facilities, mechanical equipment, or topographical features, involving negligible or no expansion of use beyond that existing at the time of the lead agency's determination; and

WHEREAS, on March 9, 2023, the Town Council held a duly noticed public hearing to consider the Project; and

WHEREAS, the Town Council has carefully reviewed and considered the staff reports, correspondence, and other information contained in the project file, and has received public comment; and

NOW, THEREFORE, BE IT RESOLVED the Town Council of the Town of Ross hereby incorporates the recitals above; makes the findings set forth in Exhibit "A", and approves Design Review, a Variance Permit subject to the Conditions of Approval attached as Exhibit "B".

The foregoing resolution was duly and regularly adopted by the Ross Town Council at its regular meeting held on the 9th day of March 2023, by the following vote:

AYES:

NOES:

ABSENT:

ABSTAIN:

ATTEST:

P. Beach Kuhl, Mayor

Cyndie Martel, Town Clerk

EXHIBIT "A" FINDINGS 41 Poplar Avenue A.P.N. 073-273-04

A. Findings

I. In accordance with Ross Municipal Code (RMC) Section 18.41.070, Design Review is approved based on the following mandatory findings:

a) The project is consistent with the purpose of the Design Review chapter as outlined in RMC Section 18.41.010.

As recommended by the Advisory Design Review (ADR) Group, the Project is consistent with the purpose of the Design Review chapter as outlined in RMC Section 18.41.010. It provides excellence of design consistent with the scale and quality of existing development; preserves and enhances the historical "small town," low-density character and identity that is unique to the Town of Ross; preserve lands which are unique environmental resources; enhances the area in which the Project is located; and promotes and implements the design goals, policies and criteria of the Ross general plan.

b) The project is in substantial compliance with the design criteria of RMC Section 18.41.100.

As recommended by the Advisory Design Review (ADR) Group, the Project is in substantial compliance with the design criteria of RMC Section 18.41.100. The site would be kept in harmony with the general appearance of neighboring landscape. Lot coverage and building footprints would be minimized, and development clustered, to minimize site disturbance area and preserve large areas of undisturbed space. New buildings constructed on sloping land are designed to relate to the natural landforms and step with the slope in order to minimize building mass, bulk and height and to integrate the structure with the site. Buildings would use materials and colors that minimize visual impacts and blend with the existing landforms and vegetative cover, including wood and stone. Good access, circulation would be provided consistent with the natural features of the site. Open fencing would be aesthetically attractive and not create a "walled-in" feeling or a harsh, solid expanse. Landscaping would be integrated into the architectural scheme to accent and enhance the appearance of the development, including attractive, fire-resistant, native species and replacement trees for trees removed by development. Landscaping would create and maintain defensible spaces around buildings and structures as appropriate to prevent the spread of wildfire. The Project would maximize permeability and reduce the overall impervious surface coverage on the property, by providing bioretention facilities to offset the new development, so that the post-development stormwater runoff rates from the site would be no greater than pre-project rates.

c) The project is consistent with the Ross General Plan and zoning ordinance.

The Project is consistent with the allowed uses and general development standards associated with the Medium Low-Density land use designation of the General Plan, the Single-Family Residence and

Special Building Site zoning regulations, therefore the Project is found to be consistent with the Ross General Plan and Zoning Ordinance.

II. In accordance with Ross Municipal Code (RMC) Section 18.48.010(c), Variance is approved based on the following mandatory findings:

a) That there are special circumstances or conditions applicable to the land, building or use referred to in the application.

The special circumstances and conditions applicable to the land include the narrow shape of the subject lot. The existing nonconforming building which occupies the majority of the side setback area of the lot. Consequently, the strict application of the minimum required side yard setback on the property would deprive the subject property of privileges enjoyed by other properties of similar size in the vicinity and under identical zoning classifications, such as the ability to construct a new porch.

b) That the granting of the application is necessary for the preservation and enjoyment of substantial property rights.

Rear yards and patios are commonly enjoyed by owners of residential properties in the immediate vicinity. Granting of the variance request, in a neighborhood where existing nonconforming setbacks are not uncommon, may be deemed necessary for the preservation and enjoyment of the owner's substantial property rights. Granting of the variance would not constitute a grant of special privileges inconsistent with the limitations upon other properties in the vicinity and zone in which such property is situated.

c) That the granting of the application will not materially affect adversely the health or safety of persons residing or working in the neighborhood of the property of the applicant and will not be materially detrimental to the public welfare or injurious to property or improvements in the neighborhood.

The proposed new porch will not adversely affect the health or safety of the persons residing or working in the neighborhood as the porch will have a physical wall with a window matching the existing house providing privacy to the adjacent property. The existing mature landscaping and shrubs would also provide visual screening from adjacent properties. The applicant also consulted with the homeowners at 43 Poplar Avenue, who currently reside along the southern edge of the Whittington property line and approve of the project.

EXHIBIT "B" CONDITIONS OF APPROVAL 41 POPLAR AVENUE A.P.N. 073-273-04

- 1. This approval authorizes Design Review and a Variance to lift the existing two-story single-family residence 4'3" above its existing elevation in its current location and construct a new porch within the side yard setback located at 41 Poplar Avenue, APN 073-273-04 (herein referred to as "the Project").
- 2. The building permit shall substantially conform to the plans entitled, "41 Poplar" and dated 2/15/2023, and reviewed and approved by the Town Council on March 9, 2023
- 3. Except as otherwise provided in these conditions, the Project shall comply with the plans submitted for Town Council approval. Plans submitted for the building permit shall reflect any modifications required by the Town Council and these conditions.
- 4. No changes from the approved plans, before or after project final, including changes to the materials and material colors, shall be permitted without prior Town approval. Red-lined plans showing any proposed changes shall be submitted to the Town for review and approval prior to any change. The applicant is advised that changes made to the design during construction may delay the completion of the Project and will not extend the permitted construction period.
- 5. The Project shall comply with the Fire Code and all requirement of the Ross Valley Fire Department (RVFD).
- 6. The Town staff reserves the right to require additional landscape screening for up to three (3) years from project final to ensure adequate screening for the properties that are directly contiguous to the project site. The Town staff will only require additional landscape screening if the contiguous neighbor can demonstrate through pre-project existing condition pictures that their privacy is being negatively impacted as a result of the Project.
- 7. BEFORE FINAL INSPECTION, the applicant shall call for a Planning staff inspection of approved landscaping, building materials and colors, lighting and compliance with conditions of project approval at least five business days before the anticipated completion of the Project. Failure to pass inspection will result in withholding of the Final Inspection approval and imposition of hourly fees for subsequent re-inspections.
- 8. A Tree Permit shall not be issued until the project grading or building permit is issued.
- 9. The Project shall comply with the following conditions of the Town of Ross Building Department and Public Works Department:

- a. Any person engaging in business within the Town of Ross must first obtain a business license from the Town and pay the business license fee. Applicant shall provide the names of the owner, architects, engineers and any other people providing project services within the Town, including names, addresses, e-mail, and phone numbers. All such people shall file for a business license. A final list shall be submitted to the Town prior to project final.
- b. A registered Architect or Engineer's stamp and signature must be placed on all plan pages.
- c. The building department may require the applicant to submit a deposit prior to building permit issuance to cover the anticipated cost for any Town consultants, such as the town hydrologist, review of the Project. Any additional costs incurred by the Town, including costs to inspect or review the Project, shall be paid as incurred and prior to project final.
- d. The applicant shall submit an erosion control plan with the building permit application for review by the building official/director of public works. The Plan shall include signed statement by the soils engineer that erosion control is in accordance with Marin County Stormwater Pollution Prevention Program (MCSTOPP) standards. The erosion control plan shall demonstrate protection of disturbed soil from rain and surface runoff and demonstrate sediment controls as a "back-up" system (i.e., temporary seeding and mulching or straw matting).
- e. No grading shall be permitted during the rainy season between October 15 and April 15 unless permitted in writing by the Building Official/Director of Public Works. Grading is considered to be any movement of earthen materials necessary for the completion of the Project. This includes, but is not limited to cutting, filling, excavation for foundations, and the drilling of pier holes. It does not include the boring or test excavations necessary for a soils engineering investigation. All temporary and permanent erosion control measures shall be in place prior to October 1.
- f. The drainage design shall comply with the Town's stormwater ordinance (Ross Municipal Code Chapter 15.54). A drainage plan and hydrologic/hydraulic analysis shall be submitted with the building permit application for review and approval by the building official/public works director.
- g. An encroachment permit is required from the Department of Public Works prior to any work within a public right-of-way.
- h. The plans submitted for a building permit shall include a detailed construction and traffic management plan for review and approval of the building official, in consultation with the town planner and police chief. The plan shall include as a minimum: tree protection, management of worker vehicle parking, location of portable toilets, areas for material storage, traffic control, method of hauling and haul routes, size of vehicles, and washout areas. The plan shall demonstrate that on-street parking associated with construction workers and deliveries are prohibited and that all project deliveries shall occur during the allowable working hours as identified in the below condition 10n.

- i. The applicant shall submit a schedule that outlines the scheduling of the site development to the building official. The schedule should clearly show completion of all site grading activities prior to the winter storm season and include implementation of an erosion control plan. The construction schedule shall detail how the Project will be completed within the construction completion date provided for in the construction completion chapter of the Ross Municipal Code (Chapter 15.50).
- j. A preconstruction meeting with the property owner, project contractor, project architect, project arborist, representatives of the Town Planning, Building/Public Works and Ross Valley Fire Department and the Town building inspector is required prior to issuance of the building permit to review conditions of approval for the Project and the construction management plan.
- k. A copy of the building permit shall be posted at the site and emergency contact information shall be up to date at all times.
- I. The Building Official and other Town staff shall have the right to enter the property at all times during construction to review or inspect construction, progress, compliance with the approved plans and applicable codes.
- m. Inspections shall not be provided unless the Town-approved building permit plans are available on site.
- n. Working Hours are limited to Monday to Friday 8:00 a.m. to 5:00 p.m. Construction is not permitted at any time on Saturday and Sunday or the following holidays: New Year's Day, Martin Luther King Day, President's Day, Memorial Day, Juneteenth, Independence Day, Labor Day, Veteran's Day, Thanksgiving Day, and Christmas Day. If the holiday falls on a Sunday, the following Monday shall be considered the holiday. If the holiday falls on a Saturday, the Friday immediately preceding shall be considered the holiday. Exceptions: 1.) Work done solely in the interior of a building or structure which does not create any noise which is audible from the exterior; or 2.) Work actually physically performed solely by the owner of the property, on Saturday between the hours of 10:00 a.m. and 4:00 p.m. and not at any time on Sundays or the holidays listed above. (RMC Sec. 9.20.035 and 9.20.060).
- o. Failure to comply in any respect with the conditions or approved plans constitutes grounds for Town staff to immediately stop work related to the noncompliance until the matter is resolved (Ross Municipal Code Section 18.39.100). The violations may be subject to additional penalties as provided in the Ross Municipal Code and State law. If a stop work order is issued, the Town may retain an independent site monitor at the expense of the property owner prior to allowing any further grading and/or construction activities at the site.
- p. Materials shall not be stored in the public right-of-way. The project owners and contractors shall be responsible for maintaining all roadways and rights-of-way free of their construction-related debris. All construction debris, including dirt and mud, shall be cleaned and cleared immediately. All loads carried to and from the site shall be securely covered, and the public right-of-way must

be kept free of dirt and debris at all times. Dust control using reclaimed water shall be required as necessary on the site or apply (non-toxic) soil stabilizers on all unpaved access roads, parking areas and staging areas at site. Cover stockpiles of debris, soil, sand or other materials that can be blown by the wind.

- q. Applicants shall comply with all requirements of all utilities including, the Marin Municipal Water District, Ross Valley Sanitary District, and PG&E prior to project final. Letters confirming compliance shall be submitted to the building department prior to project final.
- r. All electric, communication and television service laterals shall be placed underground unless otherwise approved by the director of public works pursuant to Ross Municipal Code Section 15.25.120.
- s. The Project shall comply with building permit submittal requirements as determined by the Building Department and identify such in the plans submitted for building permit.
- t. Final inspection and written approval of the applicable work by Town Building, Planning and Fire Department staff shall mark the date of construction completion.
- u. The Public Works Department may require submittal of a grading security in the form of a Certificate of Deposit (CD) or cash to cover grading, drainage, and erosion control. Contact the Department of Public Works for details.
- v. BEFORE FINAL INSPECTION, the Soils Engineer shall provide a letter to the Department of Public Works certifying that all grading and drainage has been constructed according to plans filed with the grading permit and his/her recommendations. Any changes in the approved grading and drainage plans shall be certified by the Soils Engineer and approved by the Department of Public Works. No modifications to the approved plans shall be made without approval of the Soils Engineer and the Department of Public Works.
 - i. The existing vegetation shall not be disturbed until landscaping is installed or erosion control measures, such as straw matting, hydroseeding, etc., are implemented.
 - ii. All construction materials, debris and equipment shall be stored on site. If that is not physically possible, an encroachment permit shall be obtained from the Department of Public Works prior to placing any construction materials, debris, debris boxes or unlicensed equipment in the right-of-way.
- iii. The applicant shall provide a hard copy and a CD of an as-built set of drawings, and a certification from all the design professionals to the building department certifying that all construction was in accordance with the as-built plans and his/her recommendations.
- 10. The applicants and/or owners shall defend, indemnify, and hold the Town harmless along with the Town Council and Town boards, commissions, agents, officers, employees, and consultants from any

claim, action, or proceeding ("action") against the Town, its boards, commissions, agents, officers, employees, and consultants attacking or seeking to set aside, declare void, or annul the approval(s) of the Project or alleging any other liability or damages based upon, caused by, or related to the approval of the Project. The Town shall promptly notify the applicants and/or owners of any action. The Town, in its sole discretion, may tender the defense of the action to the applicants and/or owners or the Town may defend the action with its attorneys with all attorney fees and litigation costs incurred by the Town in either case paid for by the applicant and/or owners.

ATTACHMENT 2


GENERAL NOTES:

1.1 CONTRACTOR/SUBCONTRACTOR SHALL VERIFY ALL PERTINENT DIMENSIONS AND GRADE ELEVATIONS PRIOR TO BEGINNING CONSTRUCTION


1.2 CONFLICTS AND DISCREPANCIES IN INFORMATION AND OMISSIONS IN DRAWINGS OR

KITCHEN BATH BATH BATH	FAUCET TOILET VANITY FAUCET BATHTUB FAUCET	1.8 GPM @ 60 PSI 1.28 GPF 1.5 GPM @ 60 PSI 2 GPM @ 80 PSI 2 GPM @ 80 PSI
BATH	Shower head	2 GPM @ 80 PSI

ACTUAL LEVEL AT GARAGE ENTRY [(E) LVL 1]= 17.8' BFE (BASE FLOOD ELEVATION) AT 100 Years = 18' • LVL 1 LIFT = +2'-5" = **+2.4'**. **=>** [(N) LVL1 = 20.2'] • (N) LVL 1 IS 20.2'-17.8' = **2.4' ABOVE BFE**

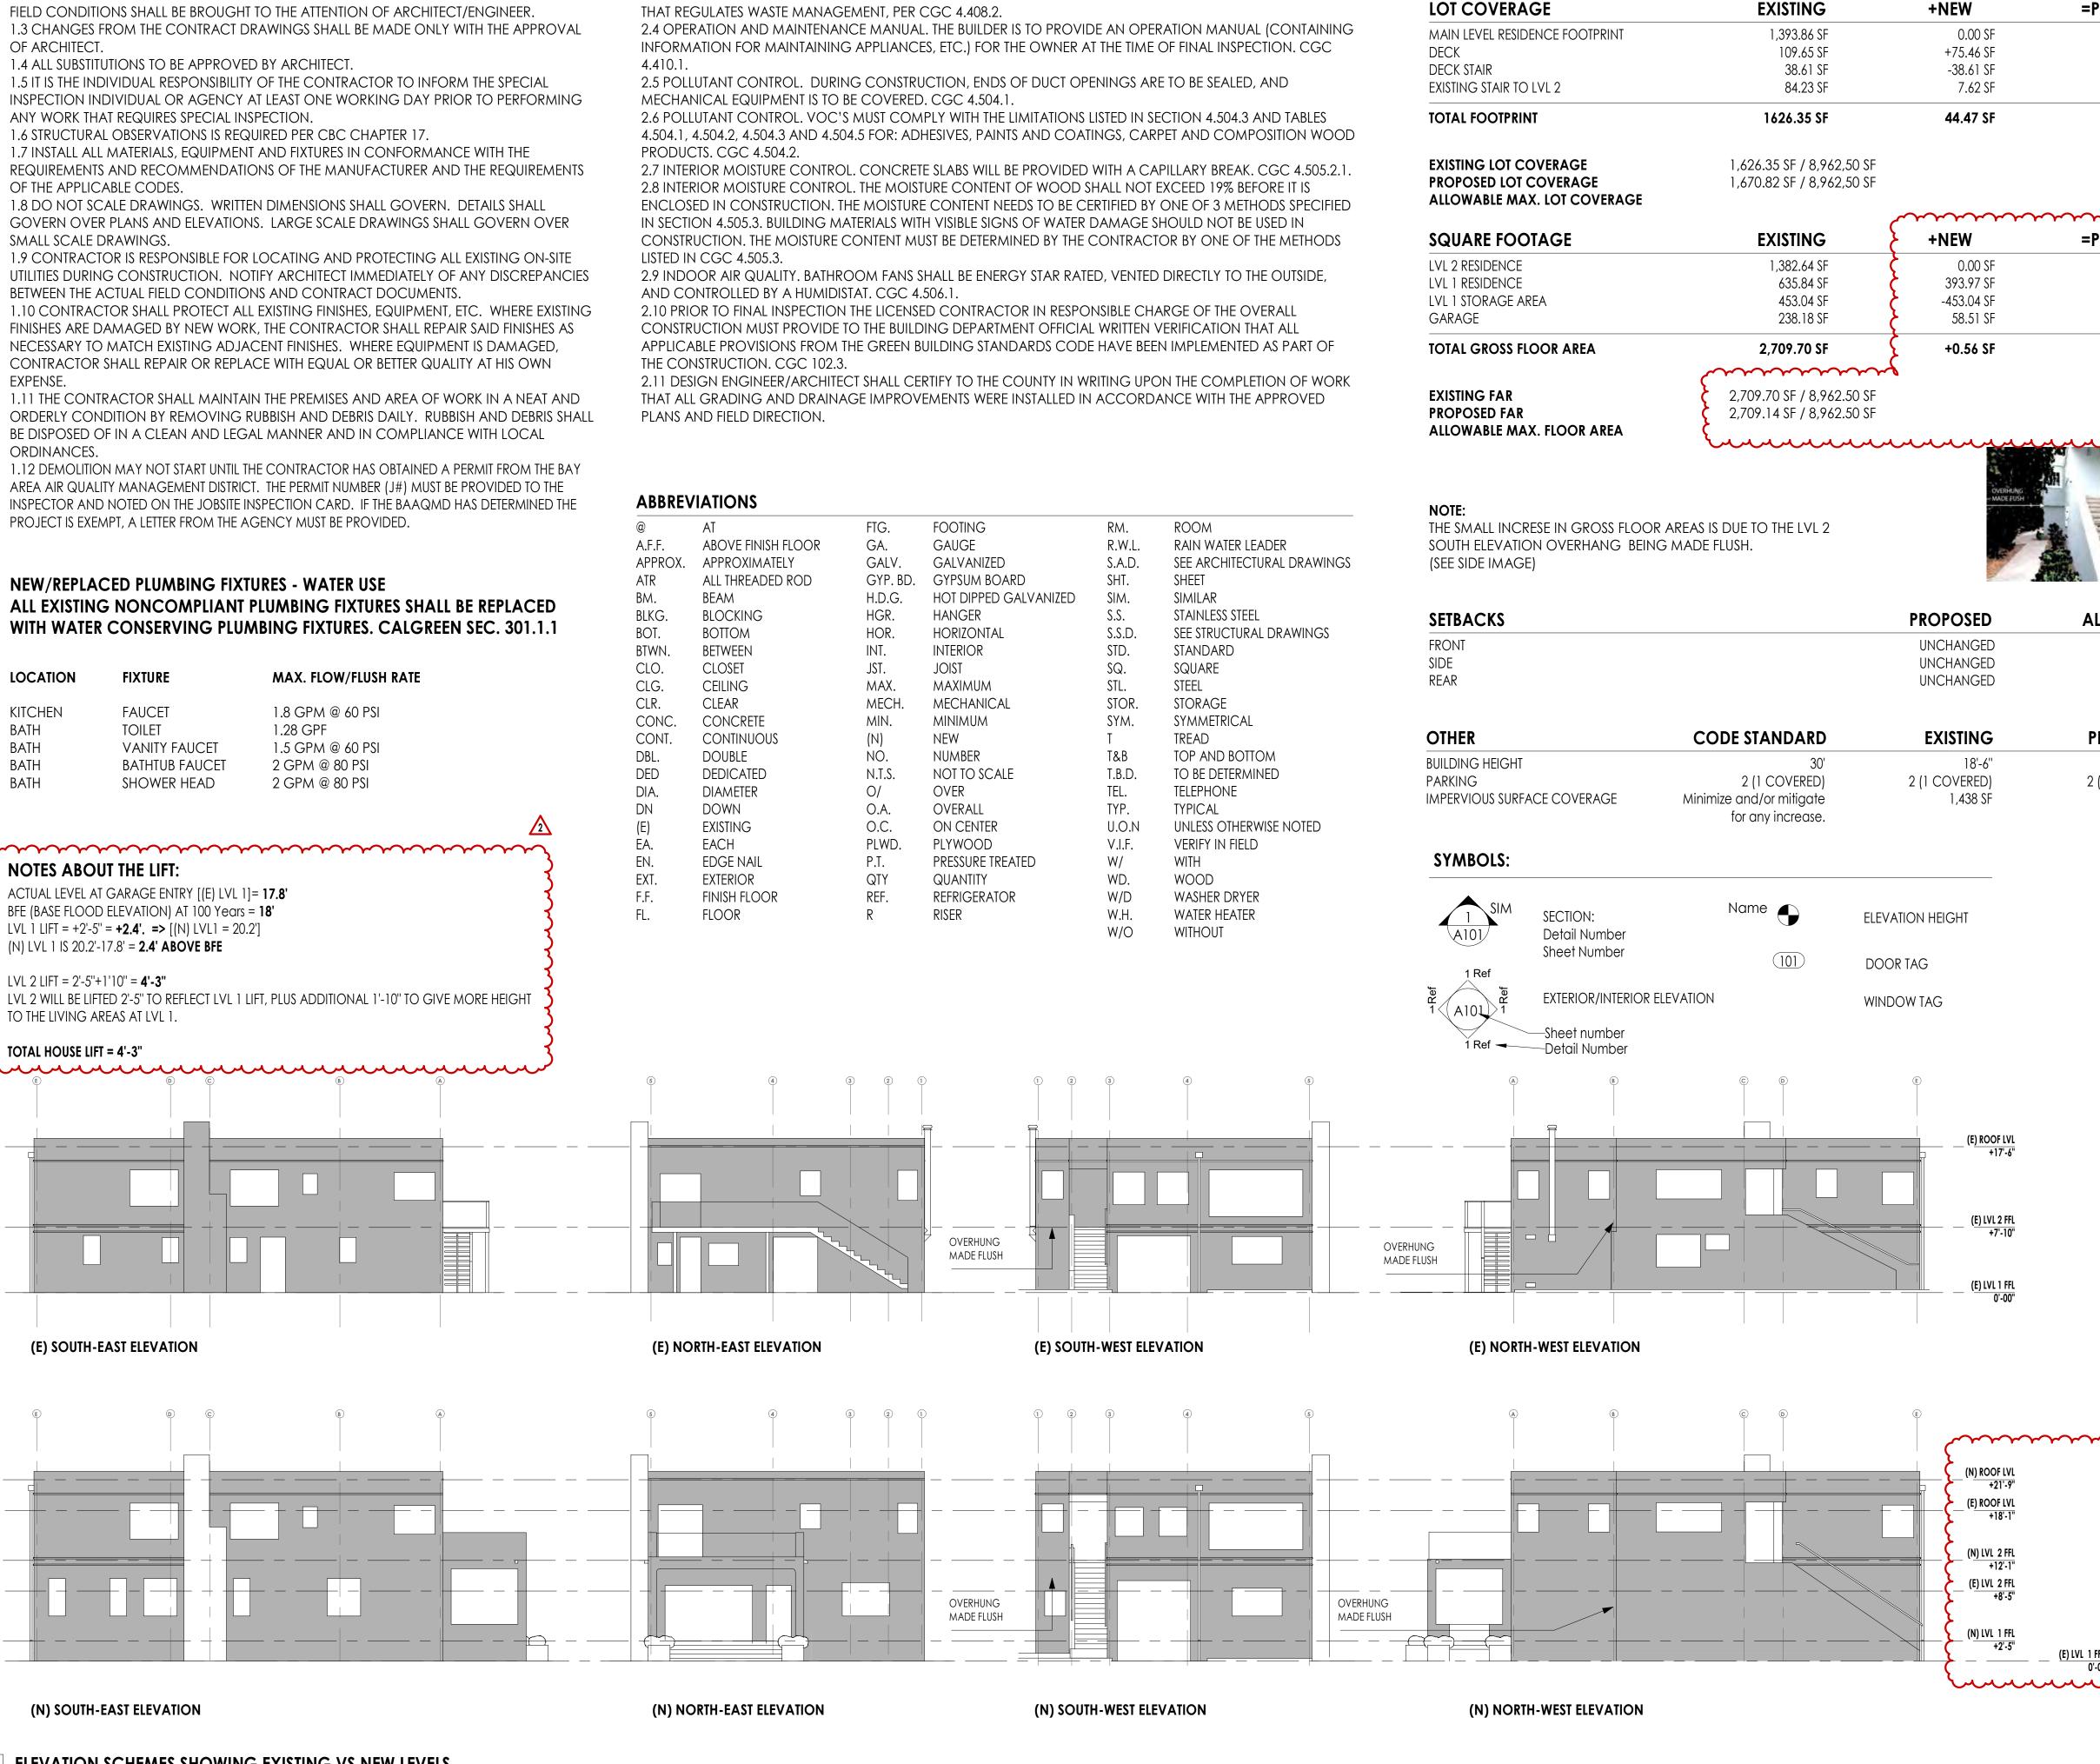




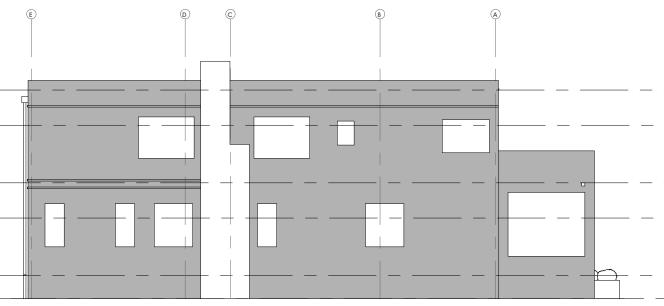


GREEN BUILDING CODE REQUIREMENTS:

2.1 LANDSCAPE IRRIGATION WATER USE SHALL HAVE WEATHER OR SOIL BASED CONTROLLERS. CGC 4.304.1. 2.2 A MINIMUM OF 50% OF CONSTRUCTION WASTE IS TO BE RECYCLED. CGC 4.408.1 2.3 THE CONTRACTOR SHALL SUBMIT A CONSTRUCTION WASTE MANAGEMENT PLAN TO THE JURISDICTION AGENCY

@	AT	FTG.	FOOTING
A.F.F.	ABOVE FINISH FLOOR	GA.	GAUGE
APPROX.	APPROXIMATELY	GALV.	GALVAN
ATR	ALL THREADED ROD	GYP. BD.	GYPSUN
BM.	BEAM	H.D.G.	HOT DIP
BLKG.	BLOCKING	HGR.	HANGER
BOT.	BOTTOM	HOR.	HORIZOI
BTWN.	BETWEEN	INT.	INTERIO
CLO.	CLOSET	JST.	JOIST
CLG.	CEILING	MAX.	MAXIMU
CLR.	CLEAR	MECH.	MECHAN
CONC.	CONCRETE	MIN.	MINIMU
CONT.	CONTINUOUS	(N)	NEW
DBL.	DOUBLE	NO.	NUMBER
DED	DEDICATED	N.T.S.	NOT TO
DIA.	DIAMETER	0/	OVER
DN	DOWN	O.A.	OVERAL
(E)	existing	O.C.	ON CEN
EA.	EACH	PLWD.	PLYWOC
EN.	EDGE NAIL	P.T.	PRESSUR
EXT.	EXTERIOR	QTY	QUANTIT
F.F.	FINISH FLOOR	REF.	REFRIGE
FI	FLOOR	P	

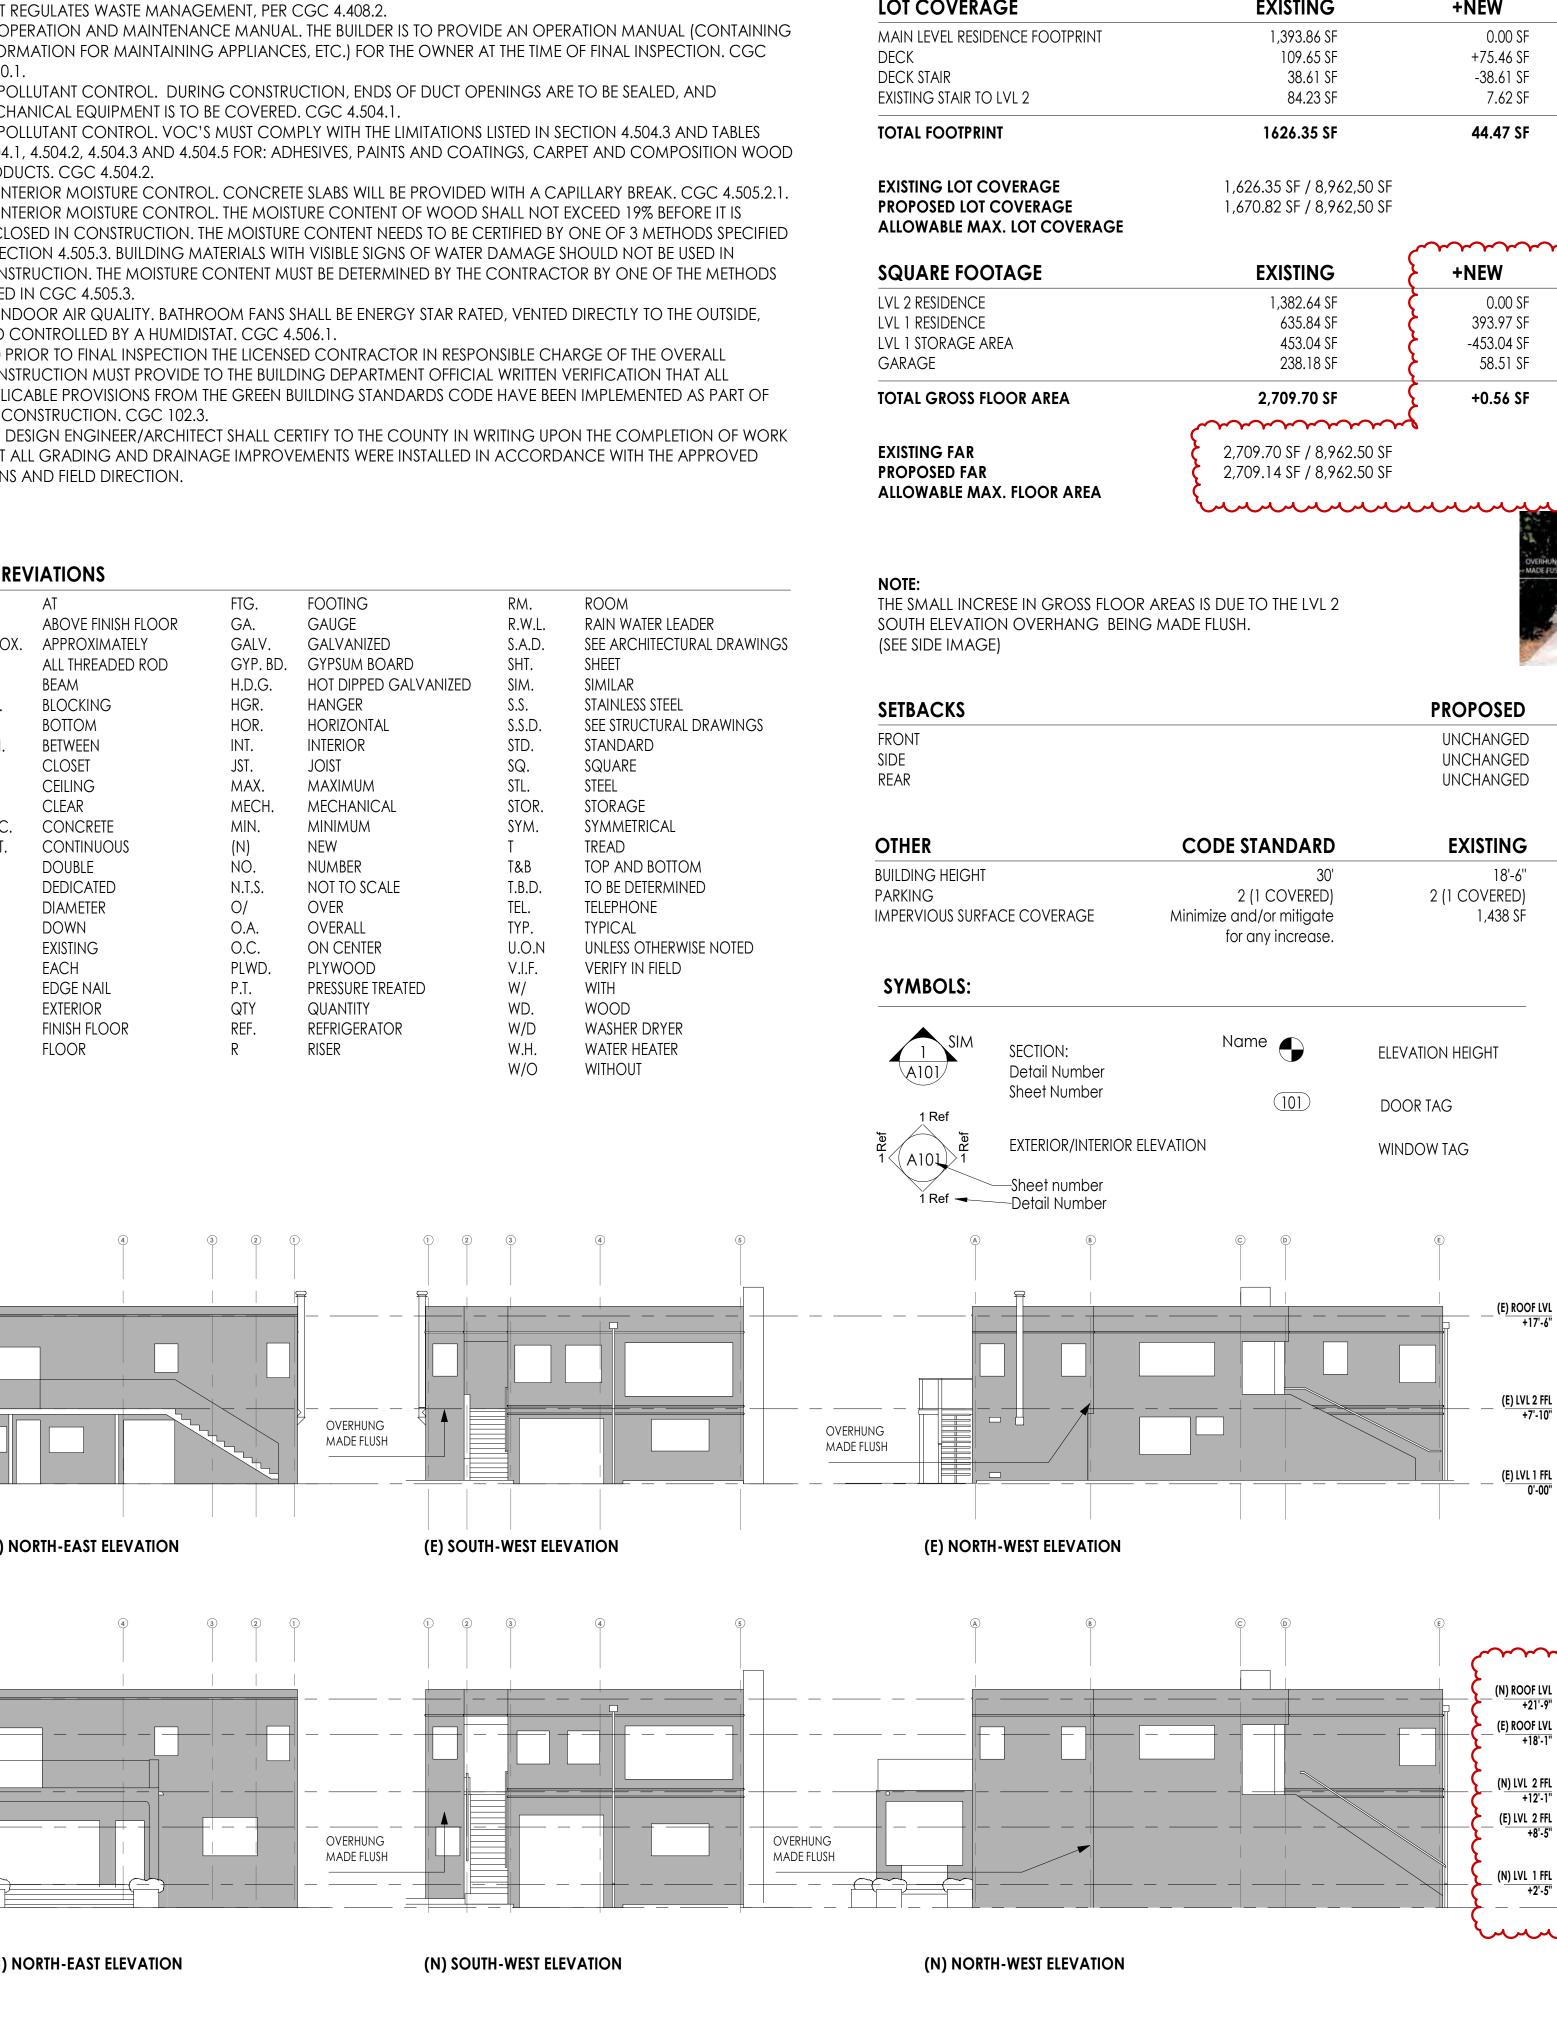

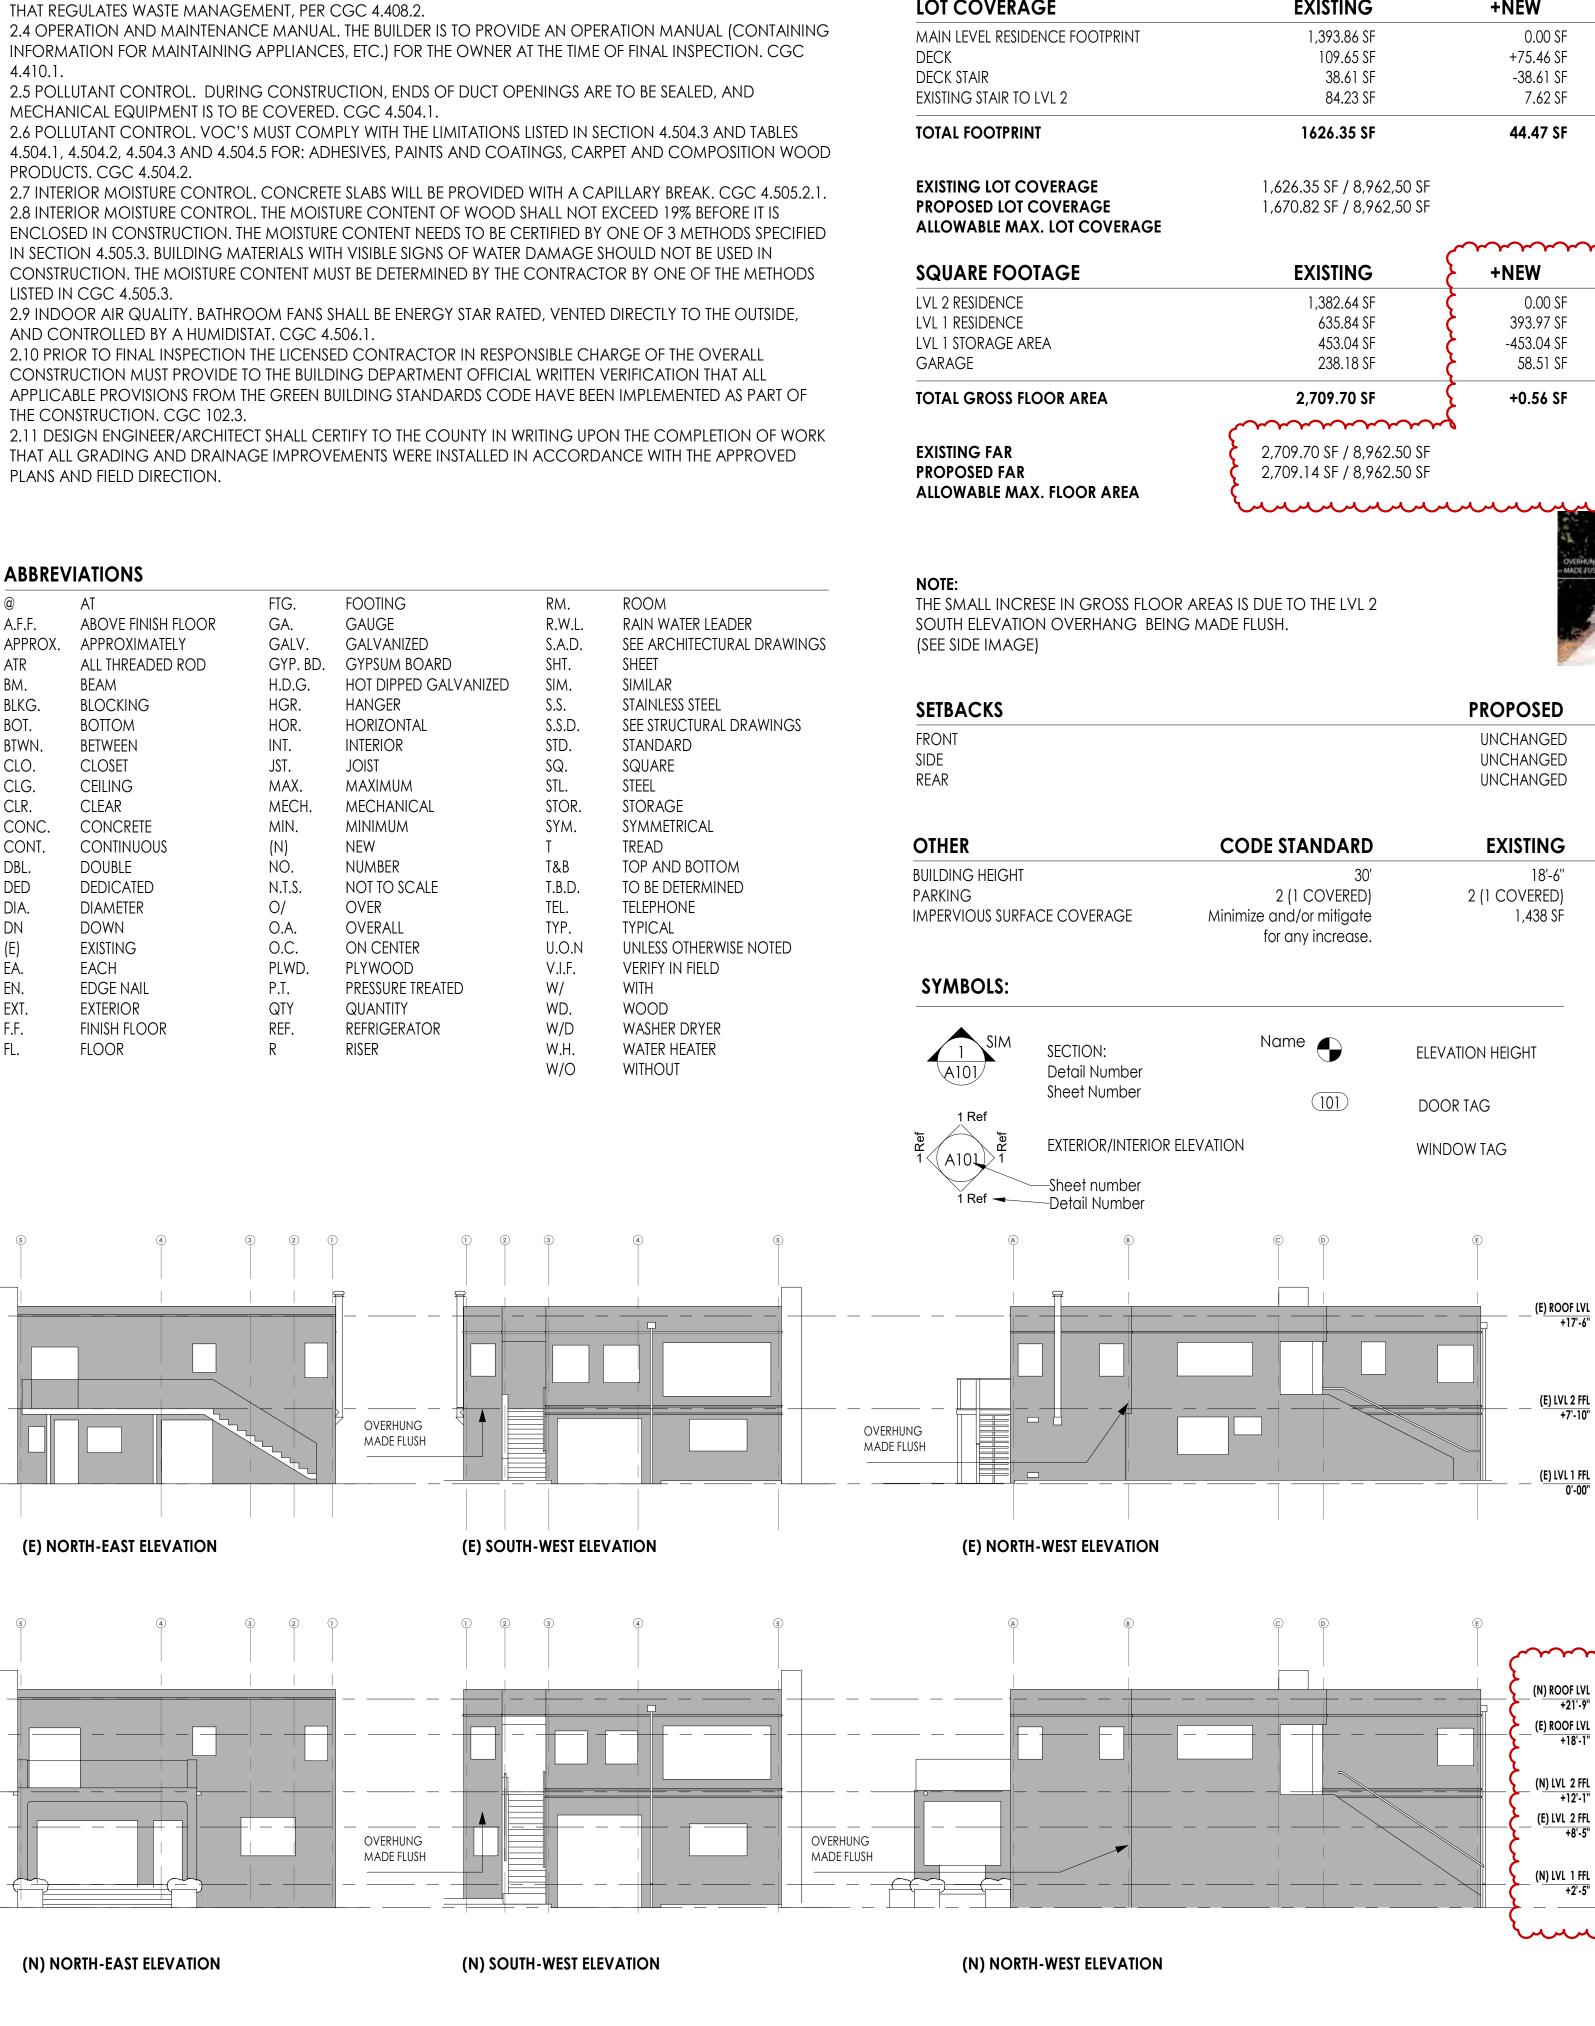

LOT INFORMATION

GROSS LOT AREA

NET LOT AREA

R-1_B-7_5

8.962,5 SF

8.962,5 SF

ZONING

=PROPOSED

1,393.86 SF 185.11 SF 0.0 SF 91.85 SF

1,670.82 SF

=18.15% =18.64% =20.00% \sim

=PROPOSED 1,382.64 SF 1,028.58 SF 0.00 SF 297.92 SF

2,709.14 SF

=30.23%

=30.22% =20.00% -----

ALLOWABLE

25'-0" 15'-0" 40'-0"

PROPOSED

22'-2" 2 (1 COVERED) 1,217 SF

PROJECT INFORMATION

ADDRESS: 41 POPLAR AVE. ROSS, CA 94957

ASSESSOR'S PARCEL NO. 073-273-04

ZONING DISTRICT: R-1_B-7_5

> **USE DESCRIPTION:** 11 - Single-Resid. - Improved

OCCUPANCY TYPE: R-3 (ONE OR TWO UNIT RESIDENTIAL)

CONSTRUCTION TYPE: V-B

STORIES:

PROJECT DESCRIPTION

REMODEL OF FIRST FLOOR AREA AFTER LIFTING FINISH FLOOR ABOVE BASE FLOOD ELEVATION.

PROJECT TEAM

CLIENT: MICHAEL AND MINDY WHITTINGTON 41 POPLAR AVE. ROSS, CA 94957 Tel: 415.430.7177 E-mail: mtwhittington@gmail.com

ENGINEER & GENERAL CONTRACTOR:

Crafted Earth, Inc. 166 Alpine St San Rafael, CA 94901 Contacts: Eric Spletzer, PE Tel: 415.699.9662 E-mail: eric@craftedearth.com

APPLICABLE CODES

2019 California Building Code 2019 California Energy Code 2019 California Plumbing Code 2019 California Mechanical Code 2019 California Electrical Code 2019 California Green Building Code

With Town of Ross Amendments

T-101 TITLE24-1 T-102 TITLE24-2

SHEET LIST

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	A-040	PROJECT DETAILS
	A-040 A-101	SITE PLANS AND AREA CALCS
	A-102	(E) LEVEL 1 AND LEVEL 2 FLOOR PLANS
	A-102	(E) ROOF PLAN AND AXO VIEW
	A-142	(N) LEVEL 1 AND LEVEL 2 FLOOR PLANS
	A-143	(N) ROOF PLAN AND AXO VIEW
	A-201	(E) ELEVATIONS
	A-241	
	A-301	(E) SECTIONS
	A-302	
	A-341	(N) CROSS SECTIONS
	A-342	
	A-541	(N) INTERIOR STAIR DETAILS
	A-542	(N) EXTERIOR STAIR DETAILS
	A-543	ARCHITECTURAL DETAILS
	A-641	WALL ASSEMBLIES
	A-642	WALL ASSEMBLIES
	A-643	WALL ASSEMBLIES
	A-644	WINDOW & DOOR SCHEDULES
	E-141	ELECTRICAL & POWER
	M-142	(N) MEP - HVAC PLANS
	M-144	(N) MEP - PLUMBING PLANS
	M-145	MEP - PLUMBING AXONOMETRY VIEWS
	S-040	
	S-141	FOUNDATION PLAN
	S-142	FRAMING PLANS
	S-241	SHEAR WALL ELEVATIONS
	S-341	STRUCTURAL SECTIONS
	S-541	TYPICAL FRAMING DETAILS
	S-542	TYPICAL FRAMING DETAILS
	S-543	FLOOR FRAMING DETAILS
	S-544	FLOOR FRAMING DETAILS
	S-545	STRUCTURAL DETAILS

CRAFTED EARTH, INC. **ENGINEERING & DESIGN**

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Michael and Mindy Whittington

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APN:073-273-04

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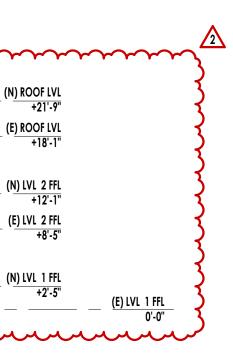
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1	CITY COMMENTS REV 1	01/11/23
Rev	Description	Date

41 Poplar Kitchen Remodel


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PROJECT DETAILS






POPLAR AVE



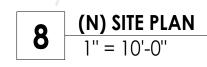

N

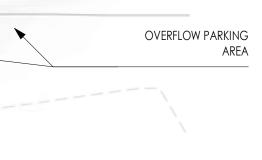

POPLAR AVE

EXISTING GROSS BUILDING AREA


Area

(E) LVL 2 GROSS BUILDING AREA 1" = 10'-0"

(E) LVL 2 LIVING AREA

Name	Area
(E) LVL 1 GARAGE	238.18 SF
(E) LVL 1 LIVING AREA	635.84 SF
(E) LVL 1 STORAGE	453.04 SF
(E) LVL 2 LIVING AREA	1382.64 SF

FOR CONSTRUCTION EQUIPMENT, STAGING, MATERIAL STORAGE, STOCKPILE, DUMPSTERS, PORTABLE TOILETS. TREE DRIPLINE PROTECTION.

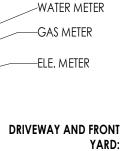

-WATER METER

0


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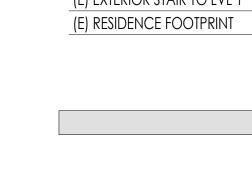
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(E) LVL 1 GARAG

238 SF

(E) LVL 1 GROSS BUILDING AREA 1" = 10'-0"

(E) LVL 1 GARAGE

(E) LVL 1 STORAGE

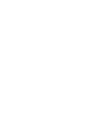(E) LVL 1 LIVING AREA

0


(E) DECK

EXISTING LOT COVERAGE		
Name	Area	
(E) DECK	109.65 SF	
(E) DECK STAIR	38.61 SF	
(F) EXTERIOR STAIR TO I VI 1	84 23 SF	

E) EXTERIOR STAIR TO LVL 1

(E) RESIDENCE FOOTPRINT

Name	Area
(E) DECK	109.65 SF
(E) DECK STAIR	38.61 SF
(E) EXTERIOR STAIR TO LVL 1	84.23 SF
(E) RESIDENCE FOOTPRINT	1393.86 SF

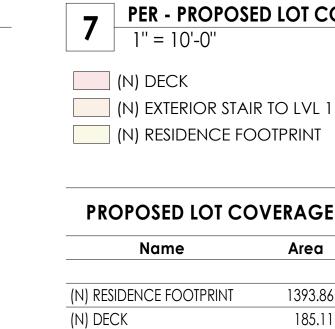

PROPOSED LOT COVERAGE		
Name	Area	
N) RESIDENCE FOOTPRINT	1393.86 SF	
	185 11 SE	


PROPOSED LOT COVERAGE		
Name	Area	
N) RESIDENCE FOOTPRINT	1393.86 SF	
N) DECK	185.11 SF	
	01.05.05	

Name	Area	
(N) RESIDENCE FOOTPRINT	1393.86 SF	
(N) DECK	185.11 SF	
(N) EXTERIOR STAIR TO LVL 1	91.85 SF	

OSED LOT COVERAGE		
Name Area		
NCE FOOTPRINT	1393.86 SF	
	185.11 SF	

PER - PROPOSED LOT COVERAGE

FLOOR AREA R	ATIO

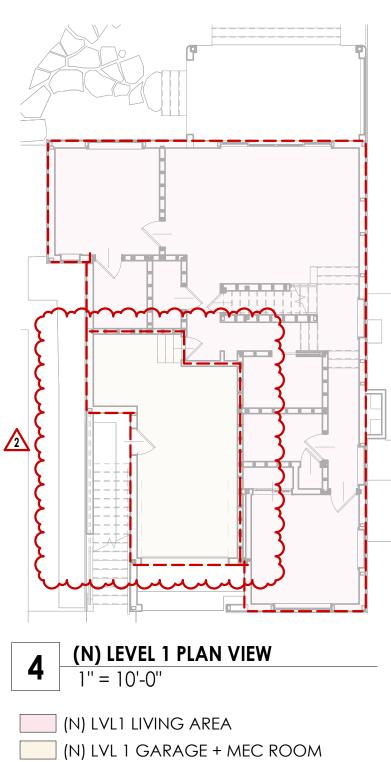

LOT COVERAGE


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EXISTING LOT COVERAGE

1'' = 10'-0''


(E) DECK STAIR



ACCESSOR'S MAP 1/8" = 1'-0"

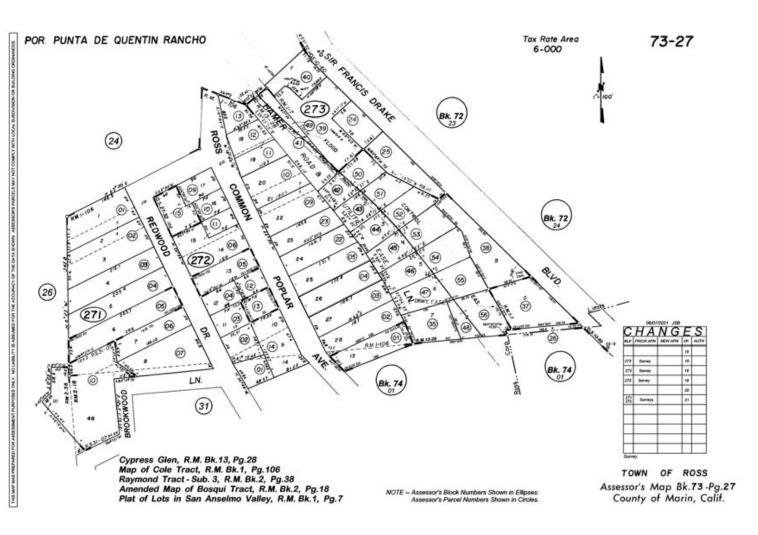

VICINITY MAP 1'' = 40'-0''

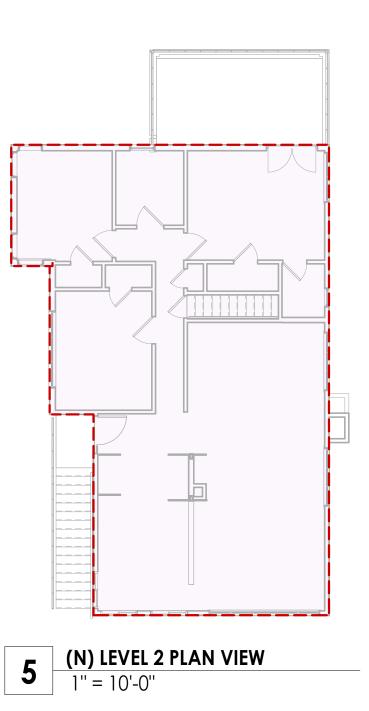

(N) LVL 2 LIVING AREA



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Rev	Description	Date
41 Popla Remode	ar Kitcher əl	1
Date:		02/03/23

1 CITY COMMENTS REV 1 01/11/23


03/02/23

2 TOWN COUNCIL


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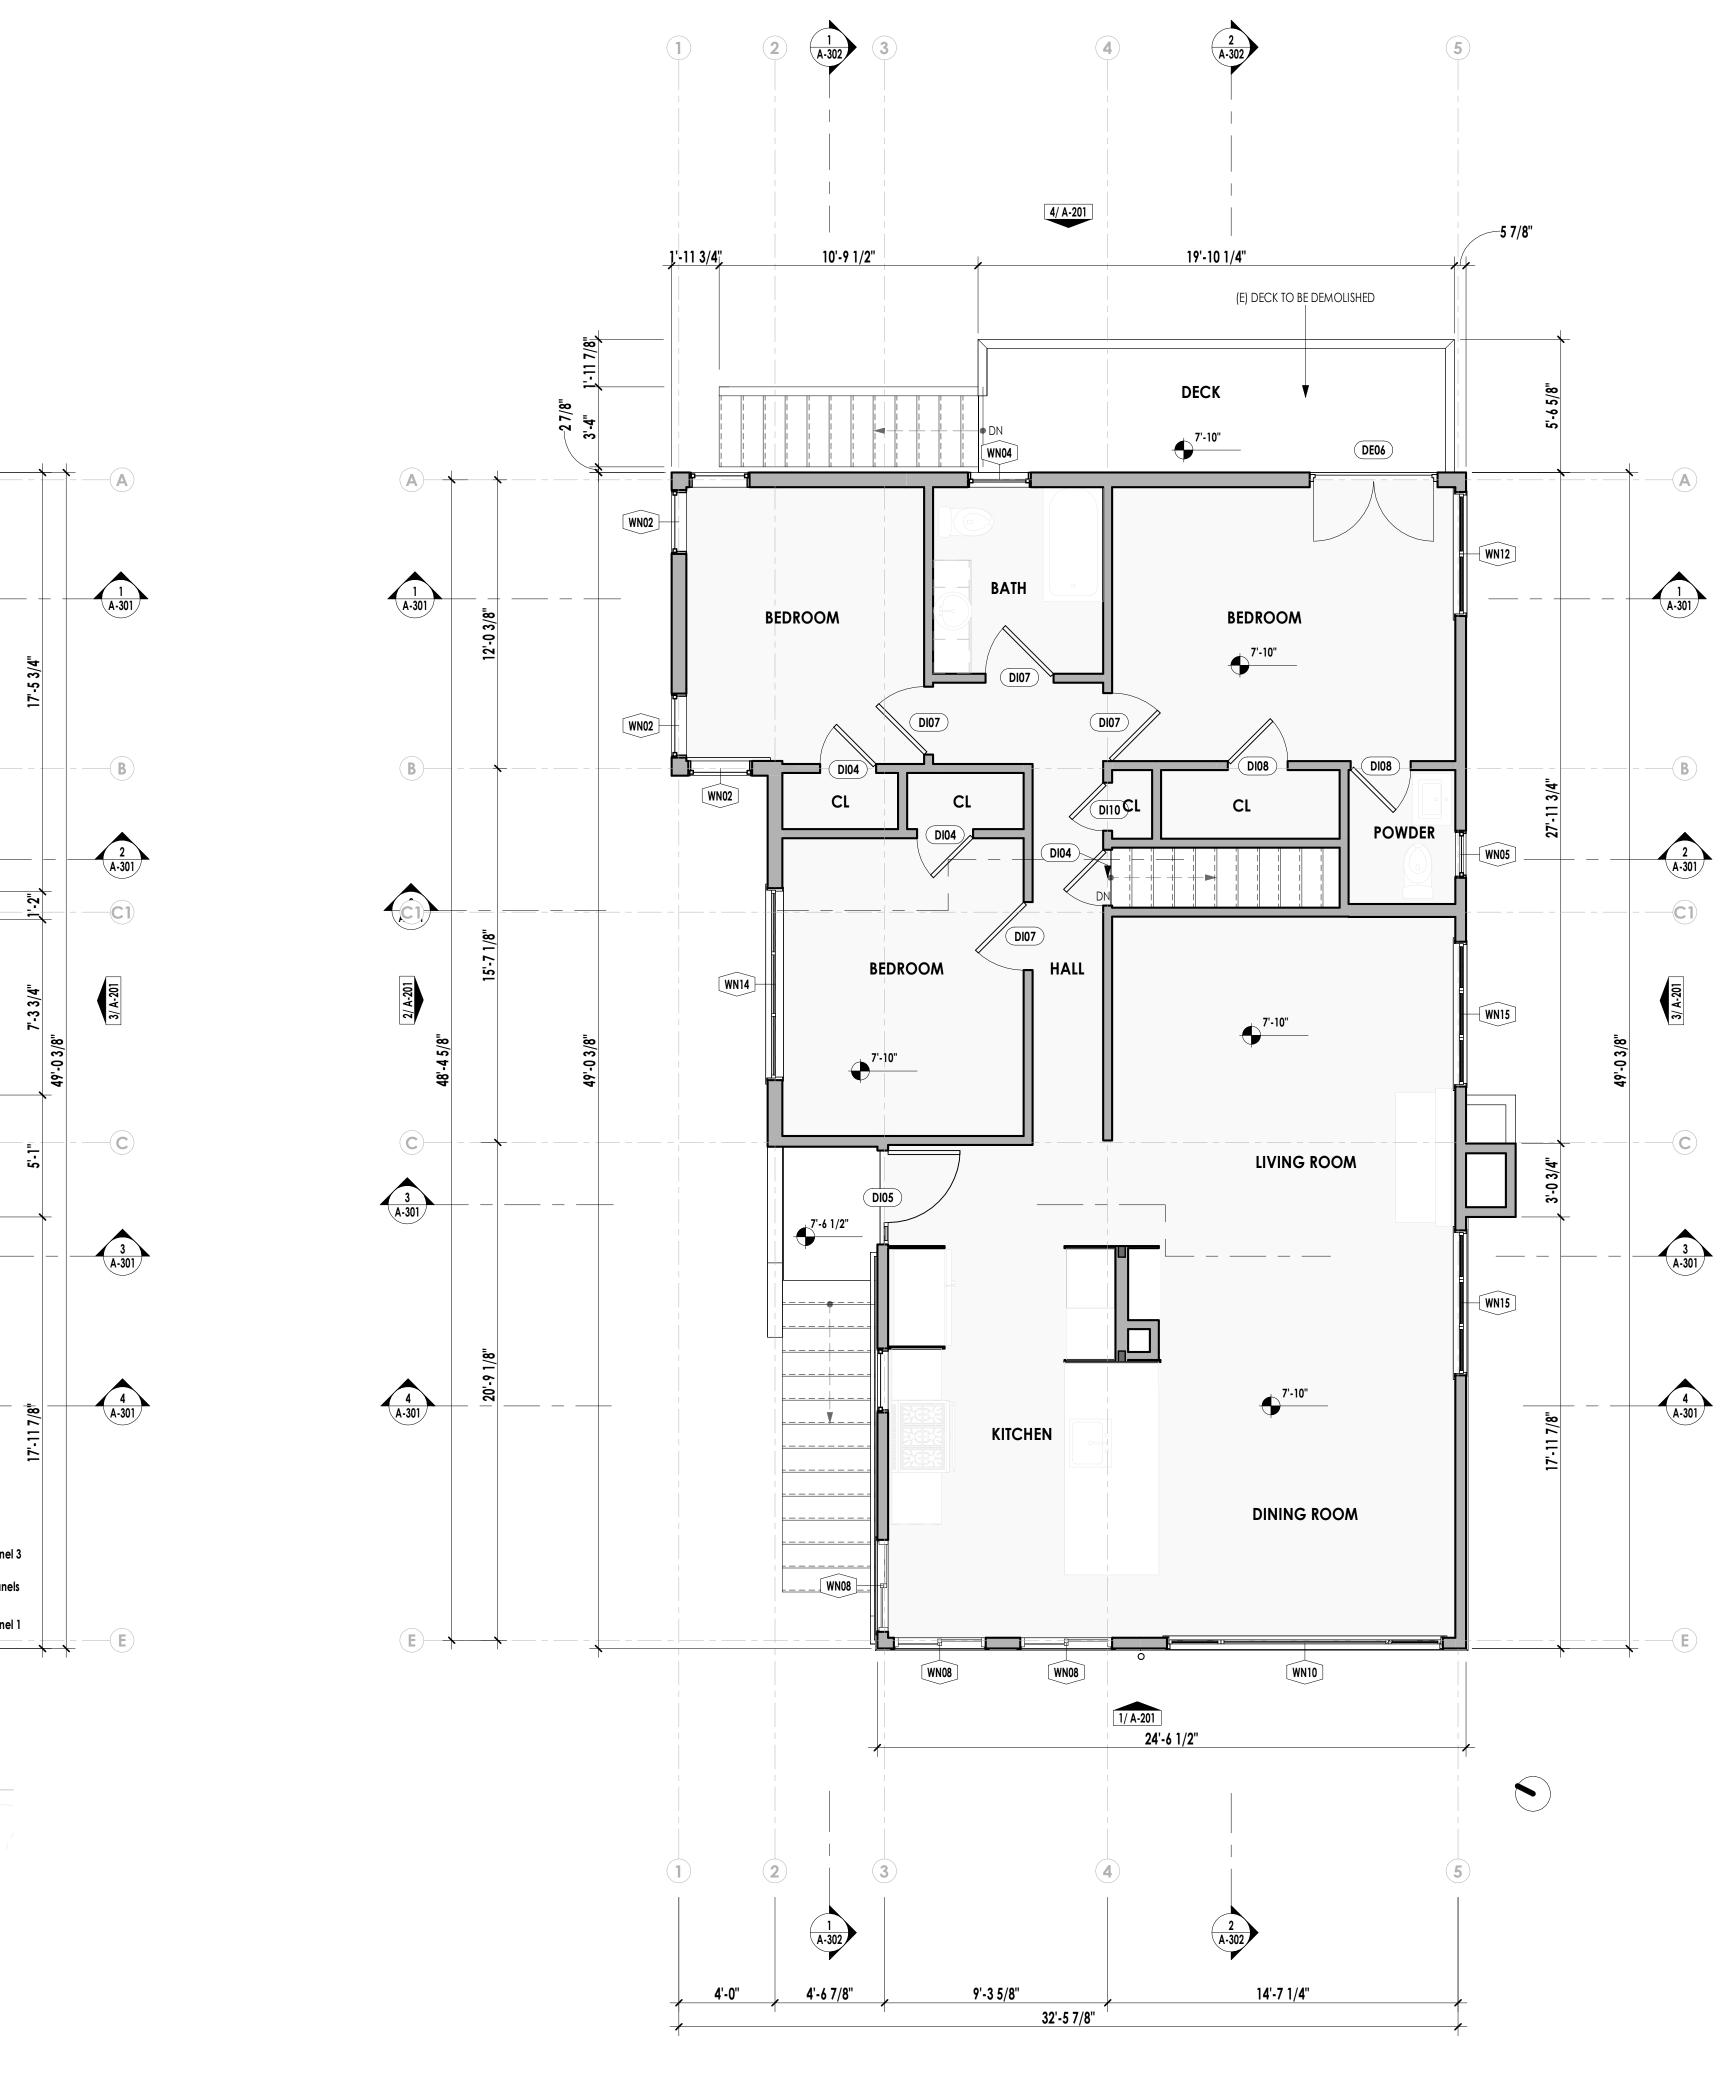
SITE PLANS AND AREA CALCS

PROPOSED GROSS BUILDING AREA



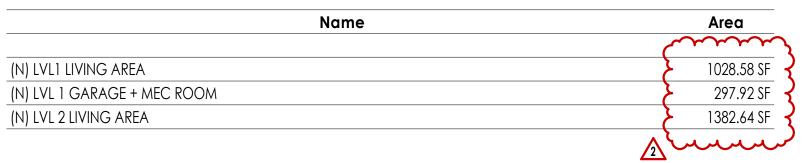



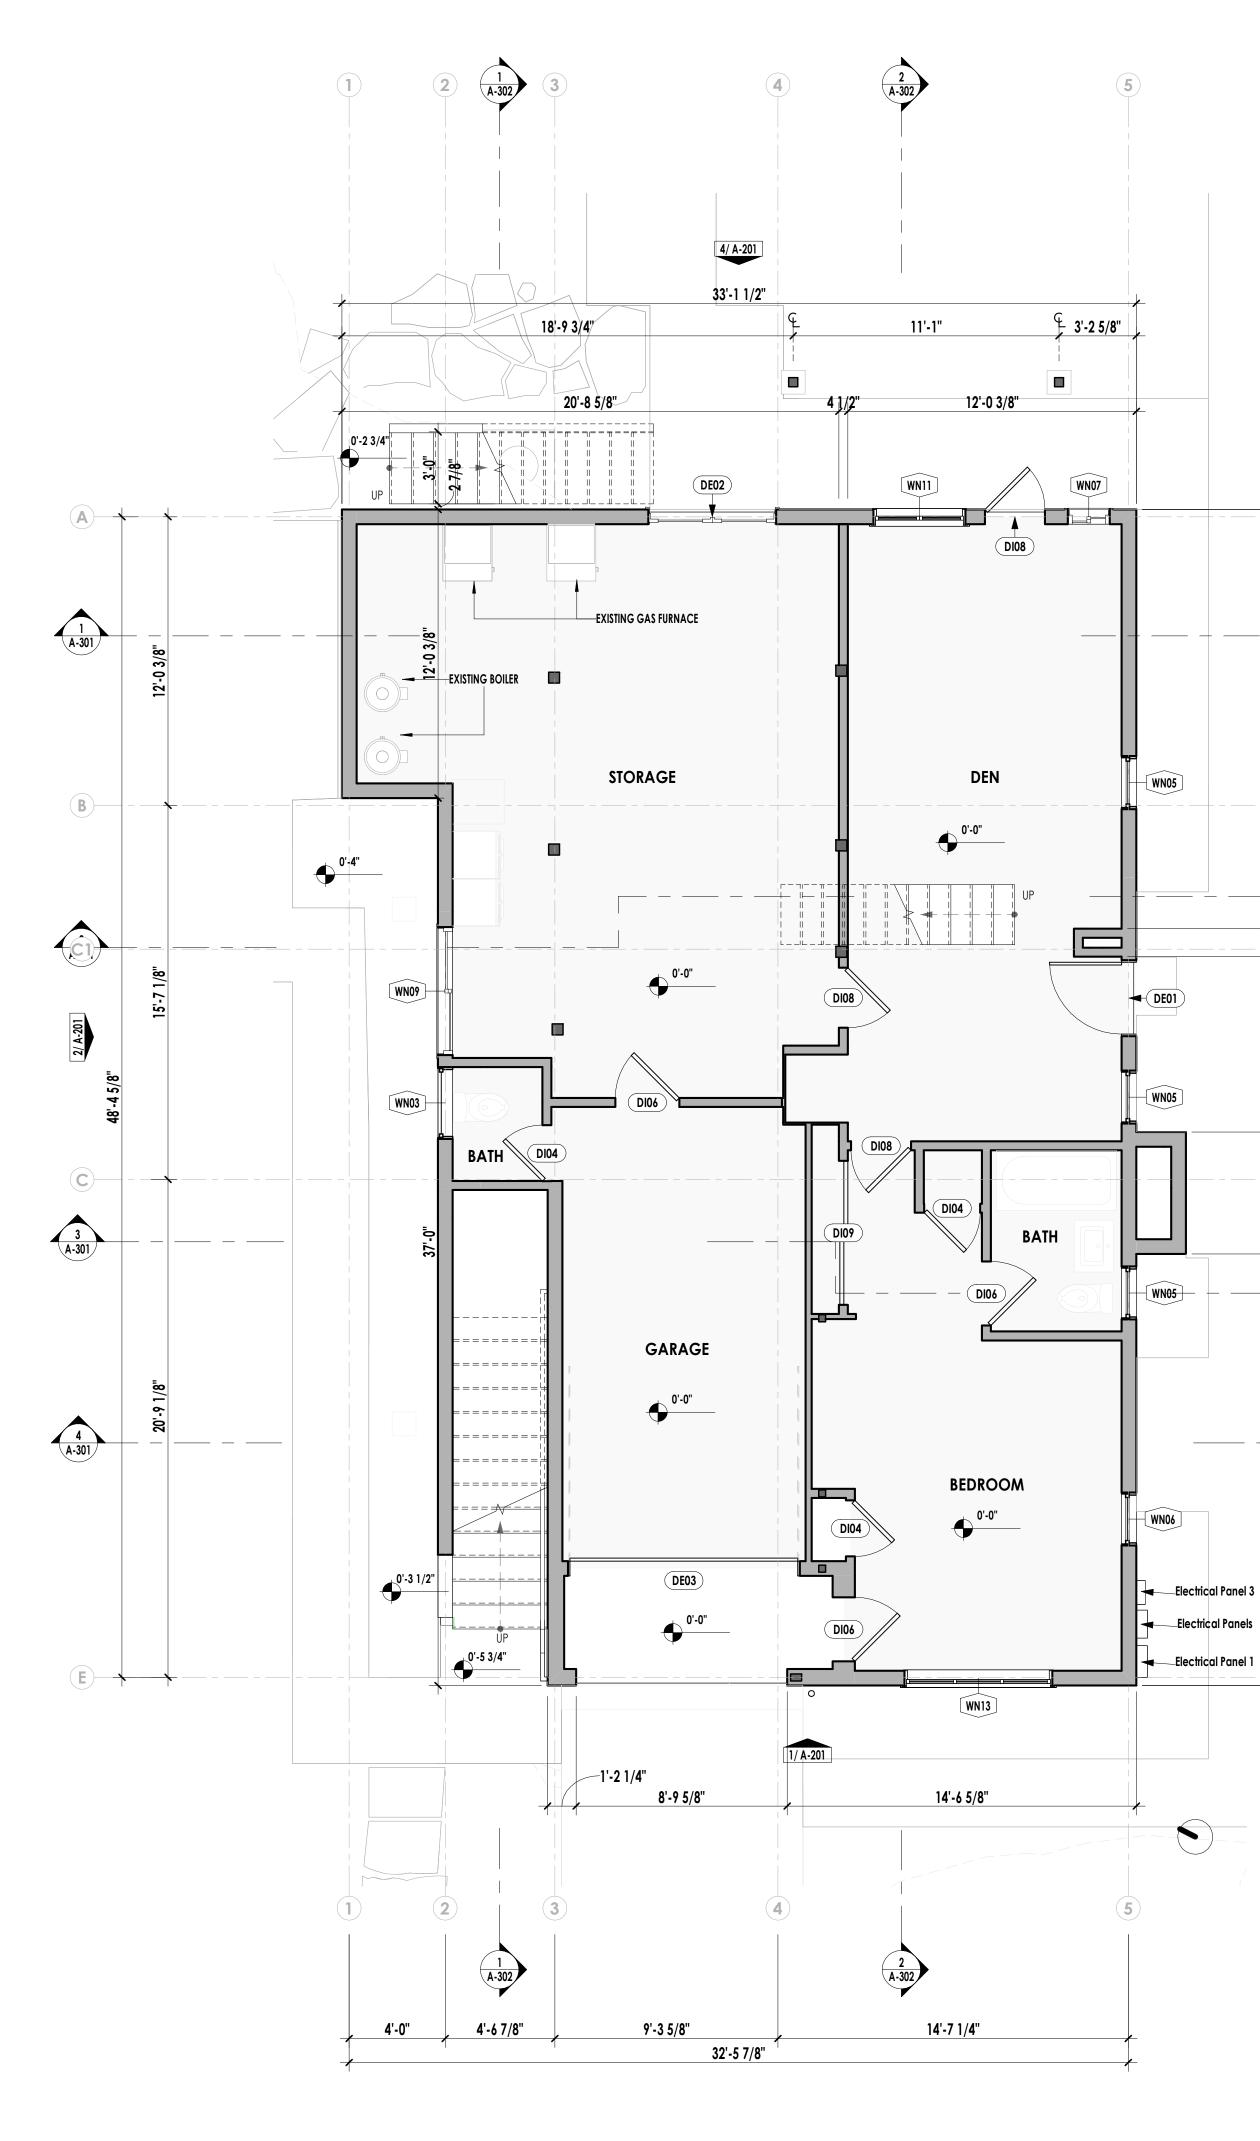

(E) LEVEL 2 FLOOR PLAN 1/4" = 1'-0"

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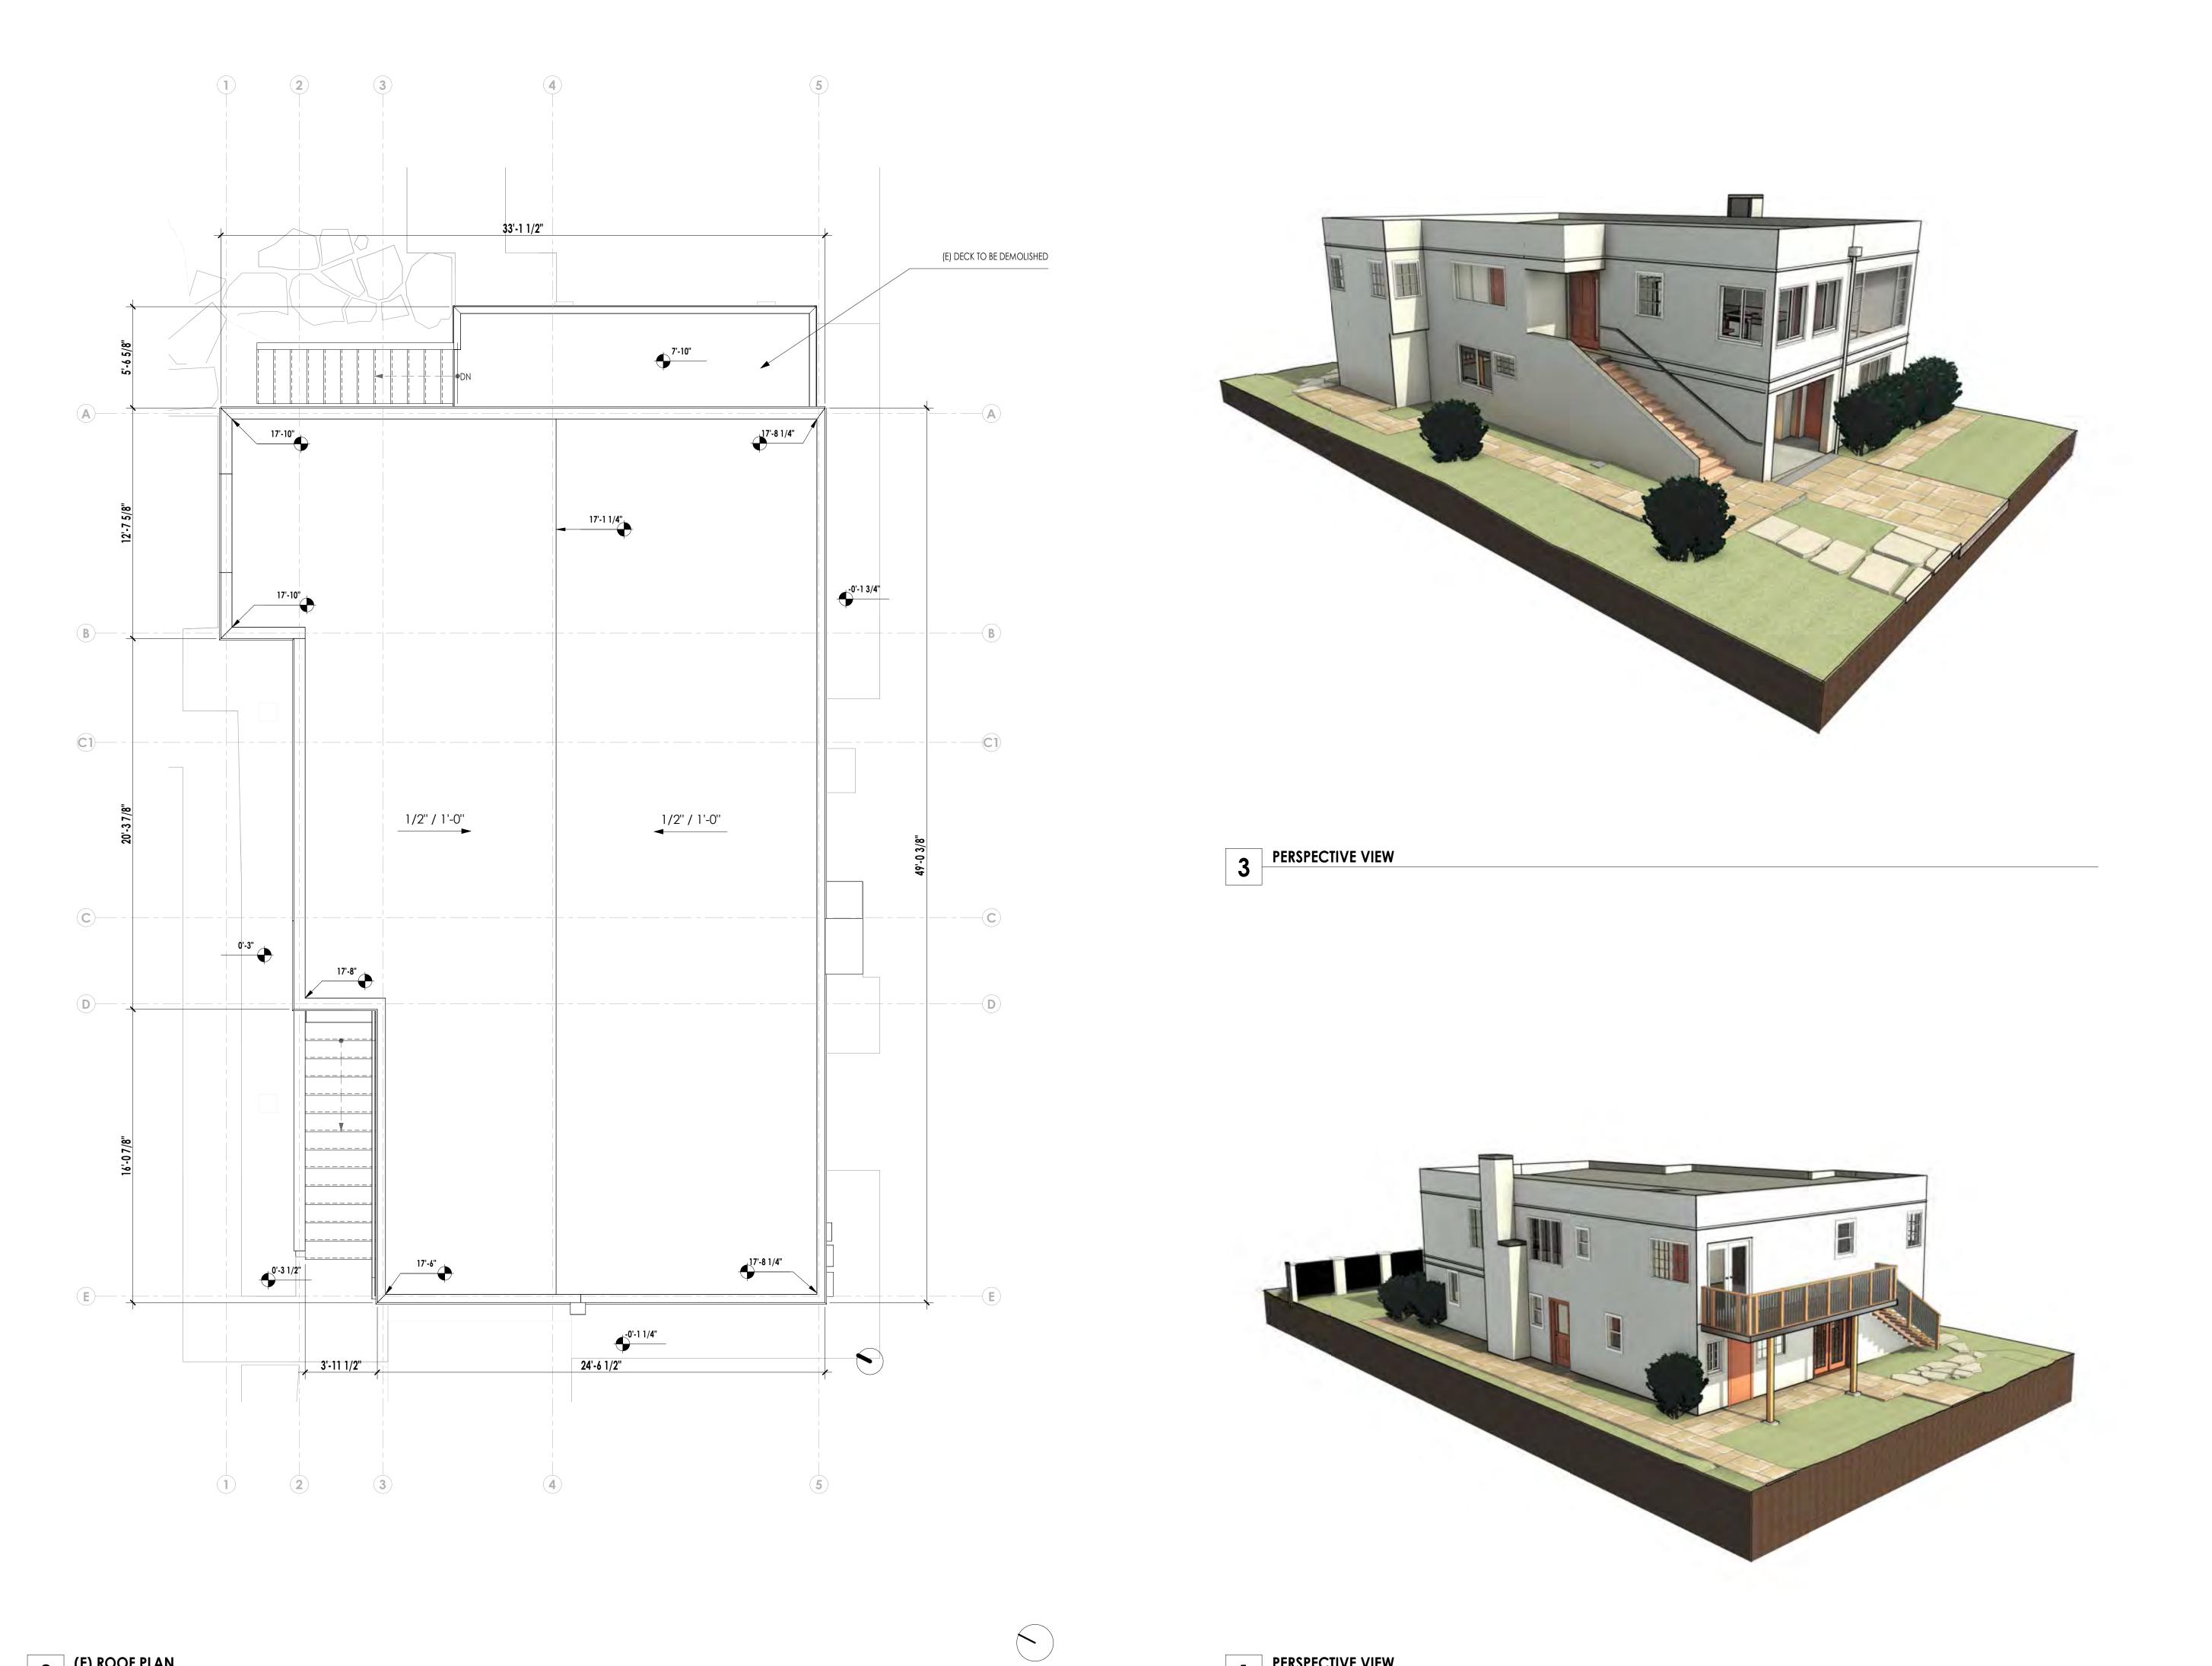
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2TOWN COUNCIL03/02/231CITY COMMENTS REV 101/11/23RevDescriptionDate

41 Poplar Kitchen Remodel

Date: 02/03/23 Scale: As Noted Sheet Title

(E) LEVEL 1 AND LEVEL 2 FLOOR PLANS



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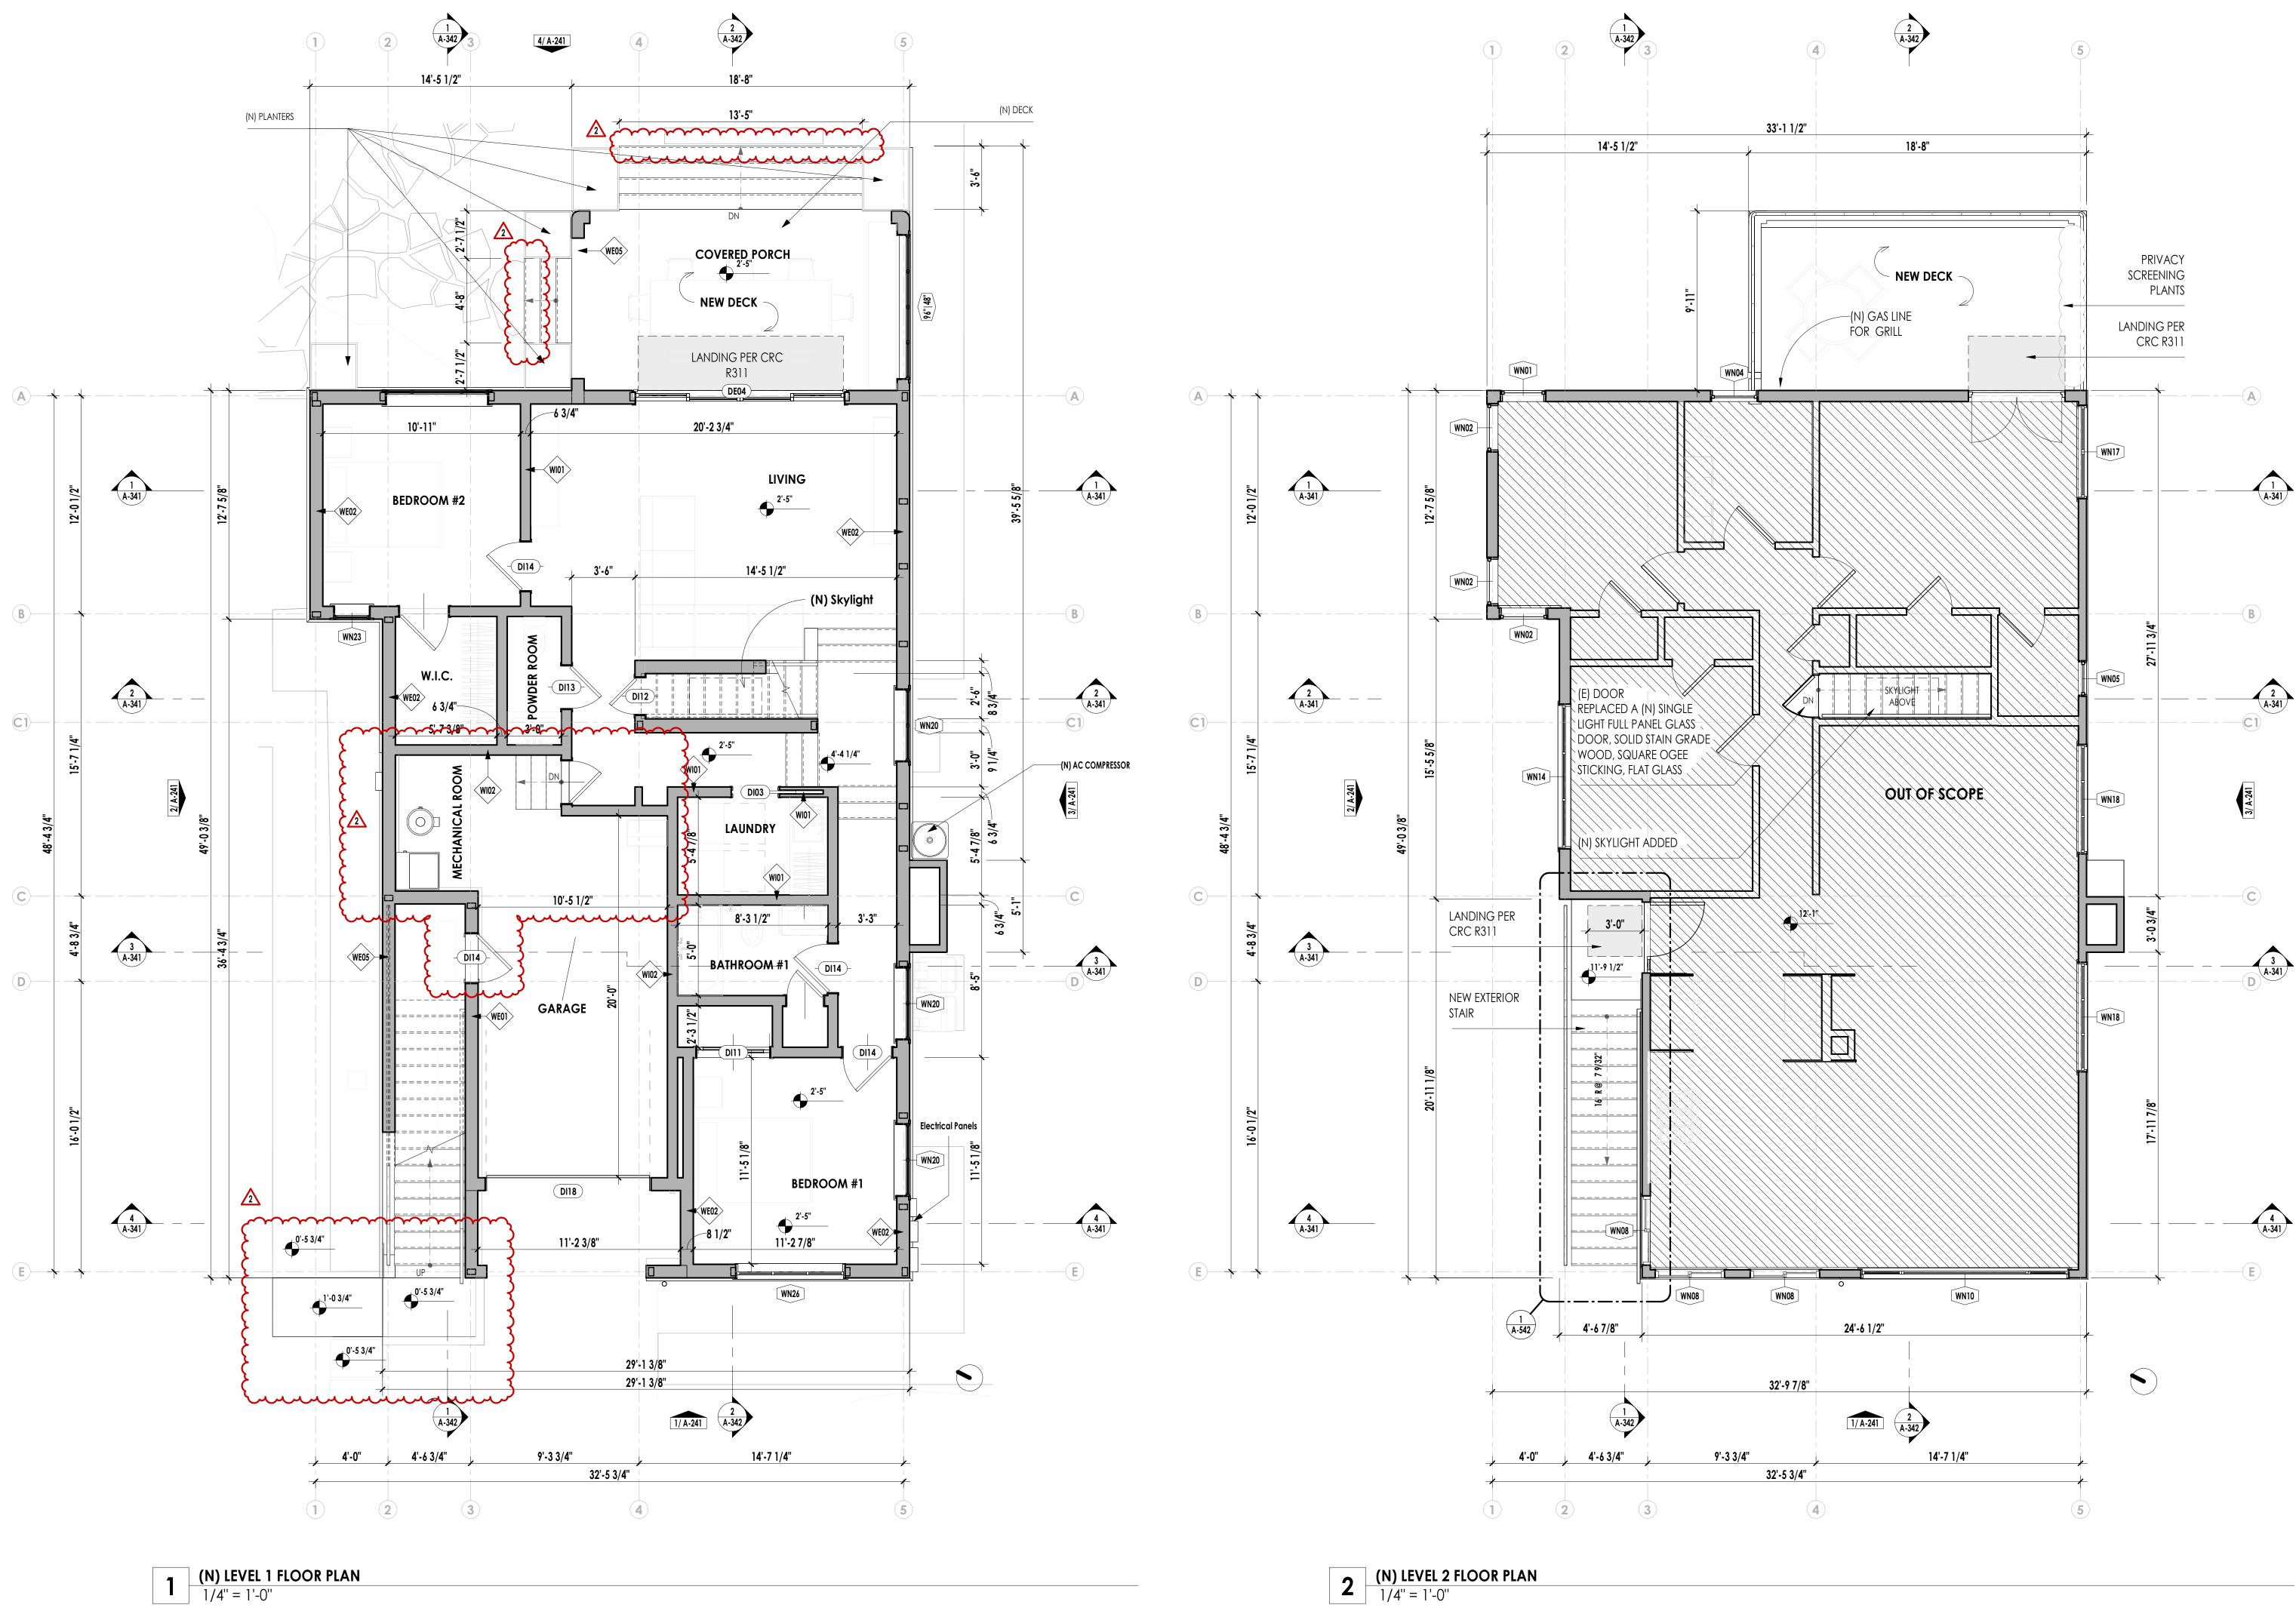
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41 Poplar Kitchen Remodel

02/03/23 Date: Scale: As Noted Sheet Title

(E) ROOF PLAN AND AXO VIEW



(N) LEVEL 1 FLOOR PLAN 1/4" = 1'-0"

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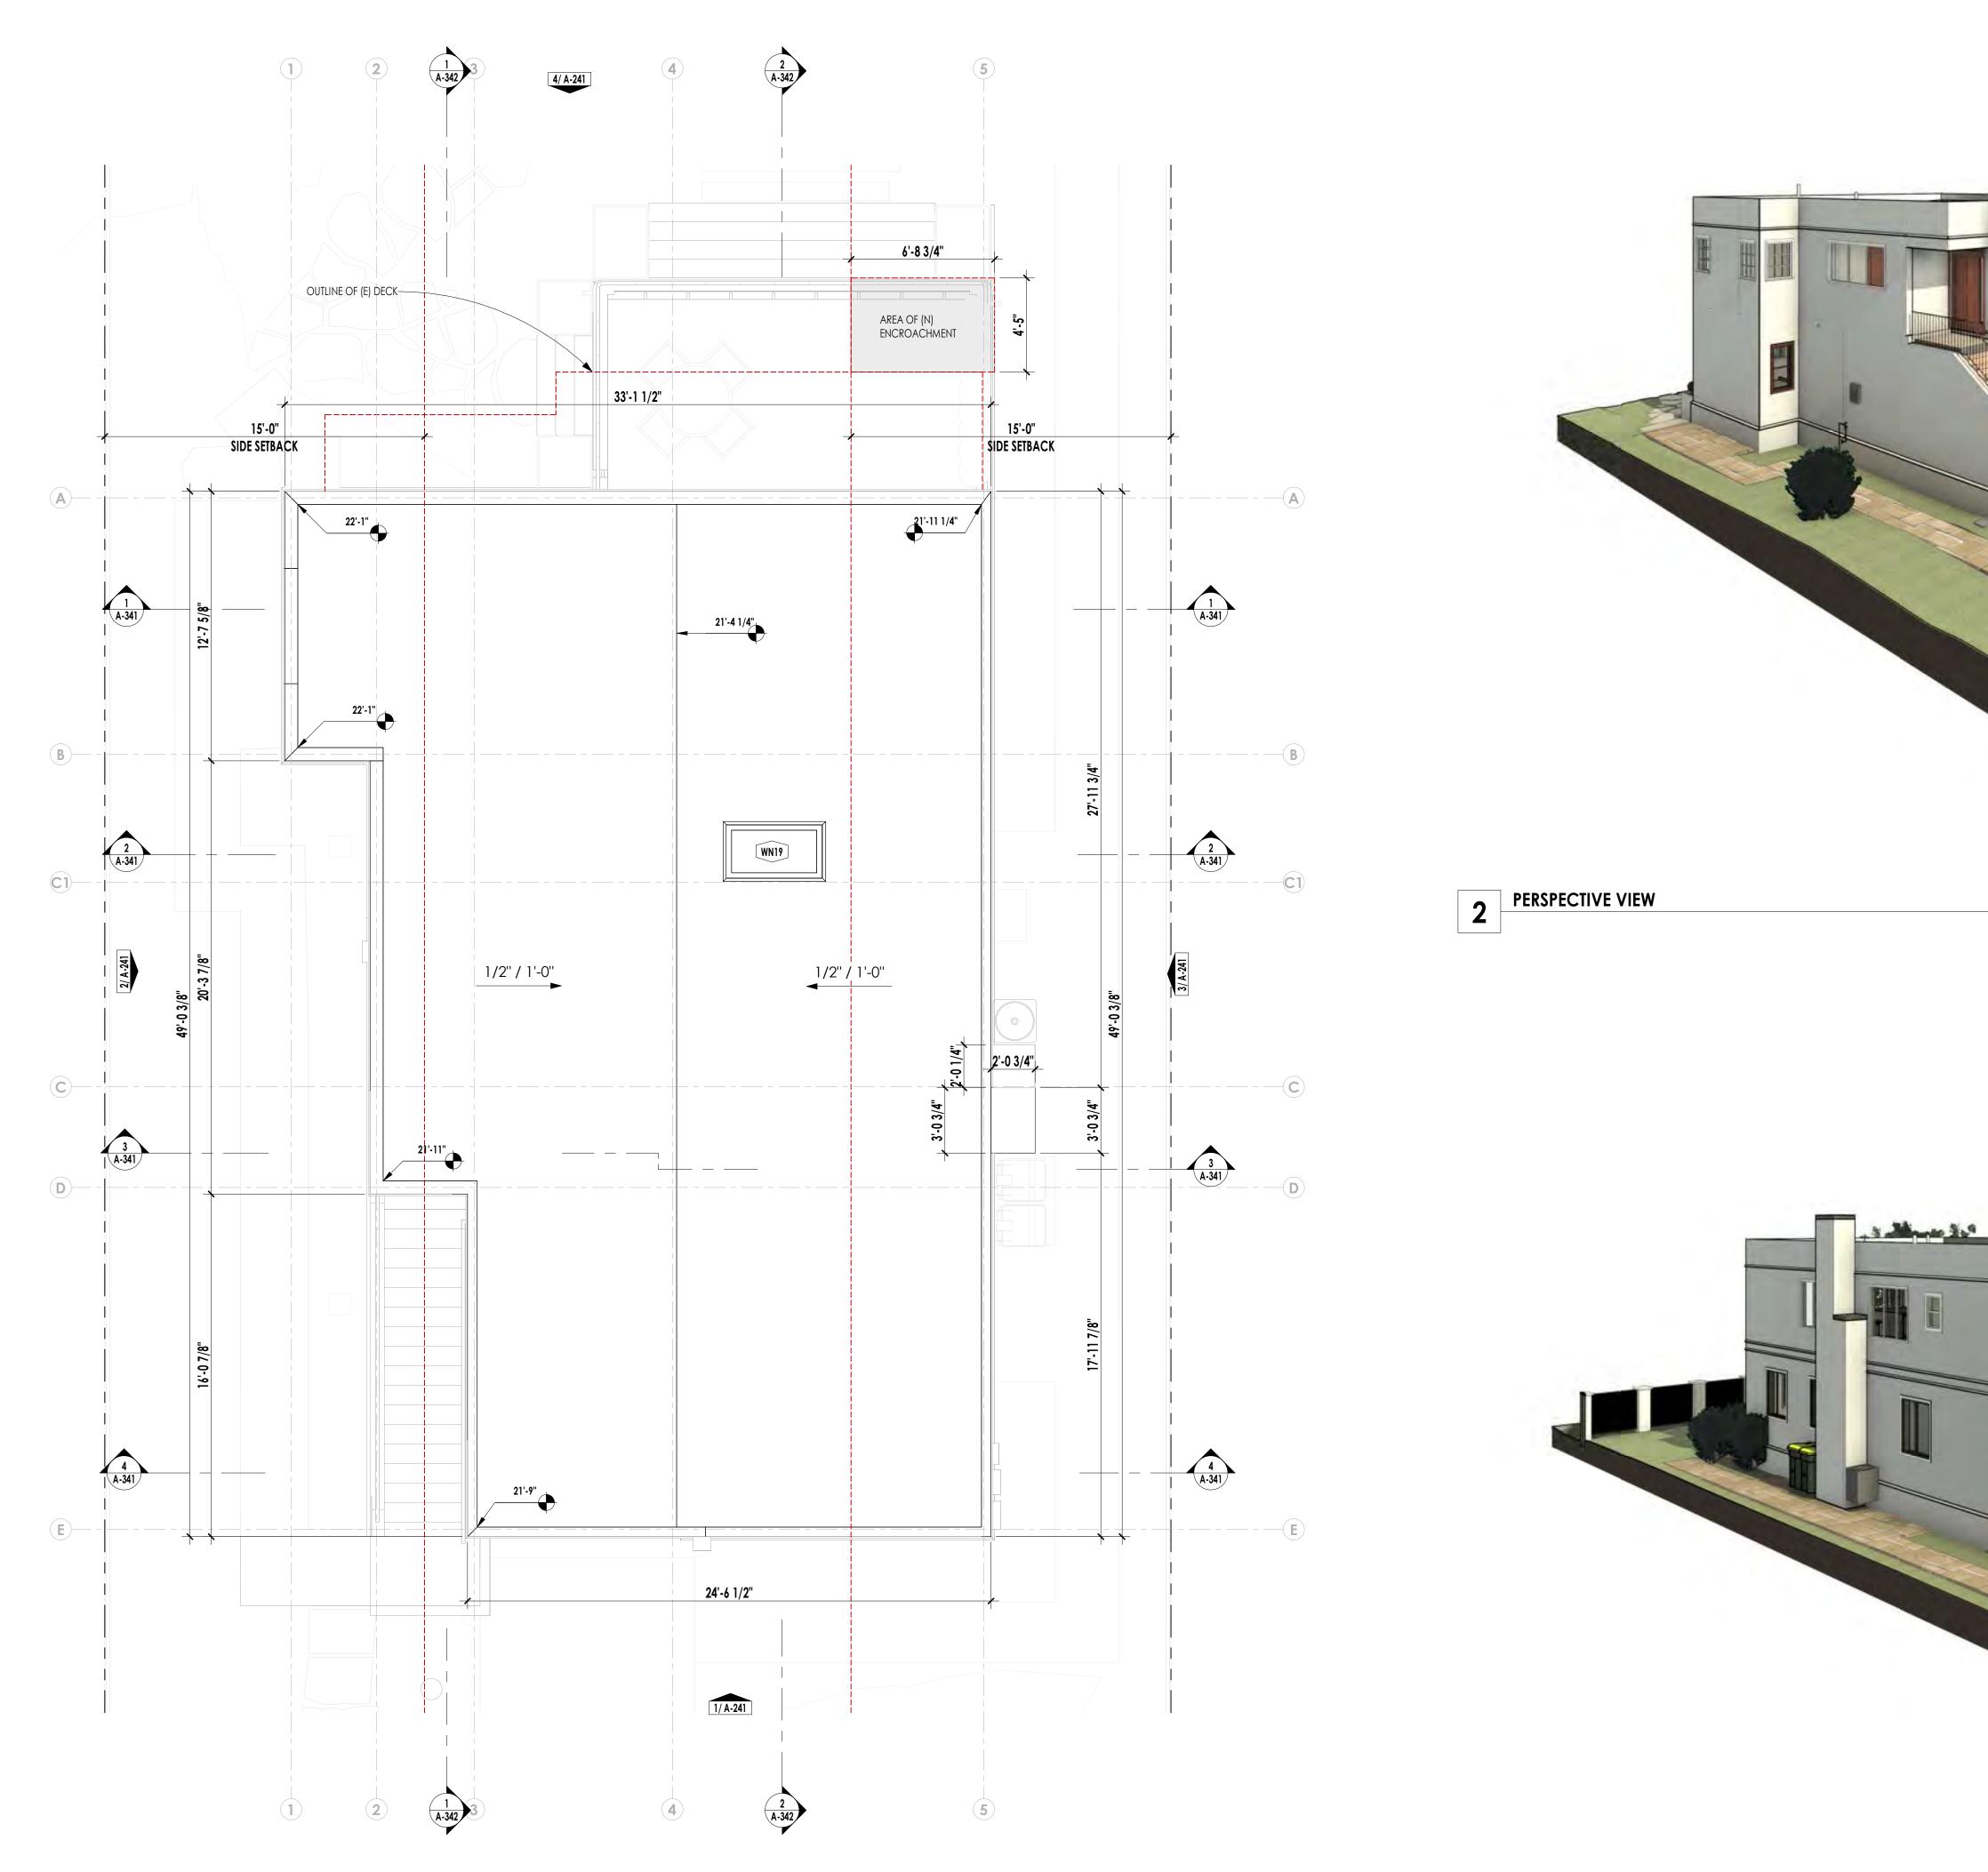
Rev	Description	Date
1	CITY COMMENTS REV 1	01/11/23
2	TOWN COUNCIL	03/02/23

41 Poplar Kitchen Remodel

Sheet Title

Date:	02/03/23
Scale:	As Noted

(N) LEVEL 1 AND LEVEL 2 FLOOR PLANS



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2 TOWN COUNCIL 03/02/23 1 CITY COMMENTS REV 1 01/11/23




41 Poplar Kitchen Remodel

Date:	02/03/23
Scale:	As Noted
Sheet Title	


(N) ROOF PLAN AND AXO VIEW





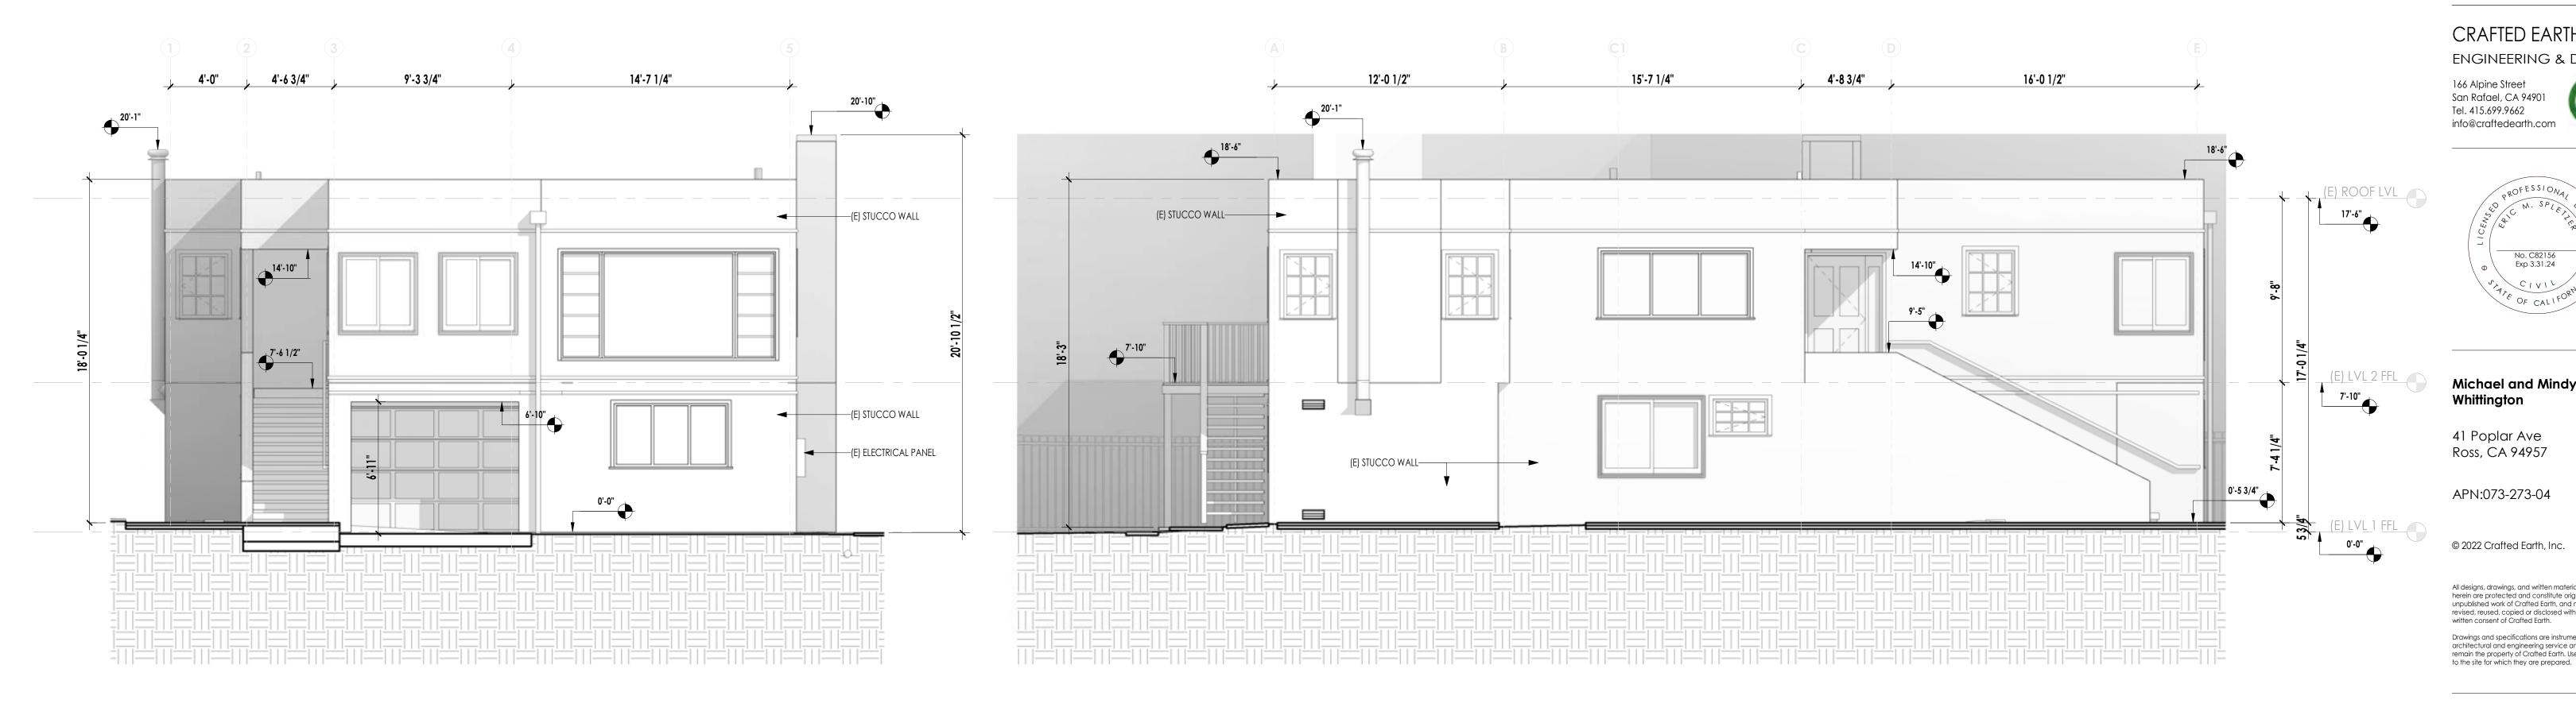



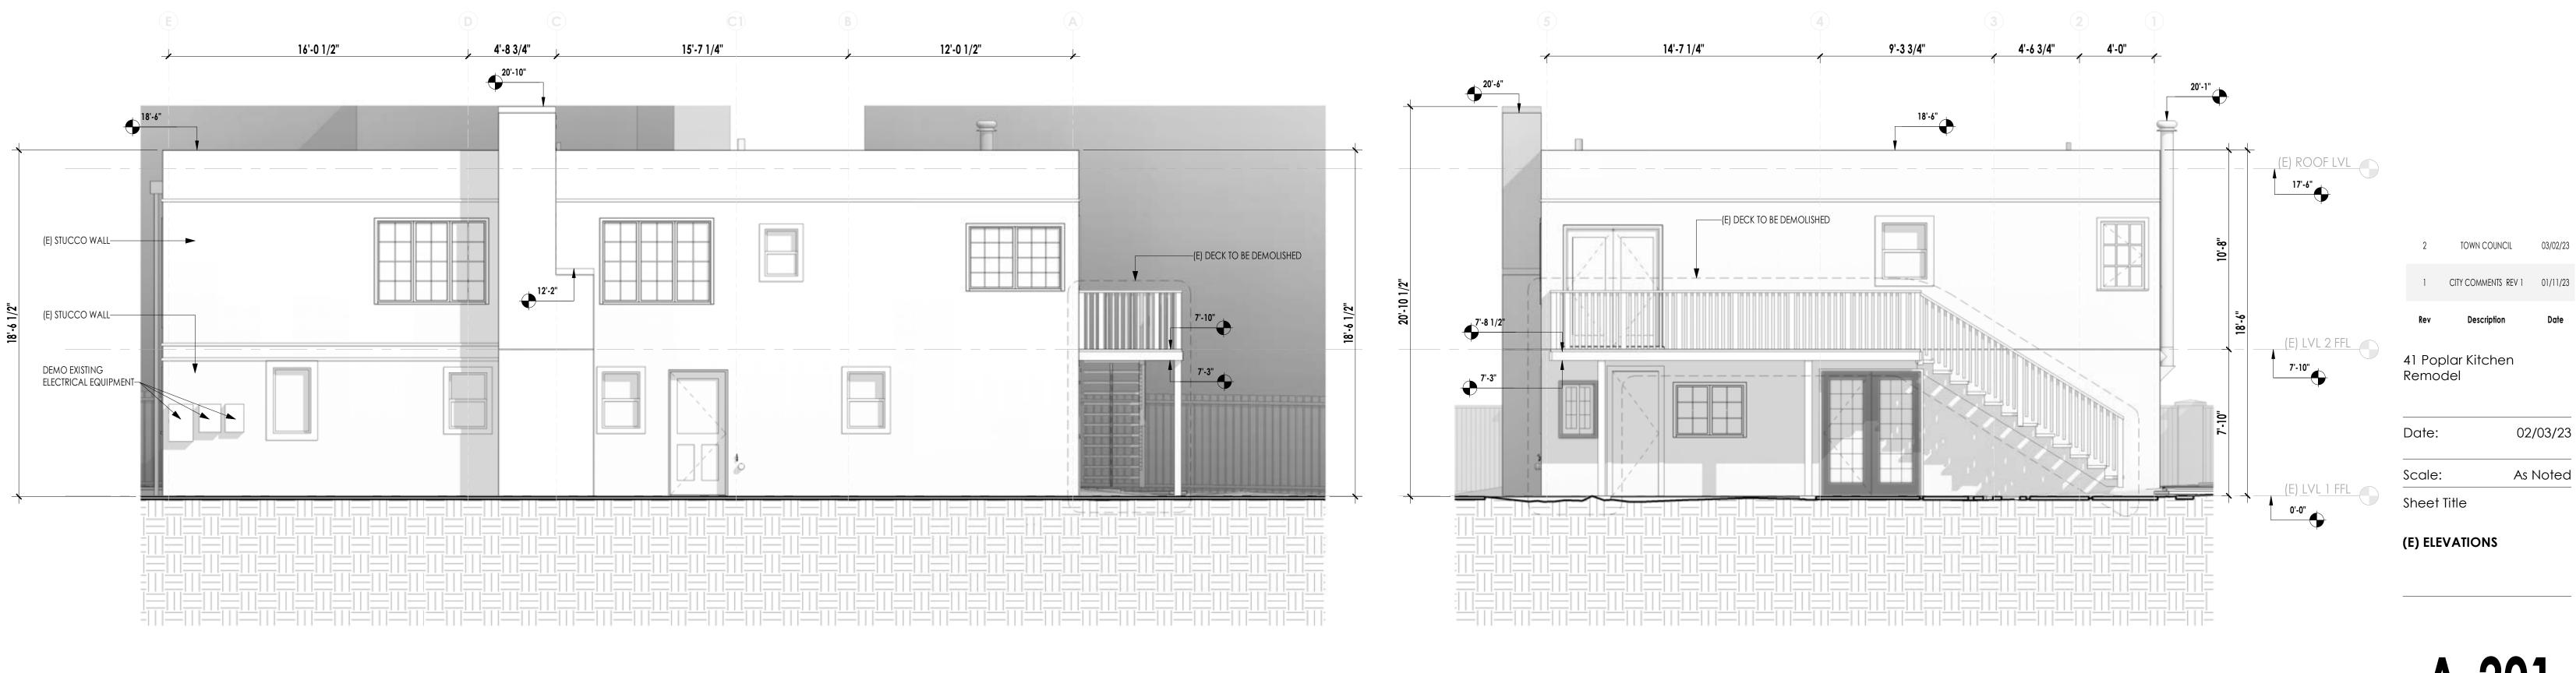


2 EXISTING WEST ELEVATION 1/4" = 1'-0"





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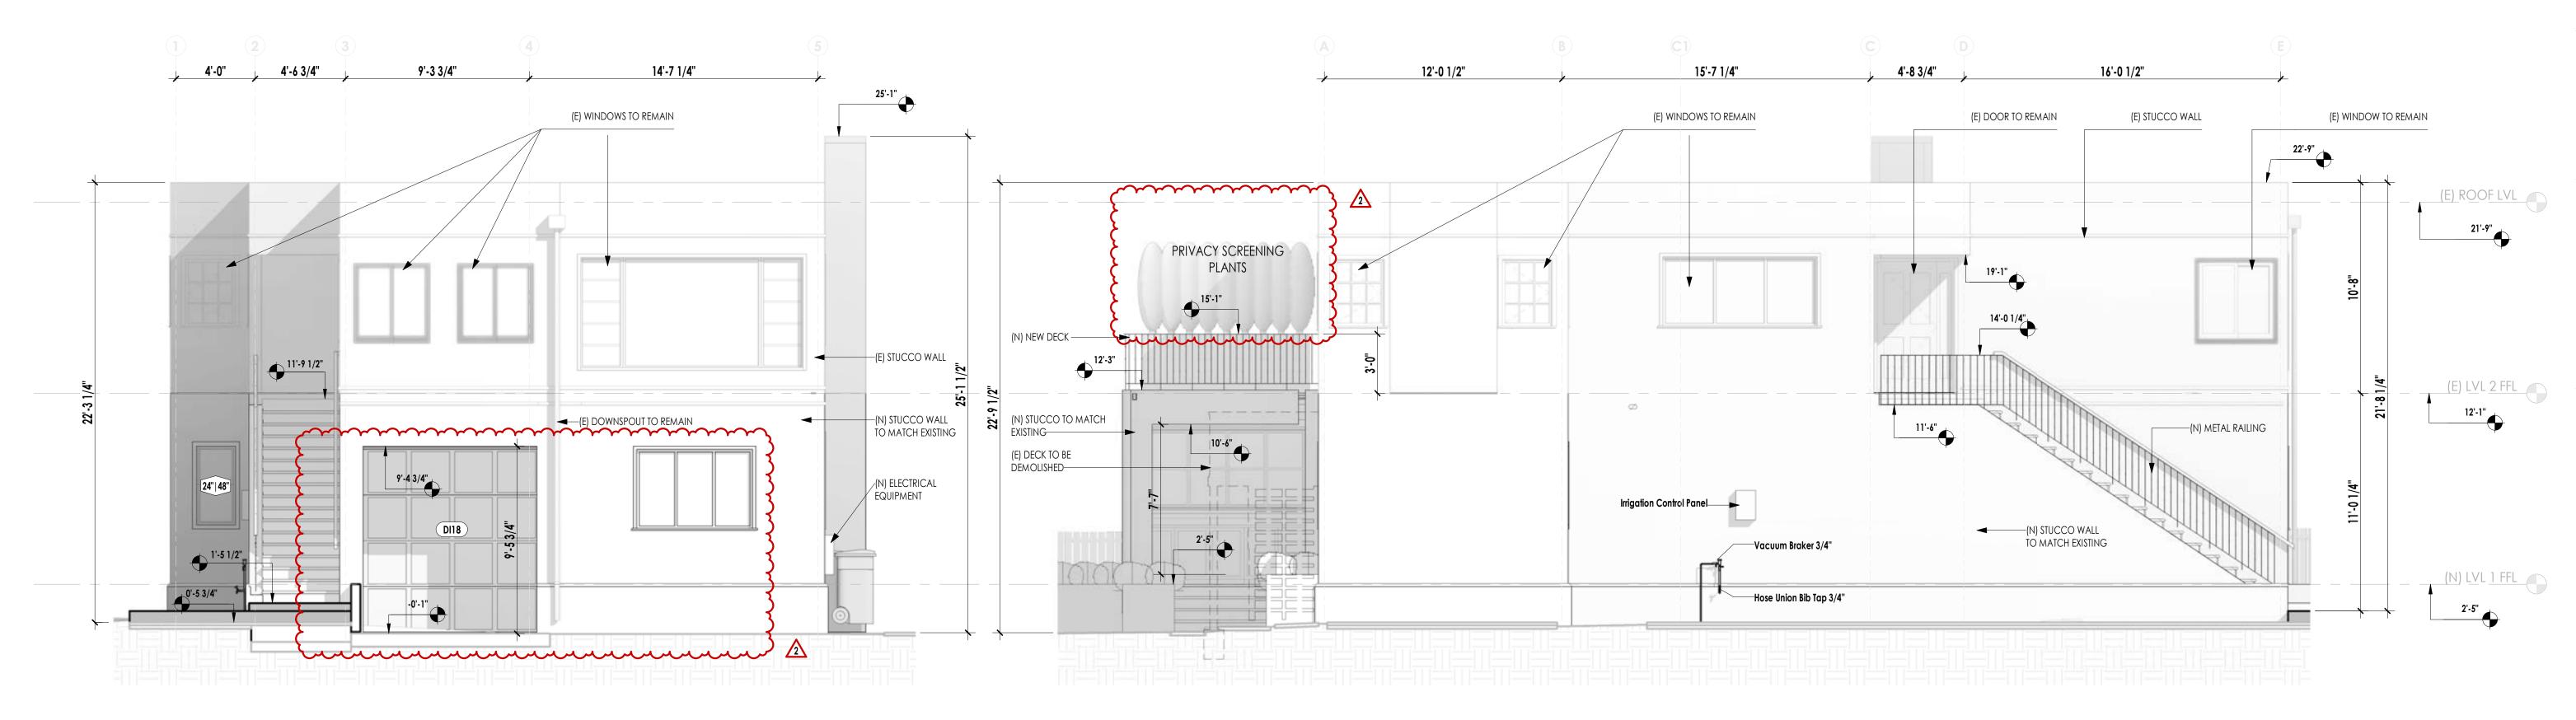
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APN:073-273-04


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PROPOSED SOUTH ELEVATION 1/4" = 1'-0"

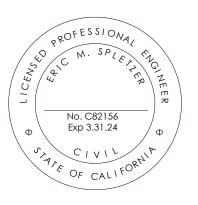

2 PROPOSED WEST ELEVATION 1/4" = 1'-0"

4 PROPOSED REAR ELEVATION 1/4" = 1'-0"

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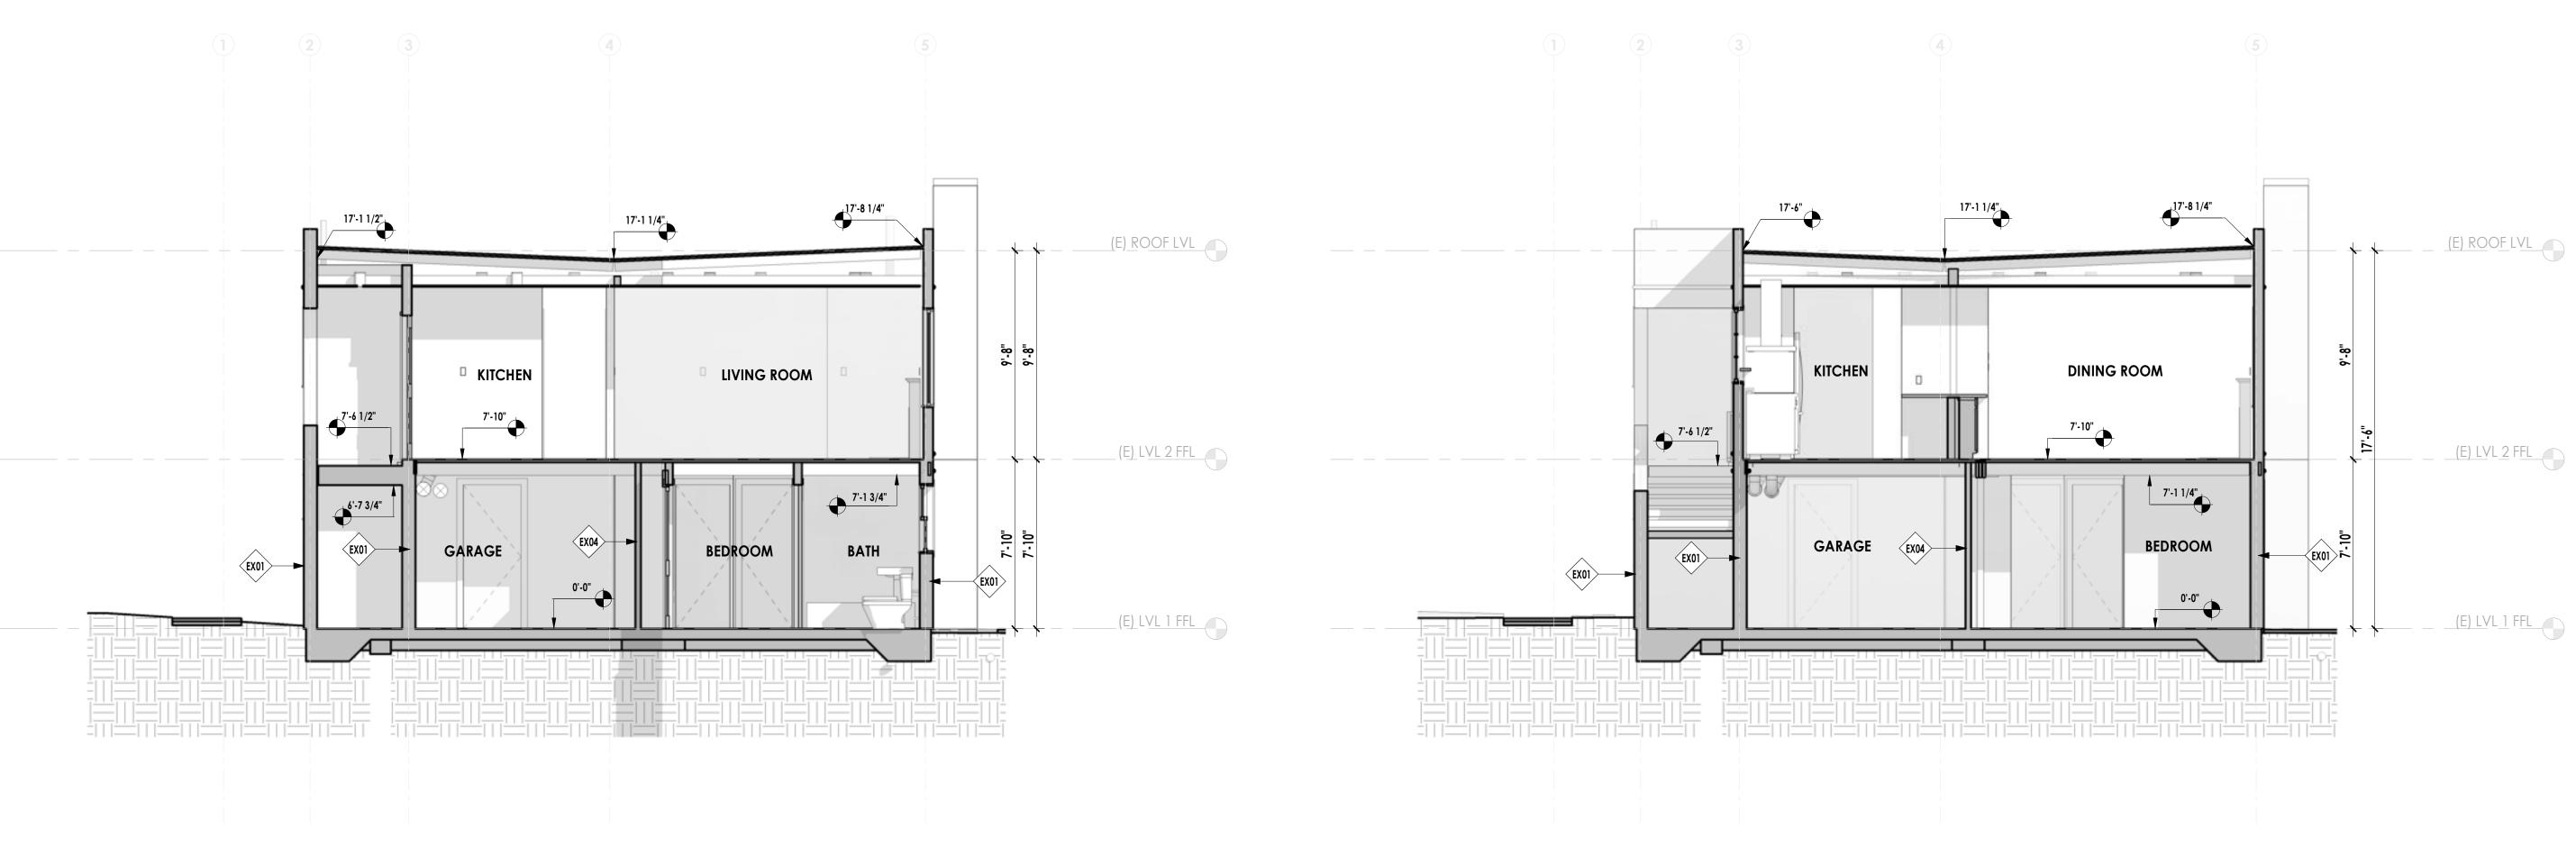
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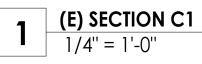
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	1	CITY COMMENTS REV	/1	01/11/23
	Rev	Description		Date
41 Poplar Kitchen Remodel				
Do	ate:		02/0	03/23

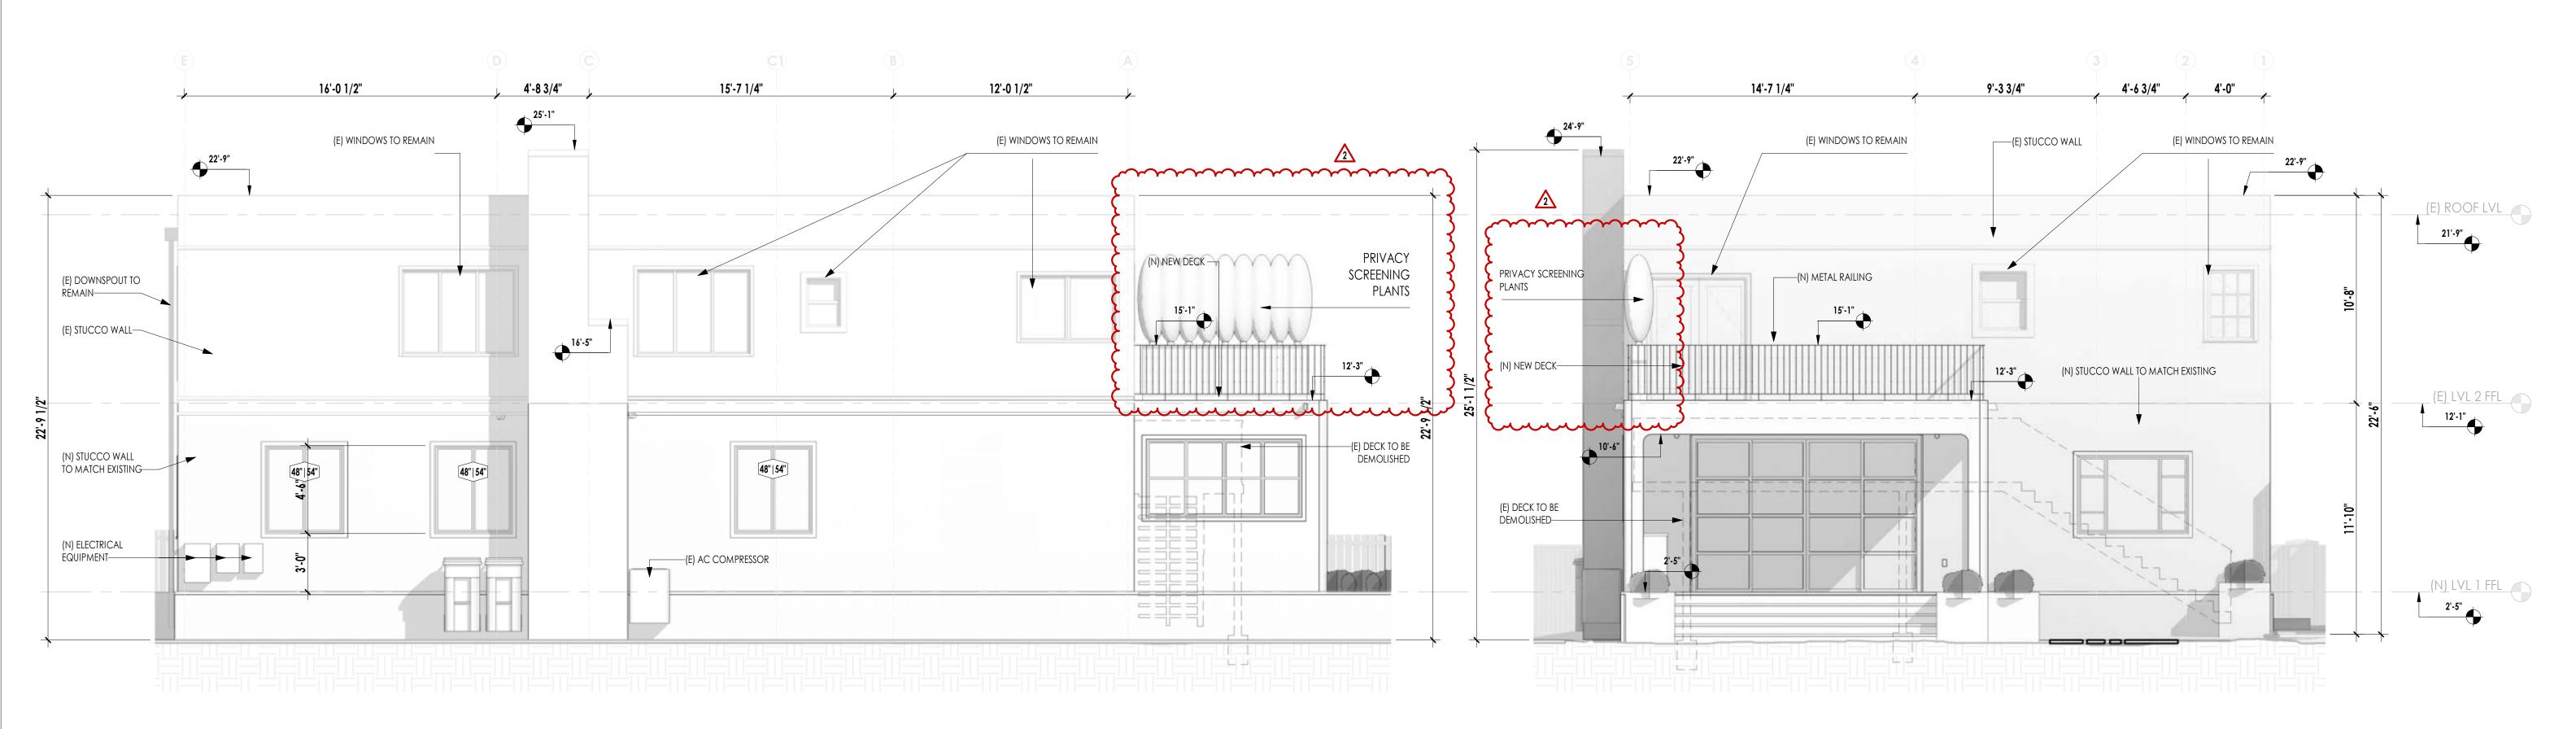
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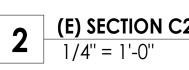
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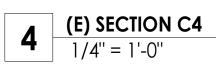











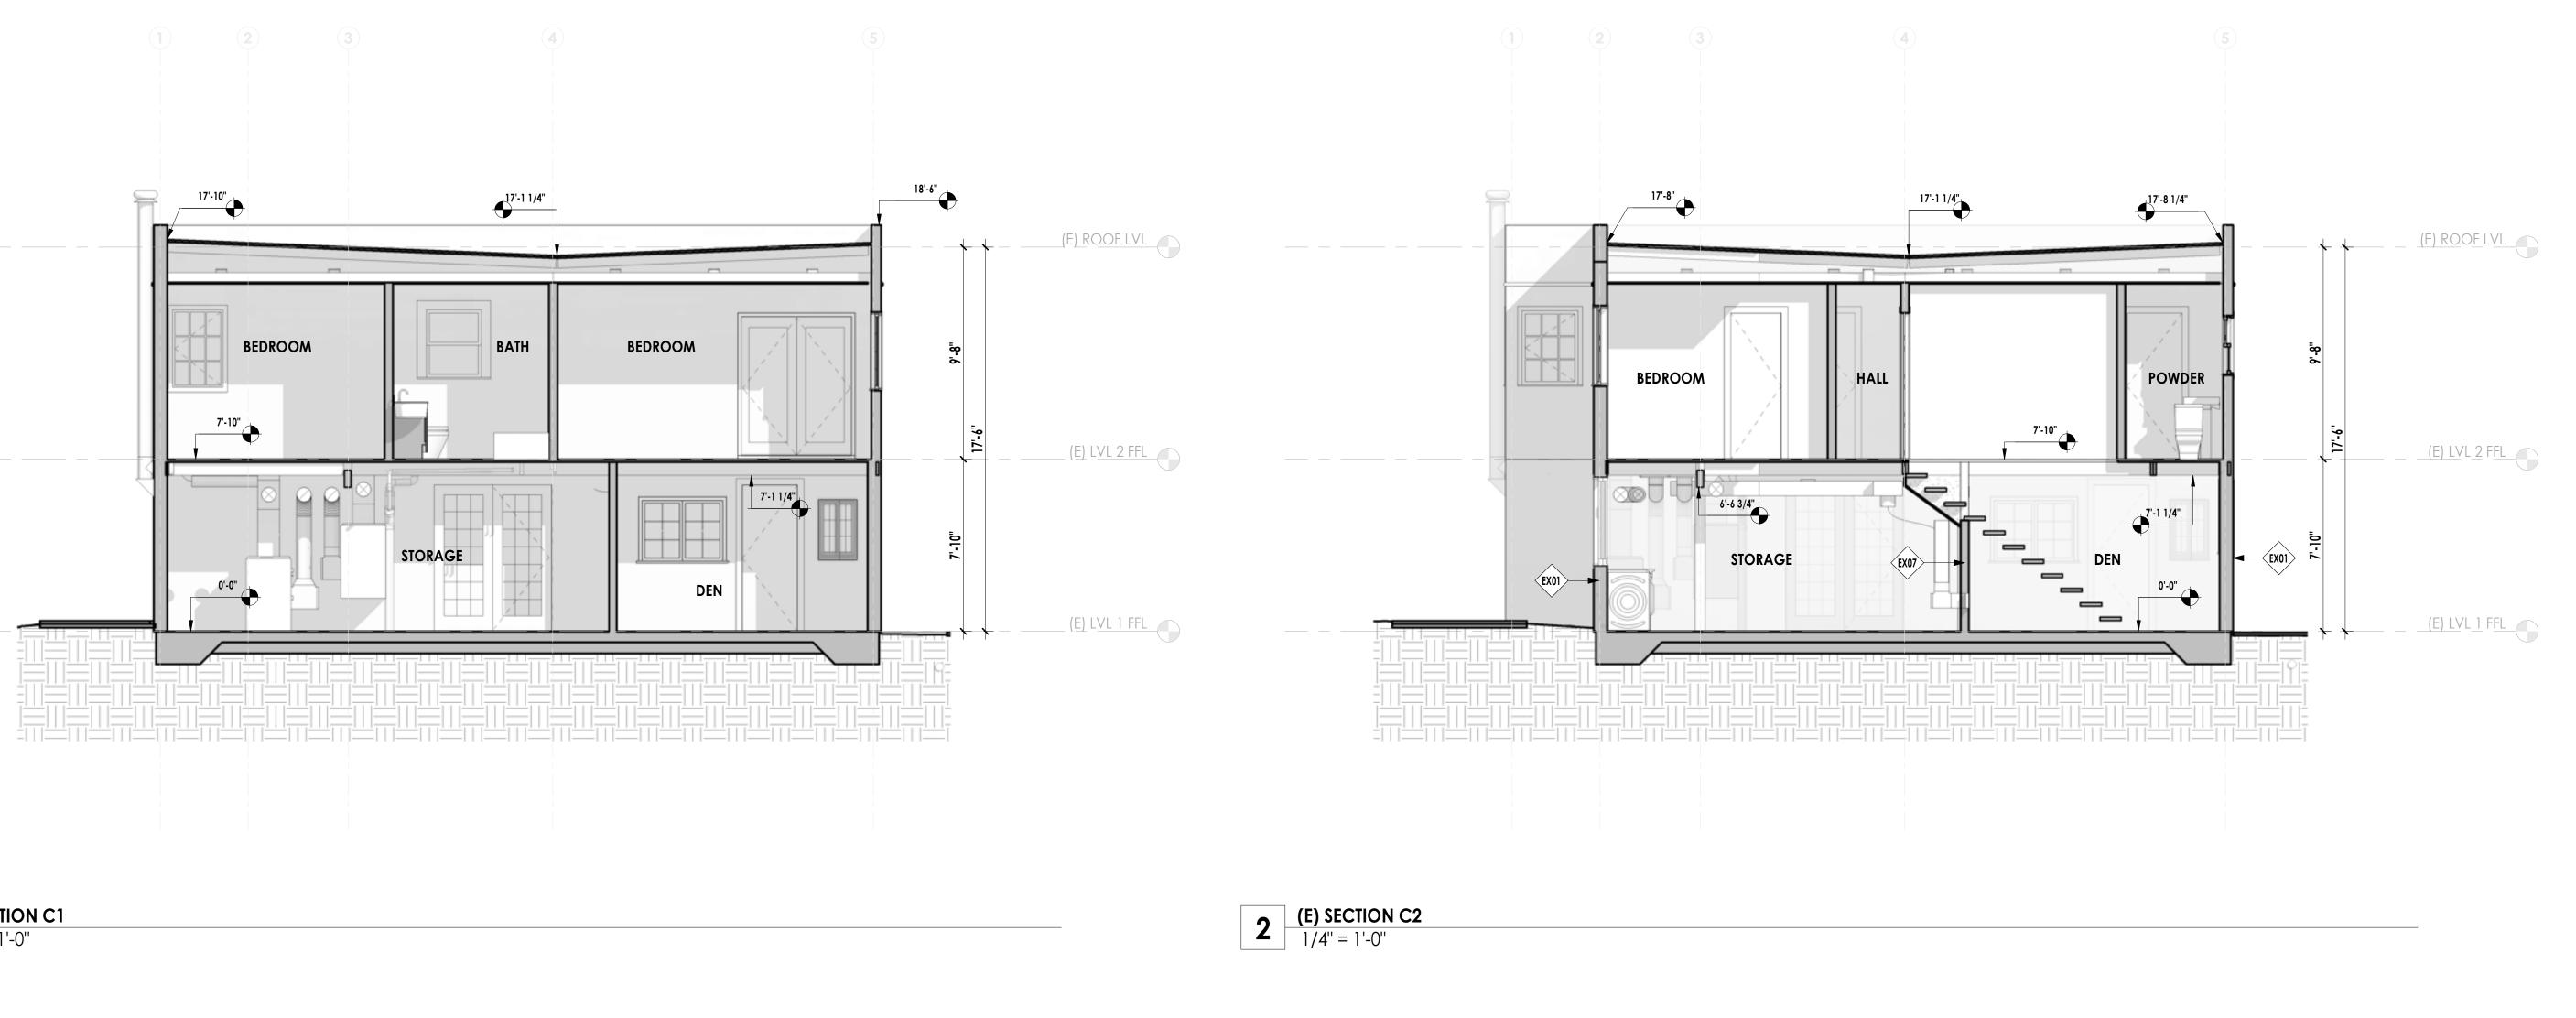



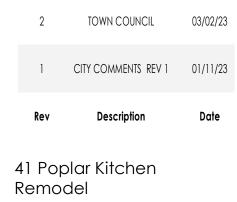

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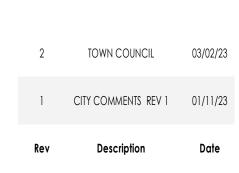
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(E) SECTIONS

02/03/23

As Noted





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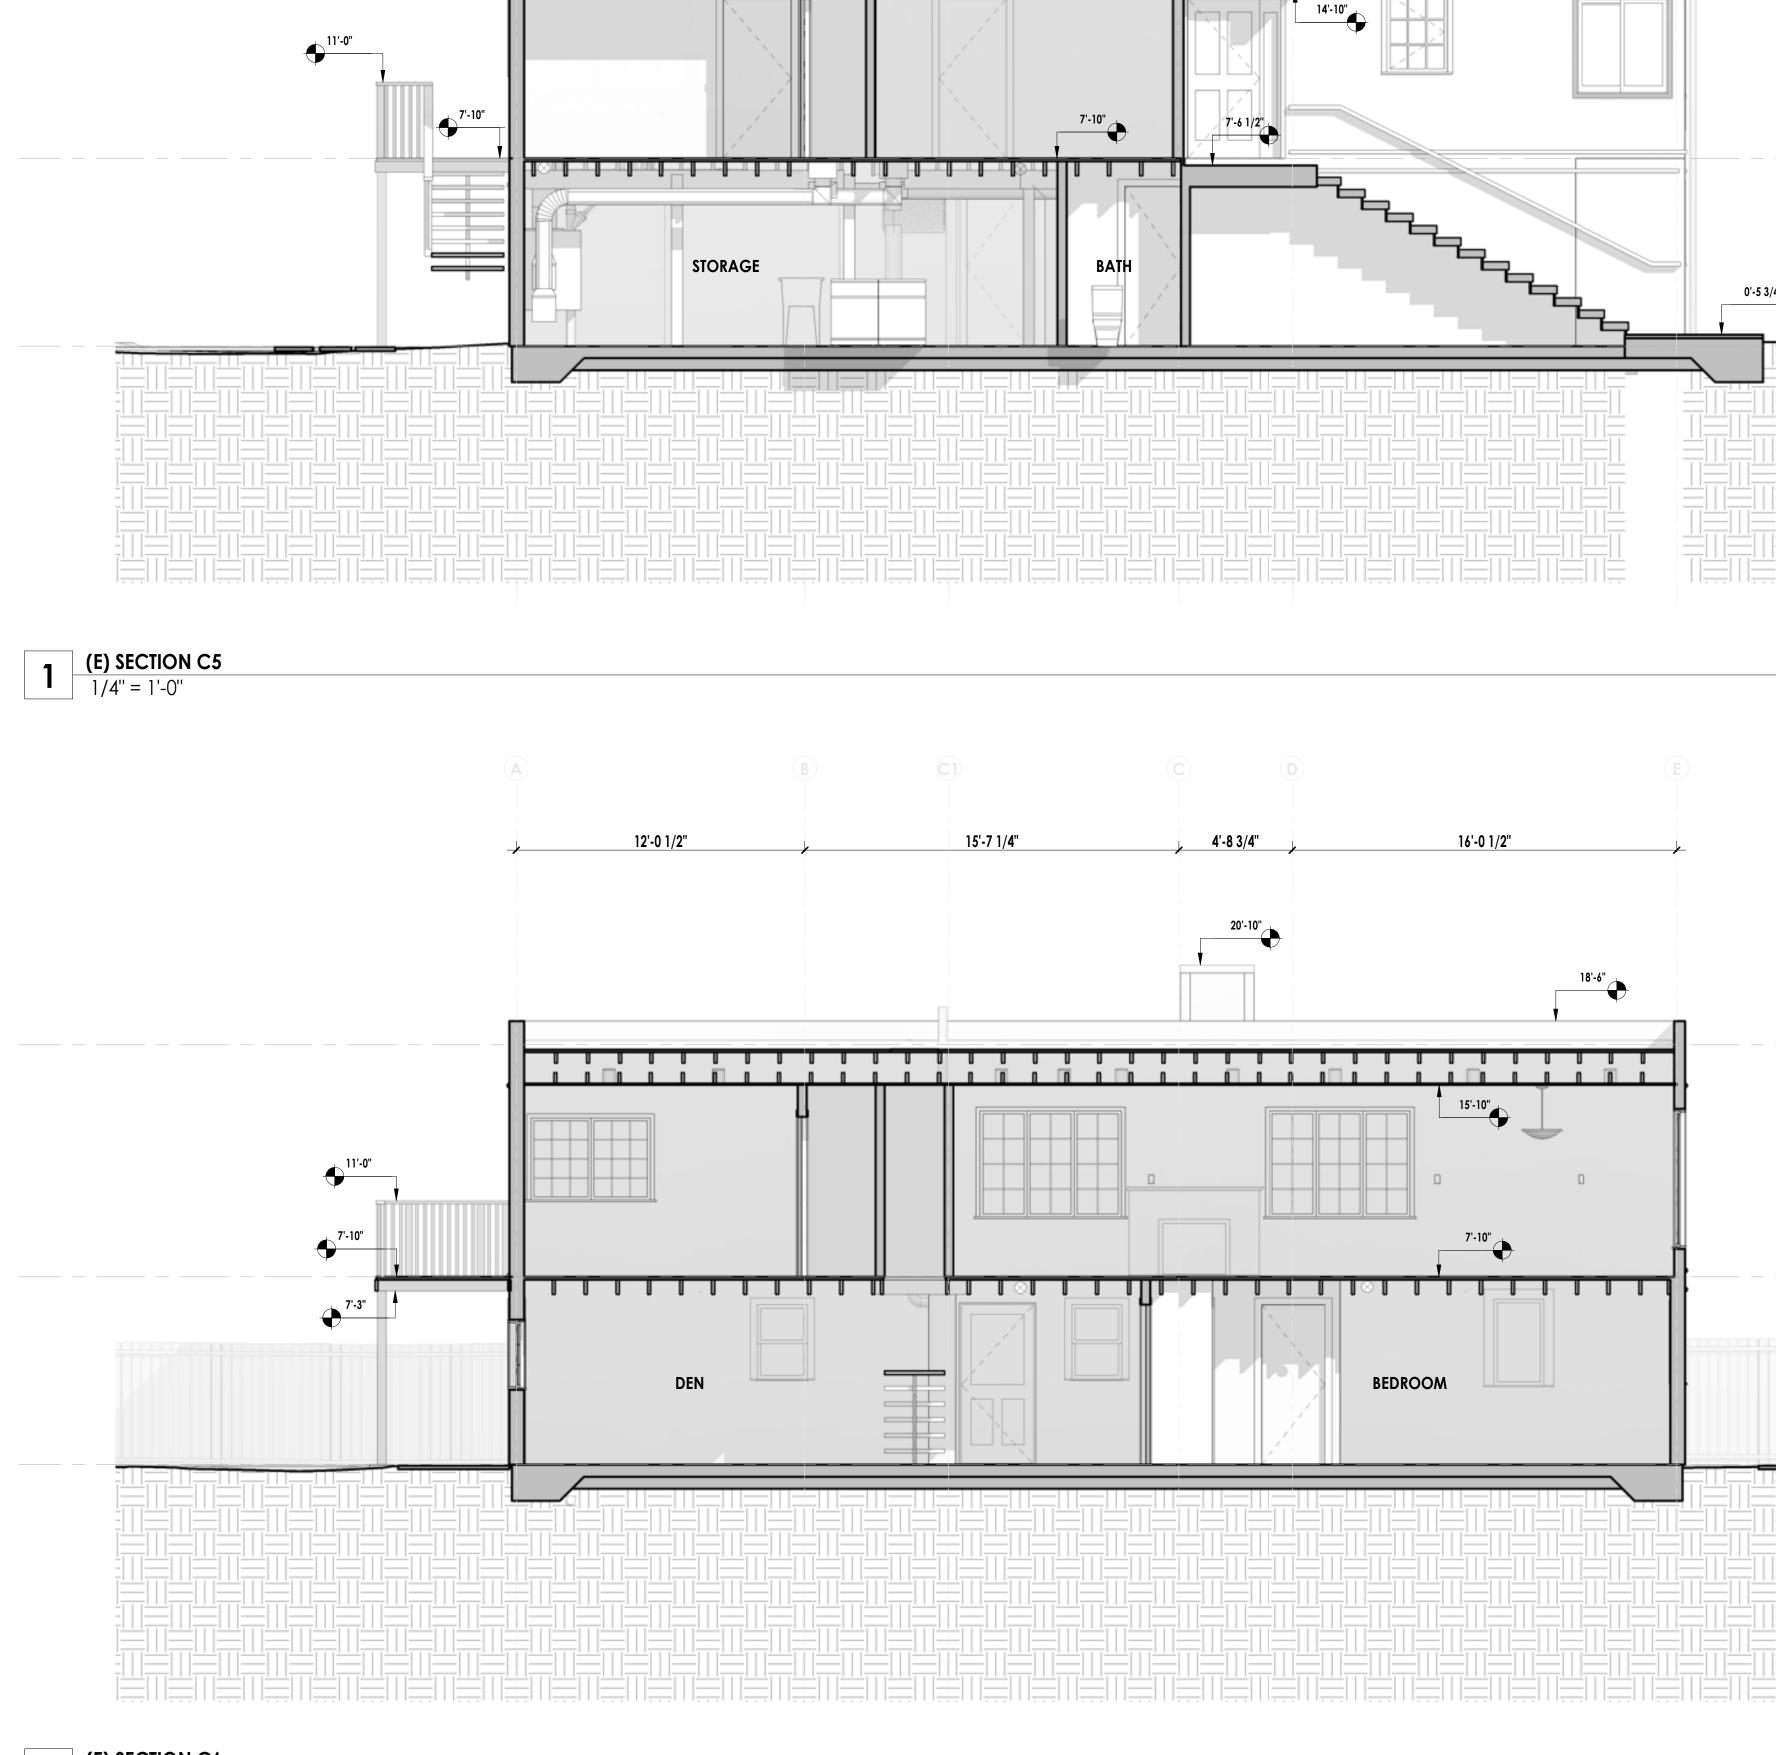
info@craftedearth.com

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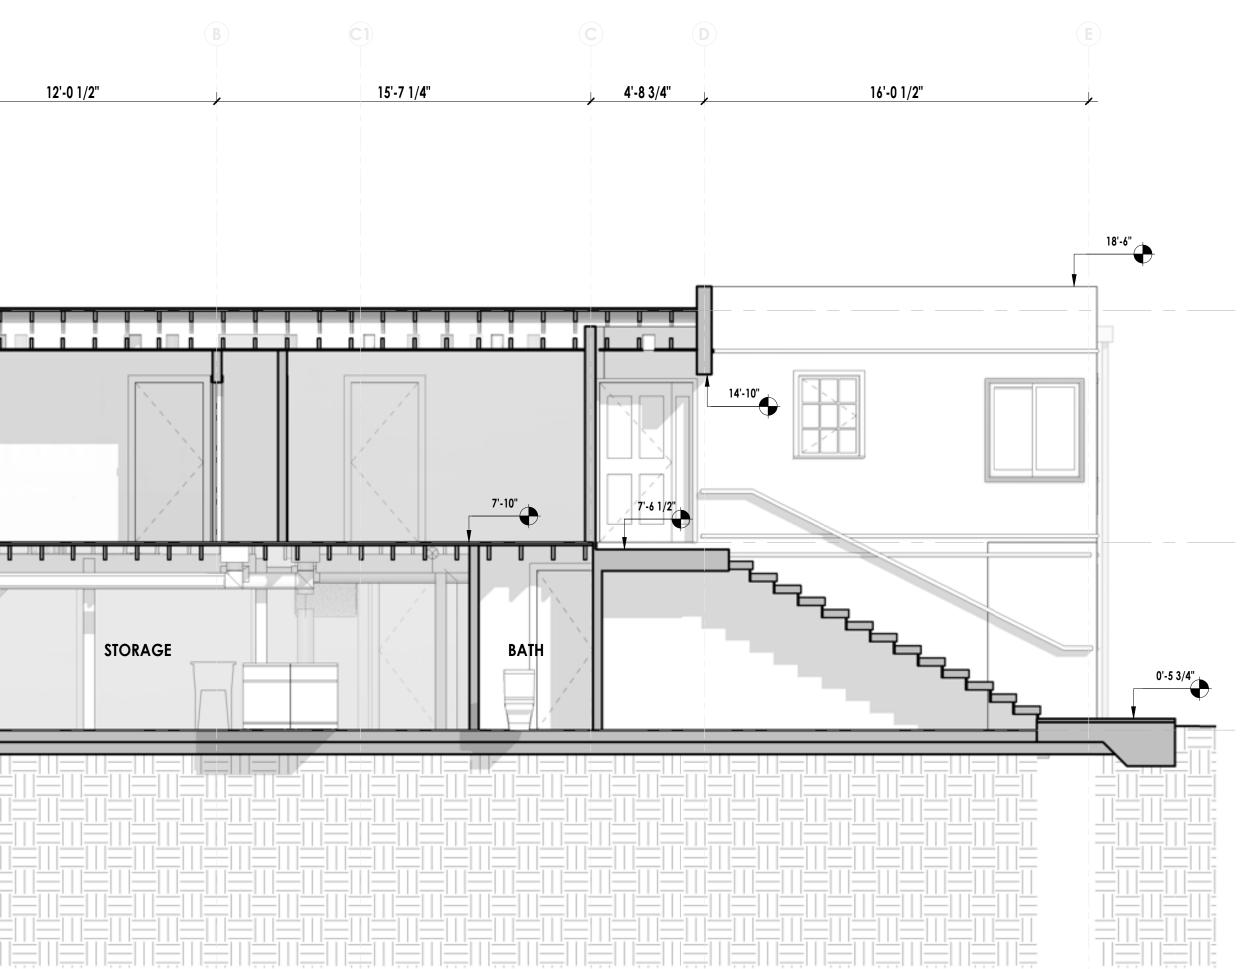
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(E) SECTION C6 1/4" = 1'-0"



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Rev	Description	Date
1	CITY COMMENTS REV 1	01/11/23
2	TOWN COUNCIL	03/02/23


41 Poplar Kitchen Remodel


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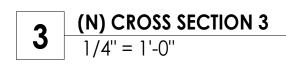
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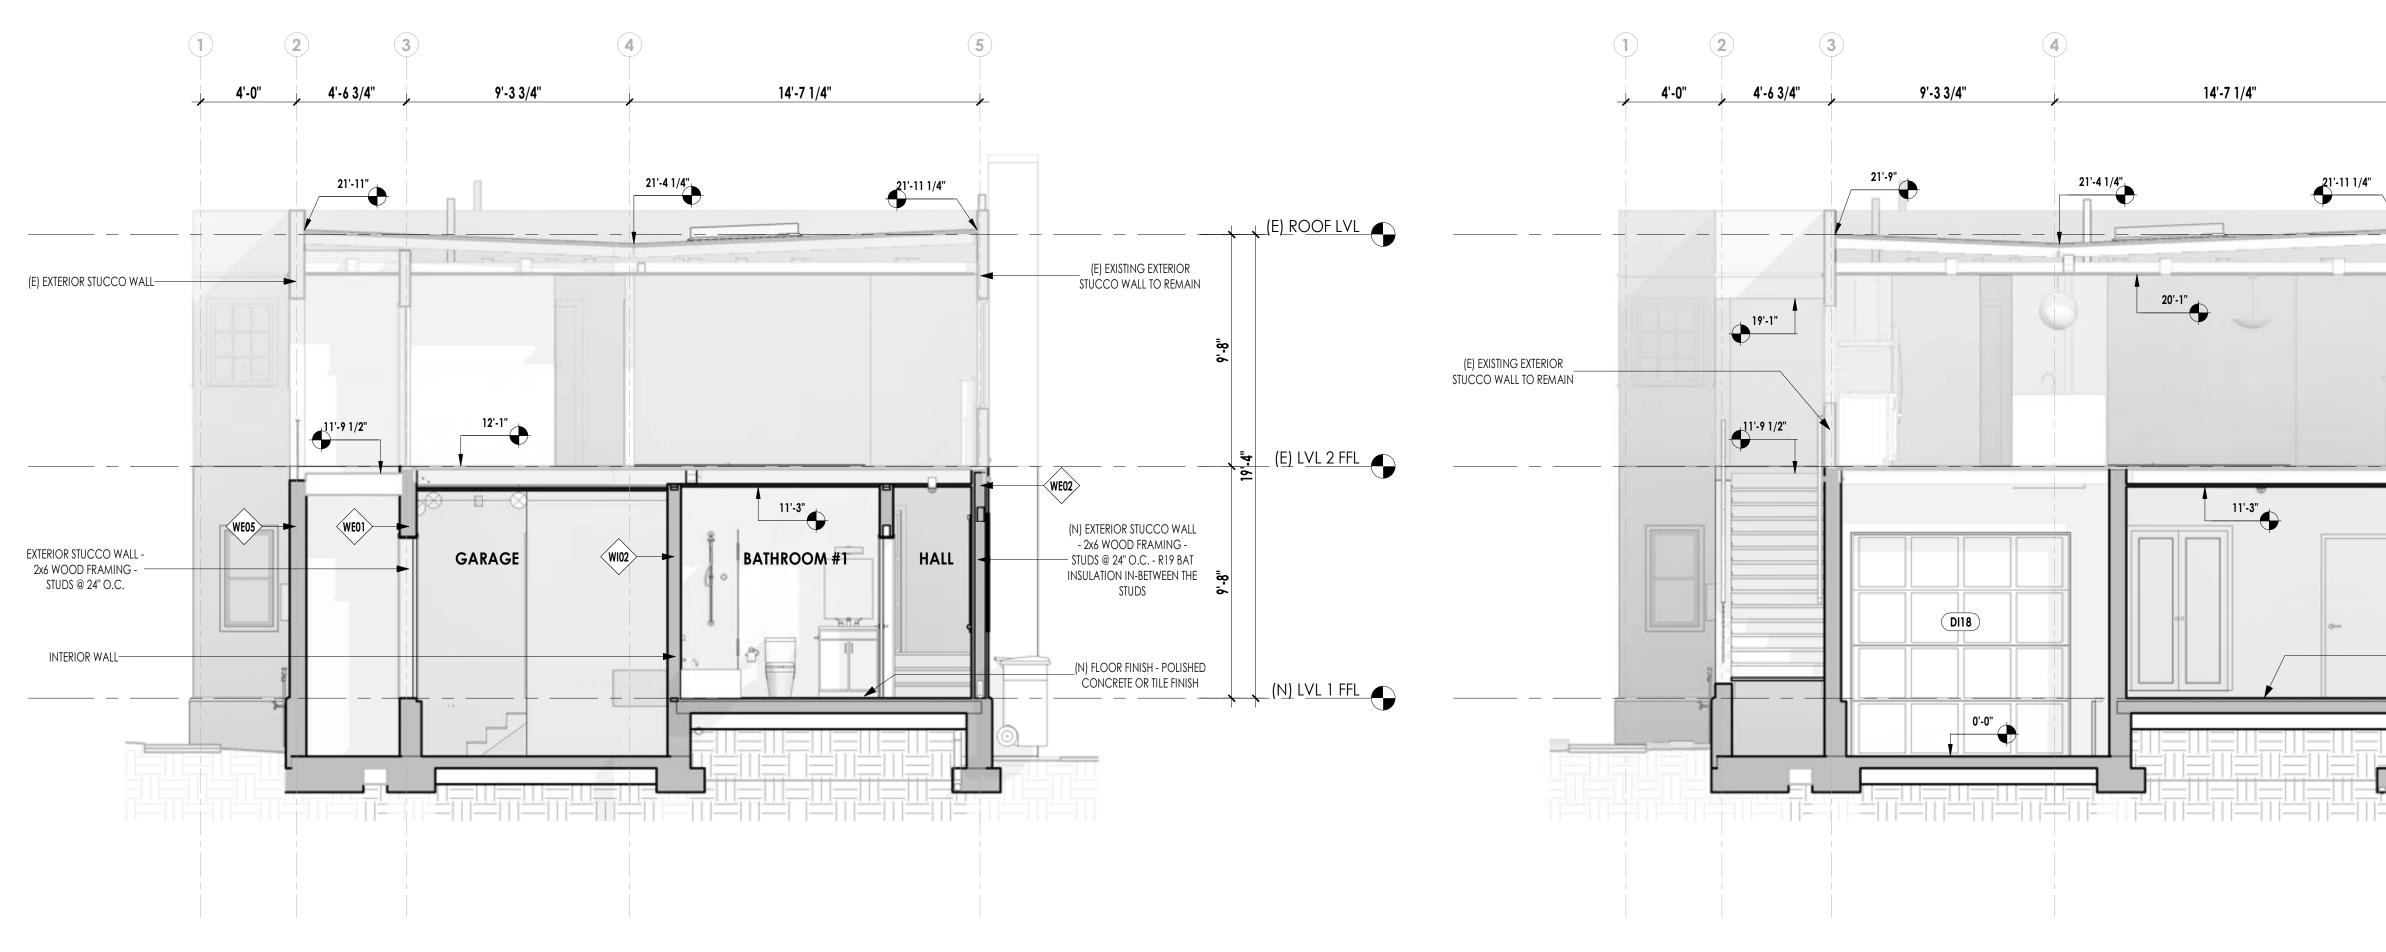
(E) LONGITUDINAL SECTIONS








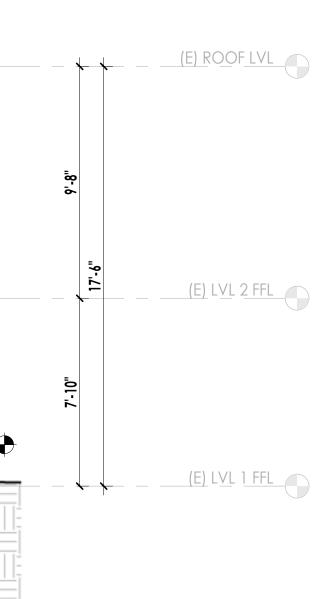

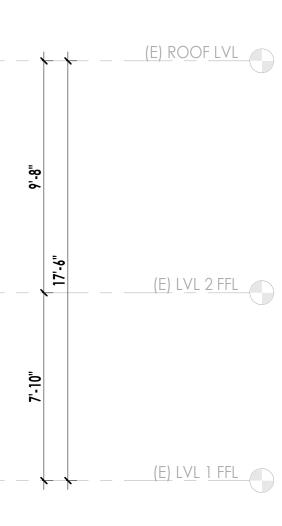

1 (N) CROSS SECTION 1 1/4" = 1'-0"

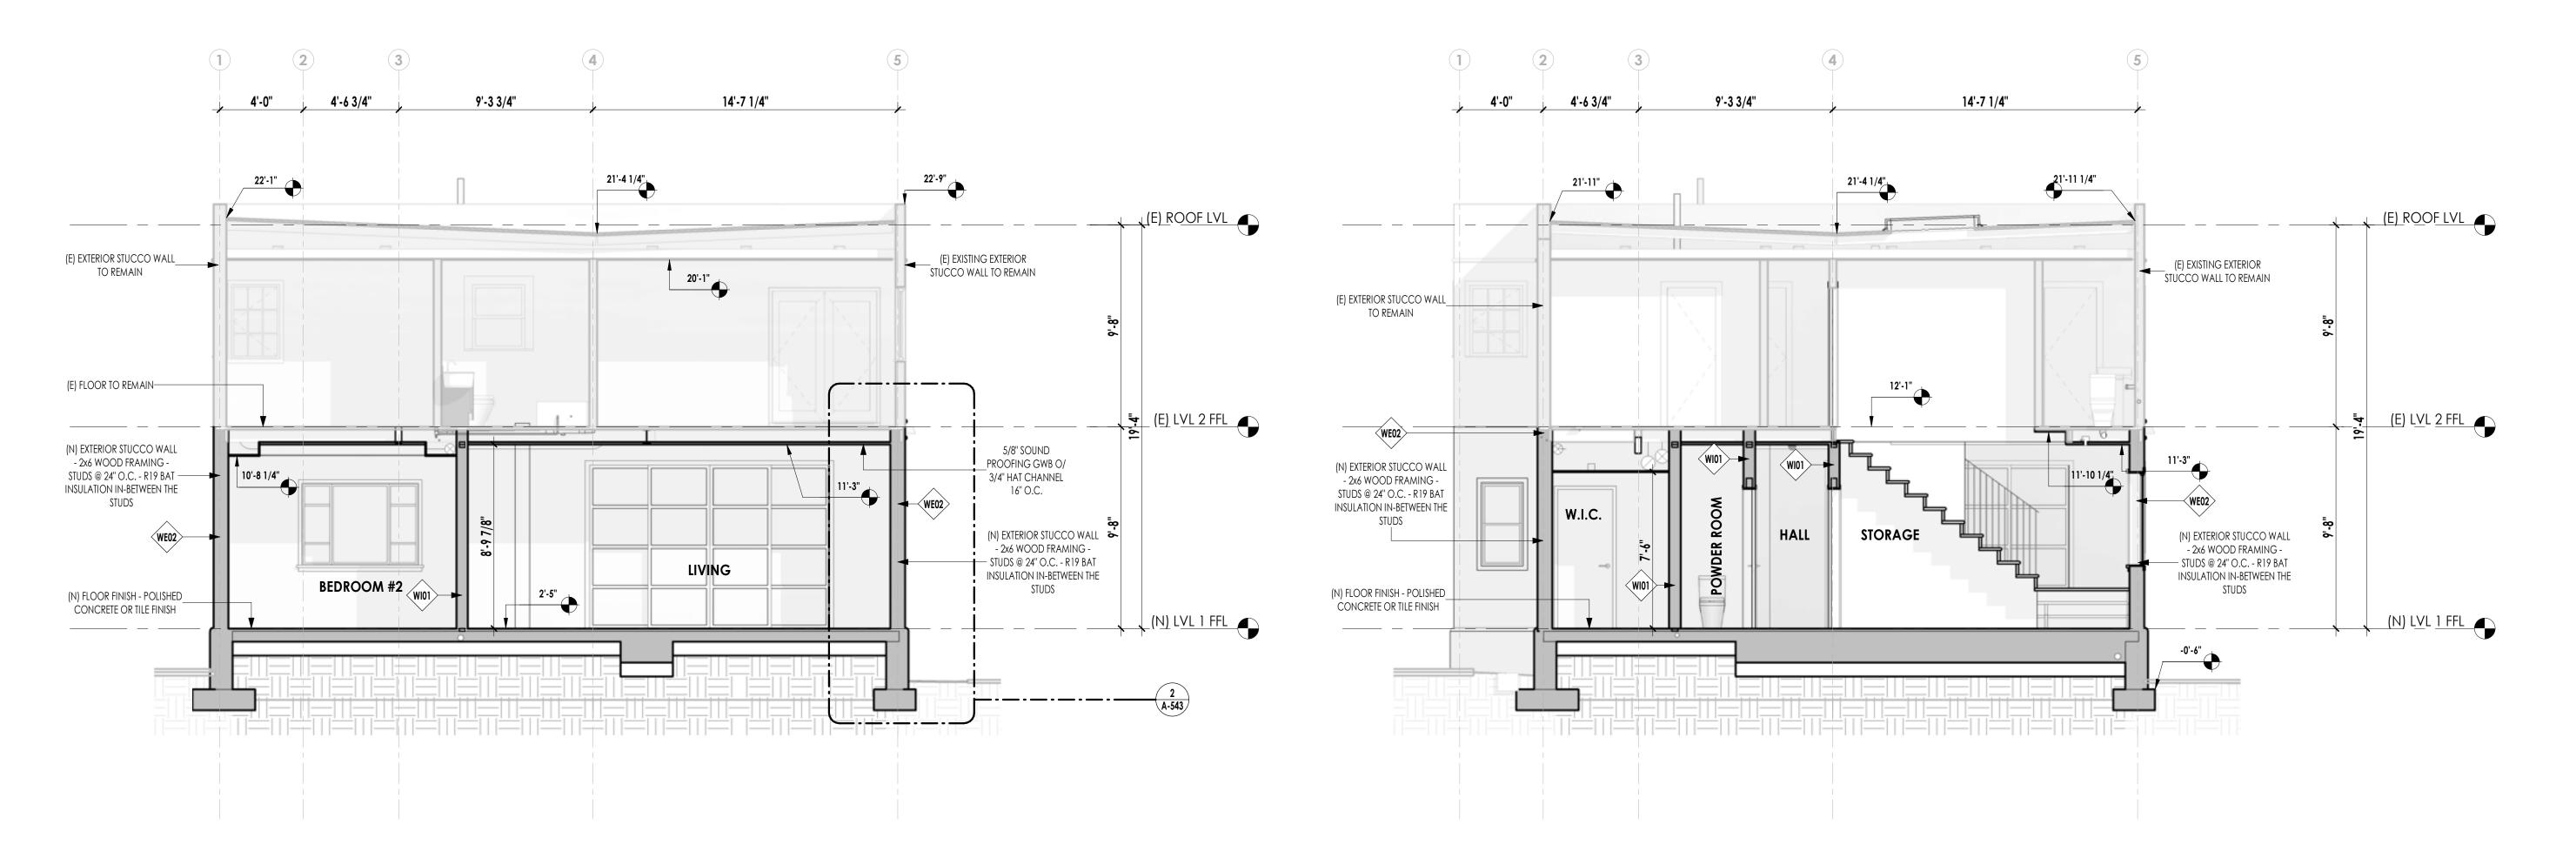

2 (N) CROSS SECTION 2

4 (N) CROSS SECTION 4 1/4" = 1'-0"



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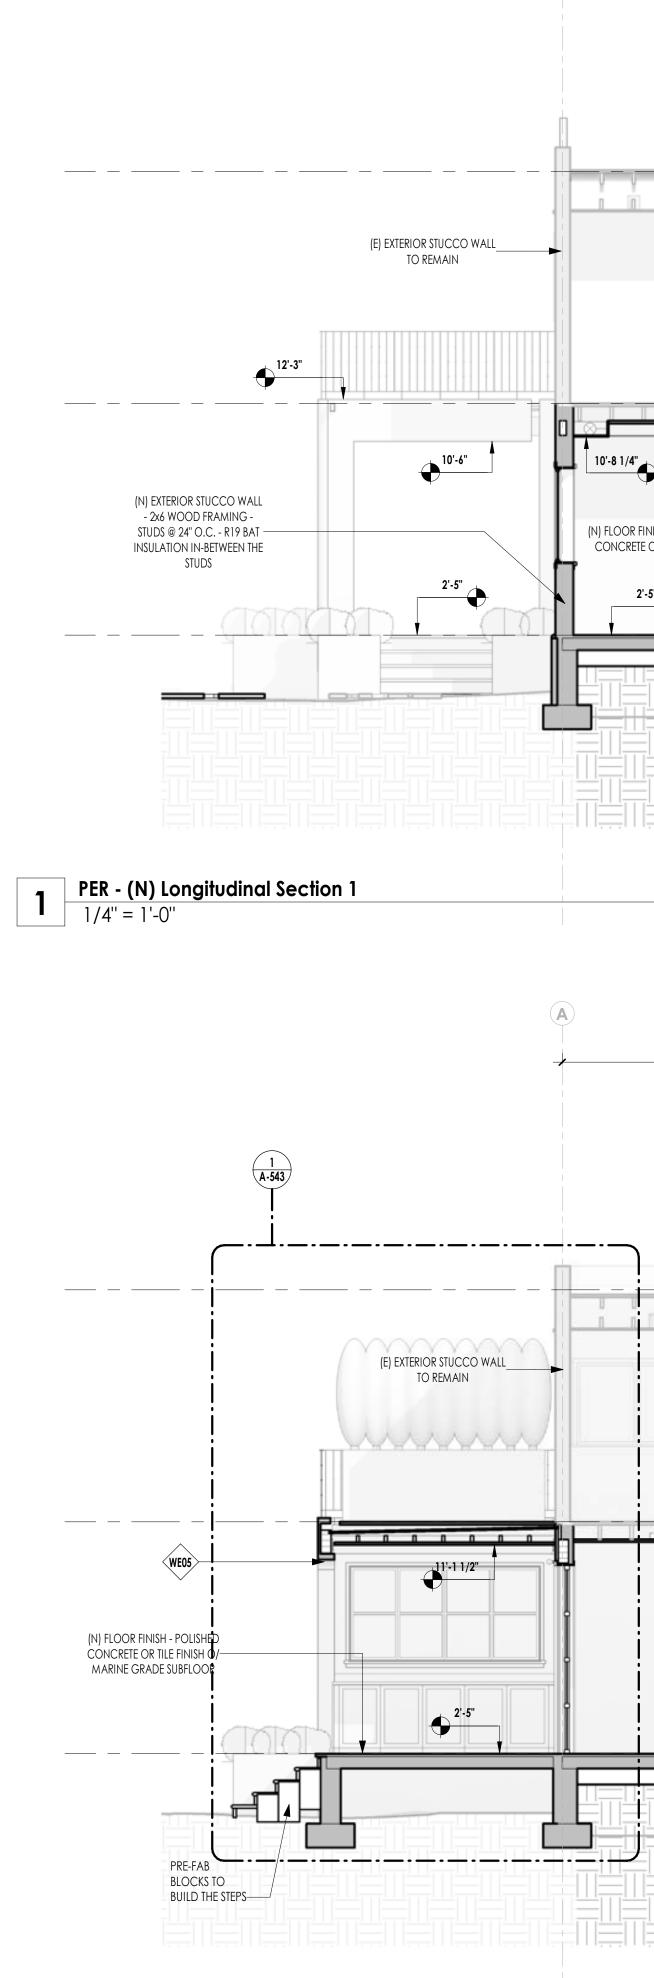
(E) EXISTING EXTERIOR (E) EXISTING EXTERIOR (E) EXISTING EXTERIOR (E) EVIL 2 FFL (N) EXTERIOR STUCCO WALL - 2-26 WOOD FRAMIN -

2 TOWN COUNCIL 03/02/23


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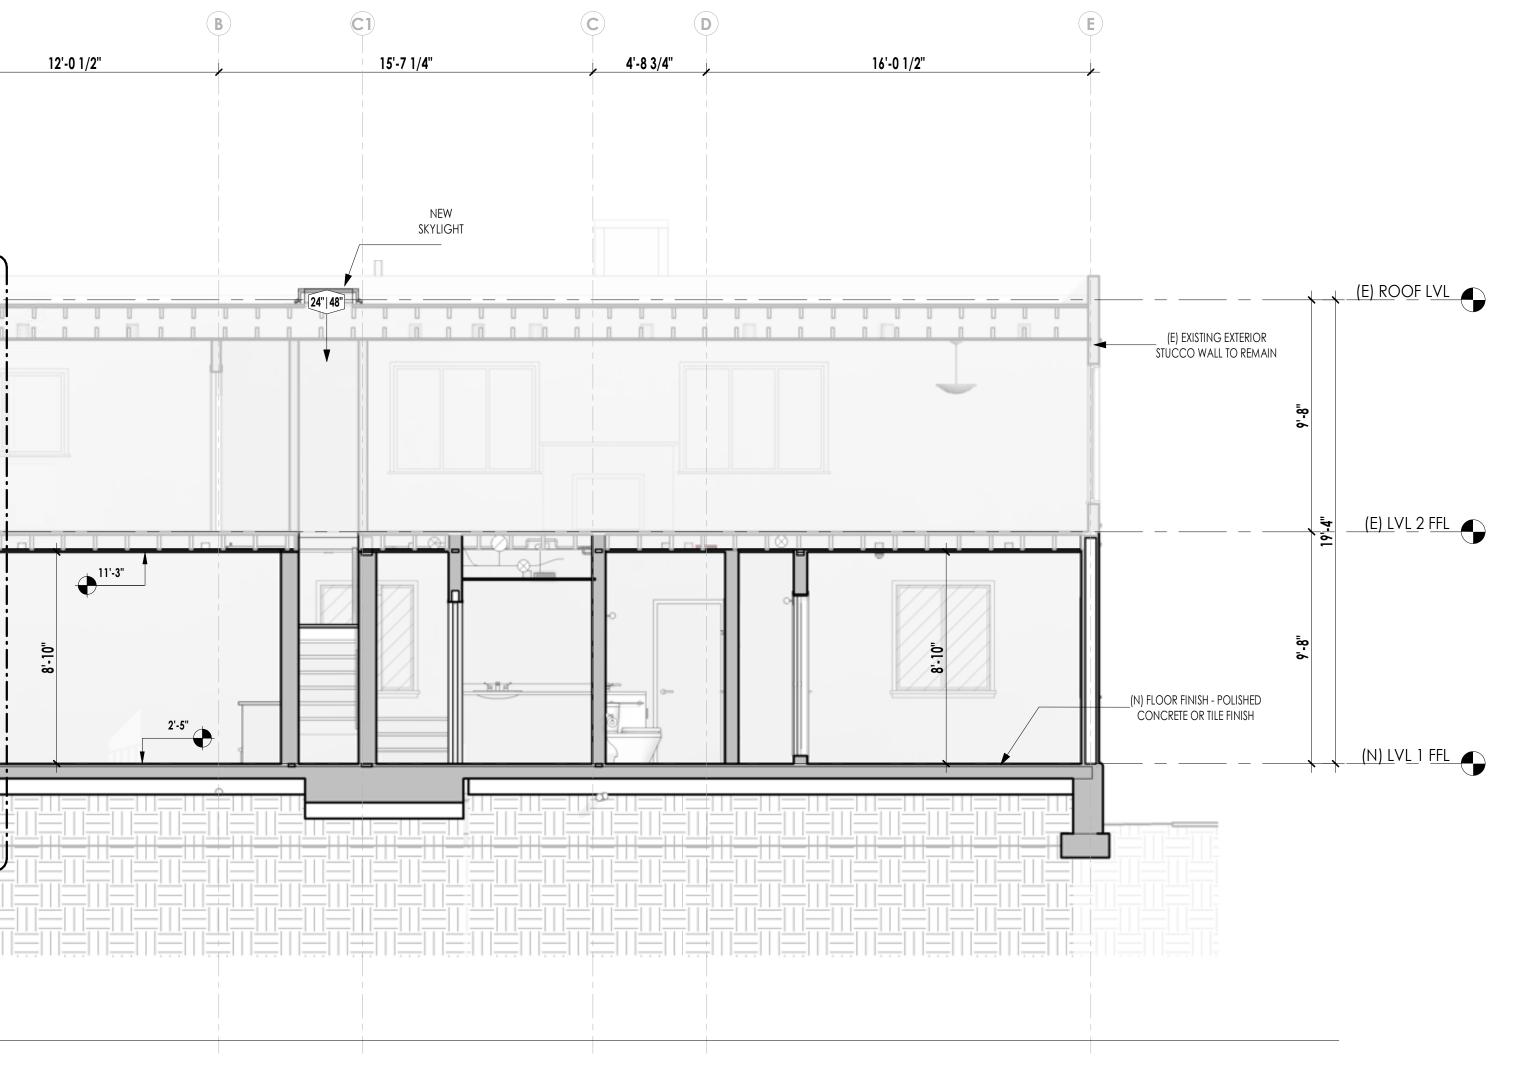
(N) CROSS SECTIONS





2 PER - (N) Longitudinal Section 2 1/4" = 1'-0"



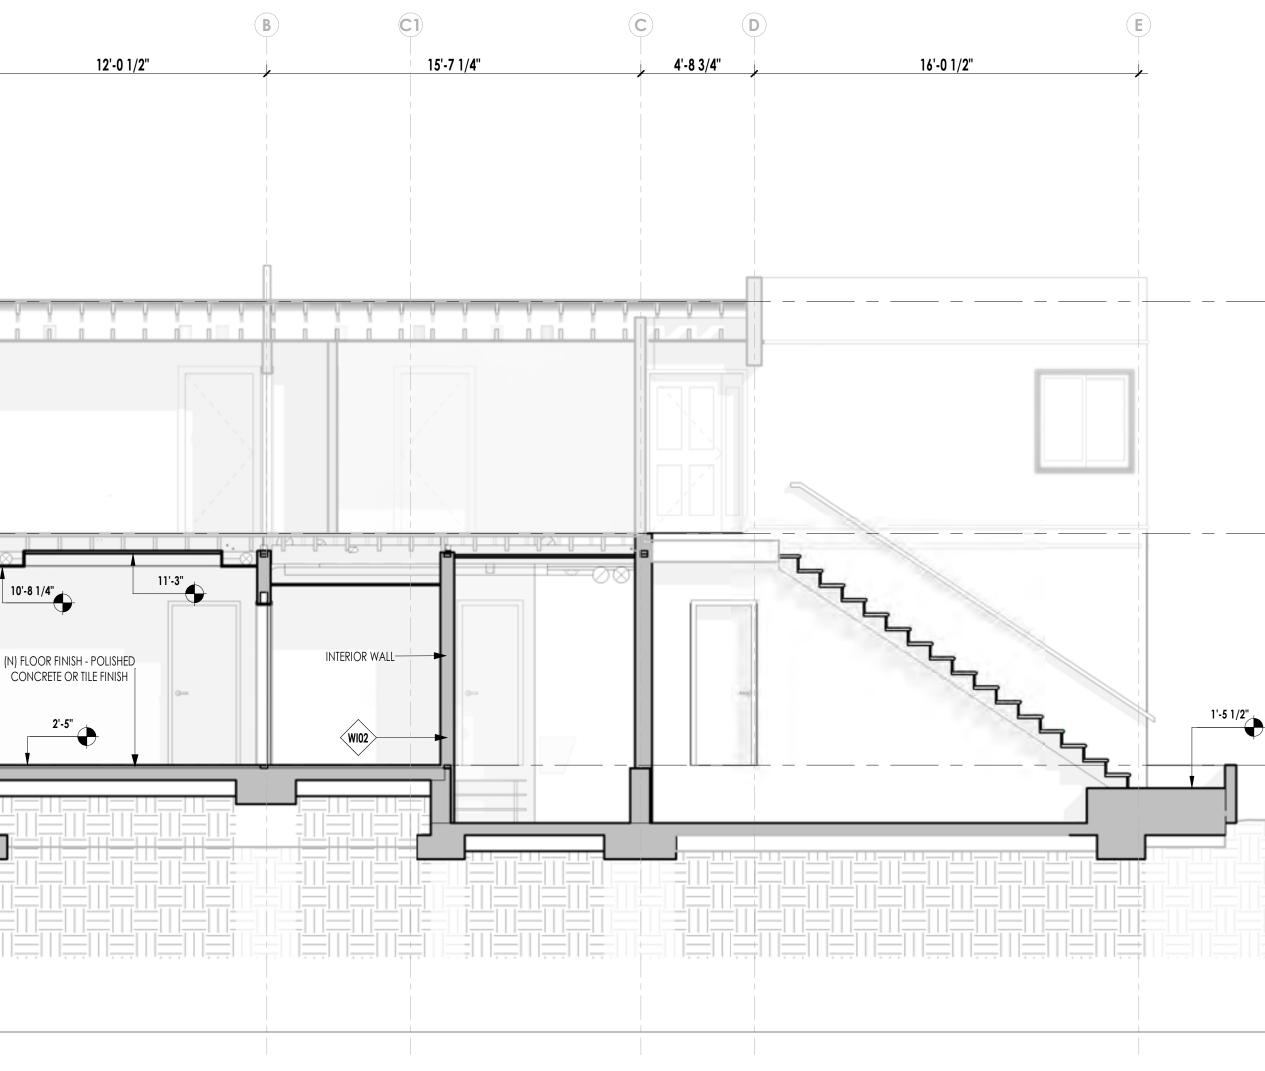

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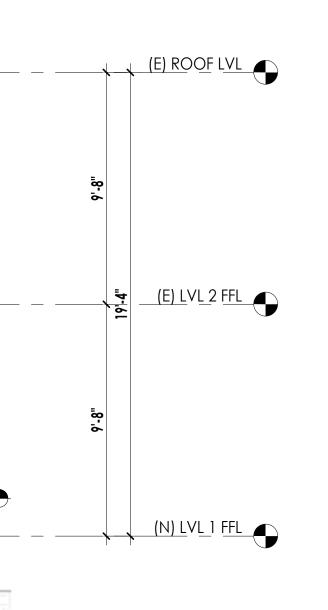
41 Poplar Kitchen Remodel


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Scale:	As Noted

(N) LONGITUDINAL SECTIONS

Sheet Title





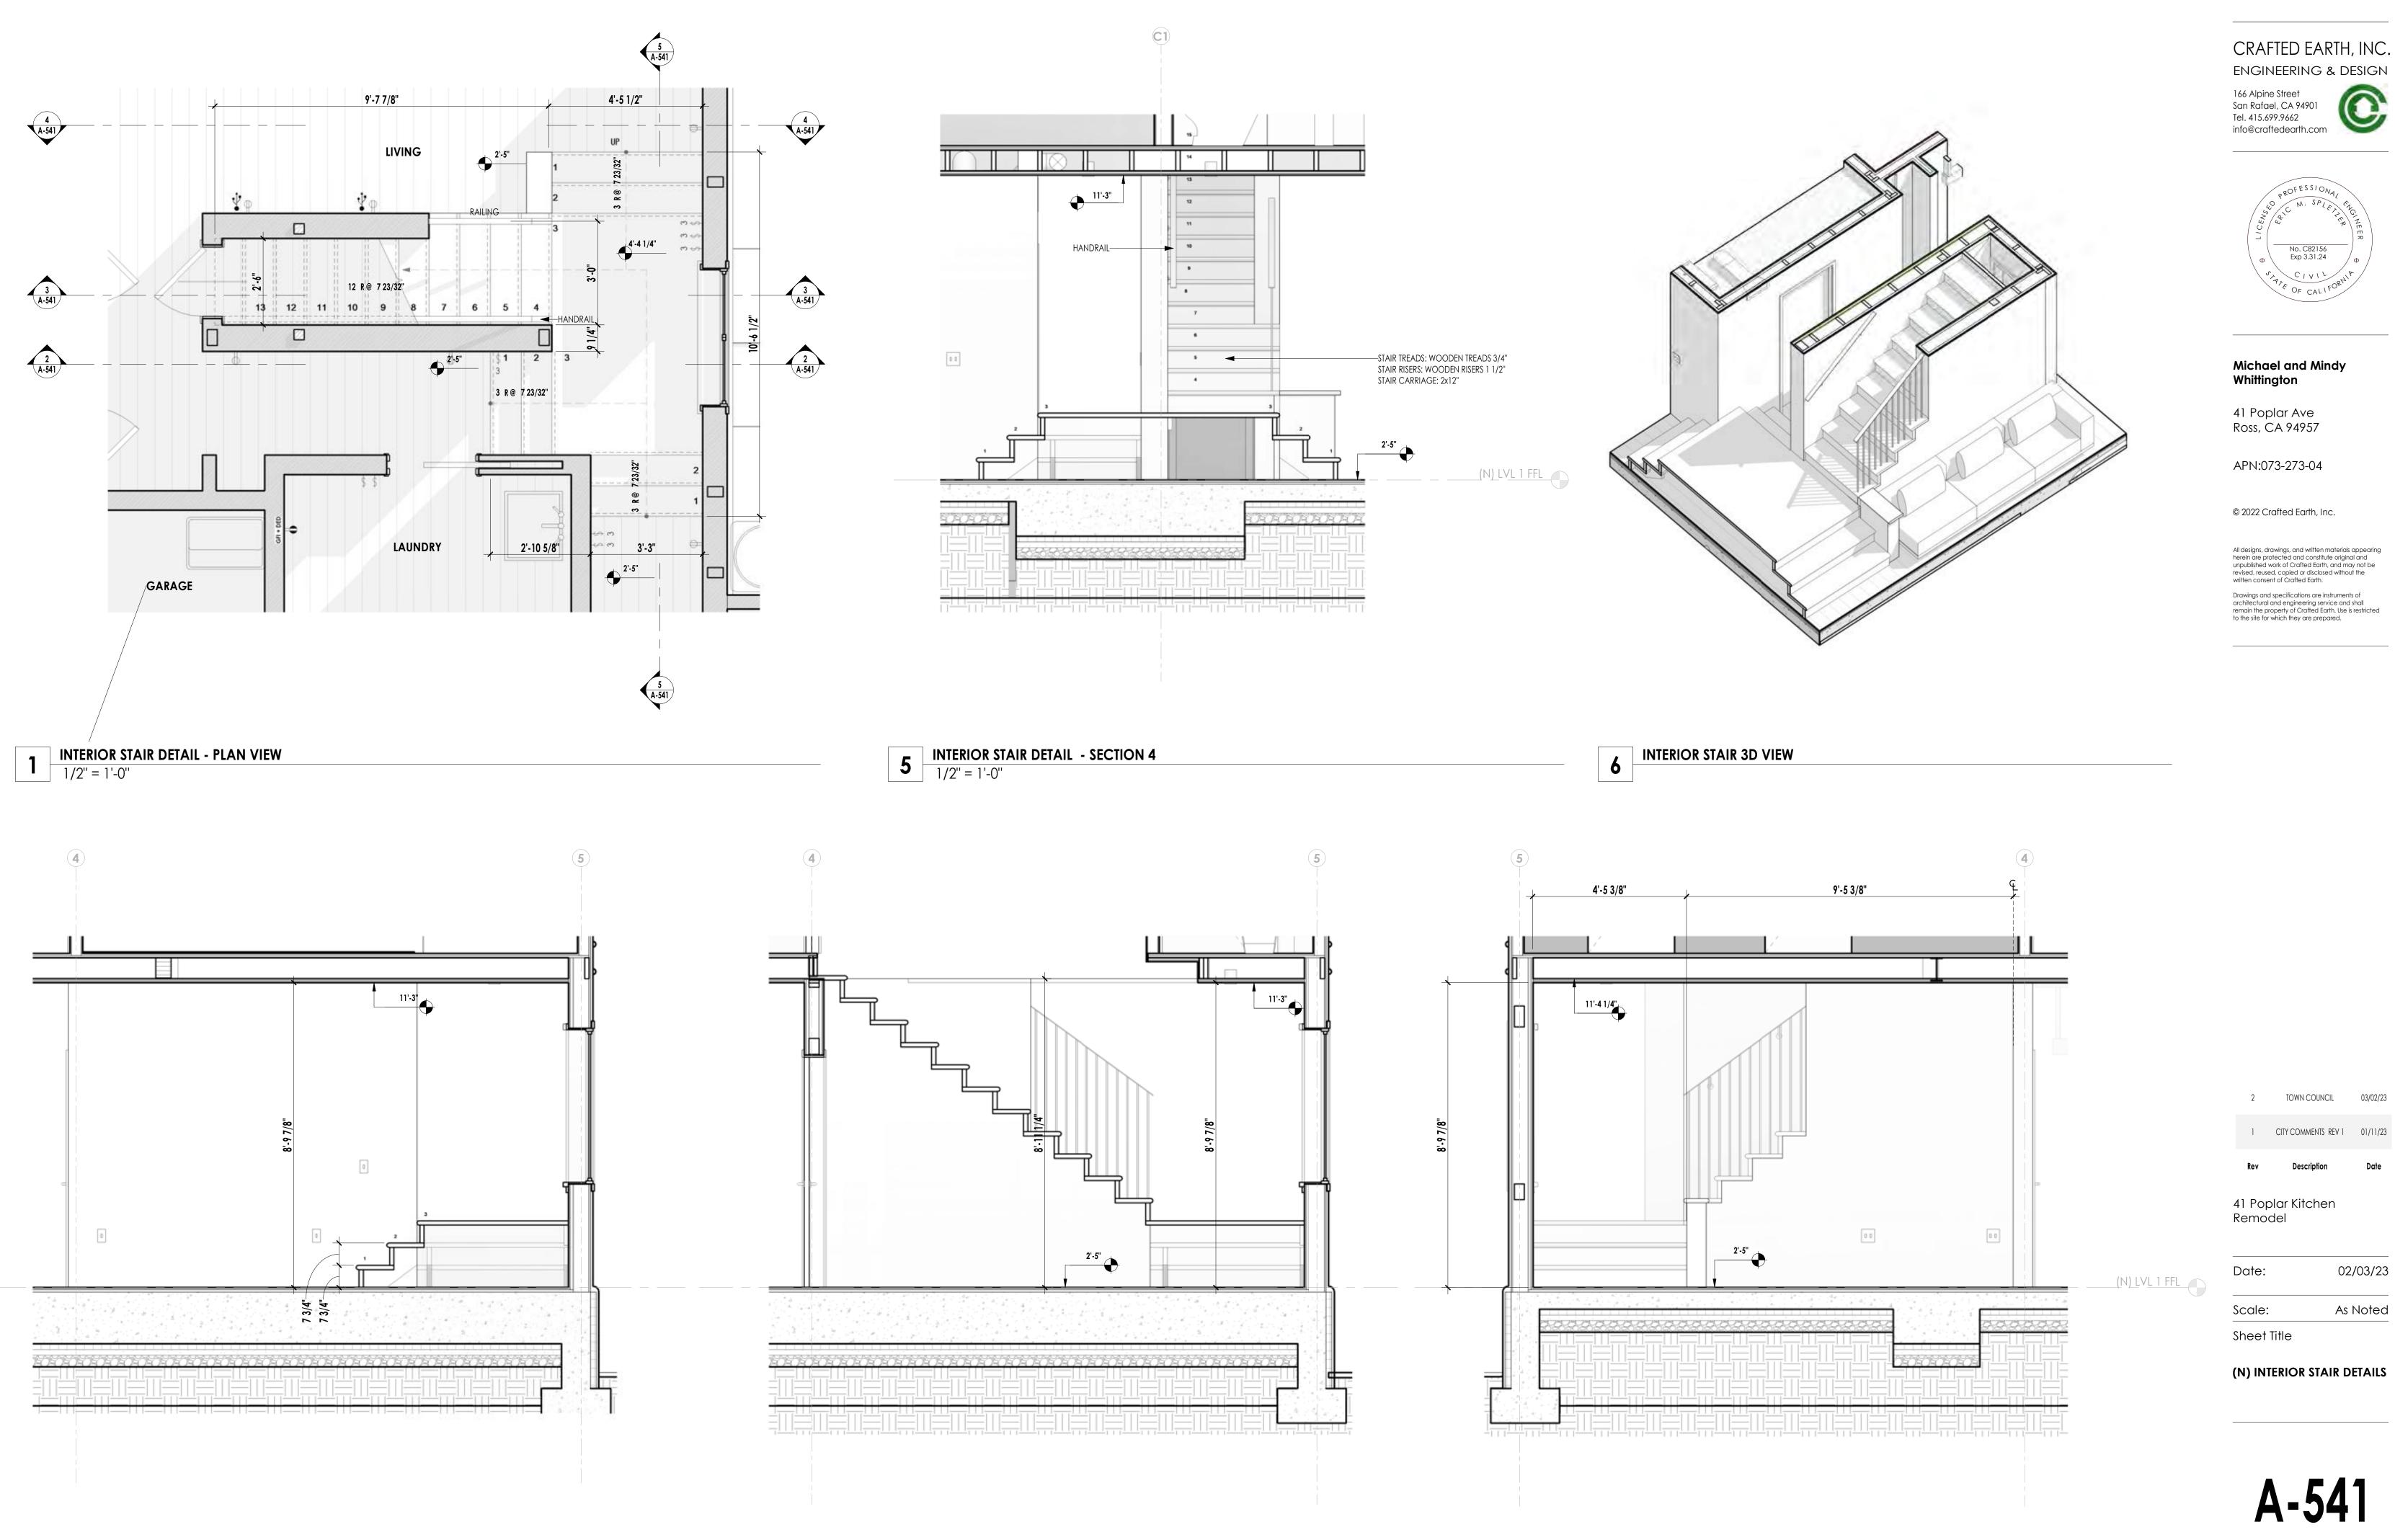



2 INTERIOR STAIR DETAIL - SECTION 1 1/2" = 1'-0"

4 INTERIOR STAIR DETAIL - SECTION 3 1/2'' = 1'-0''






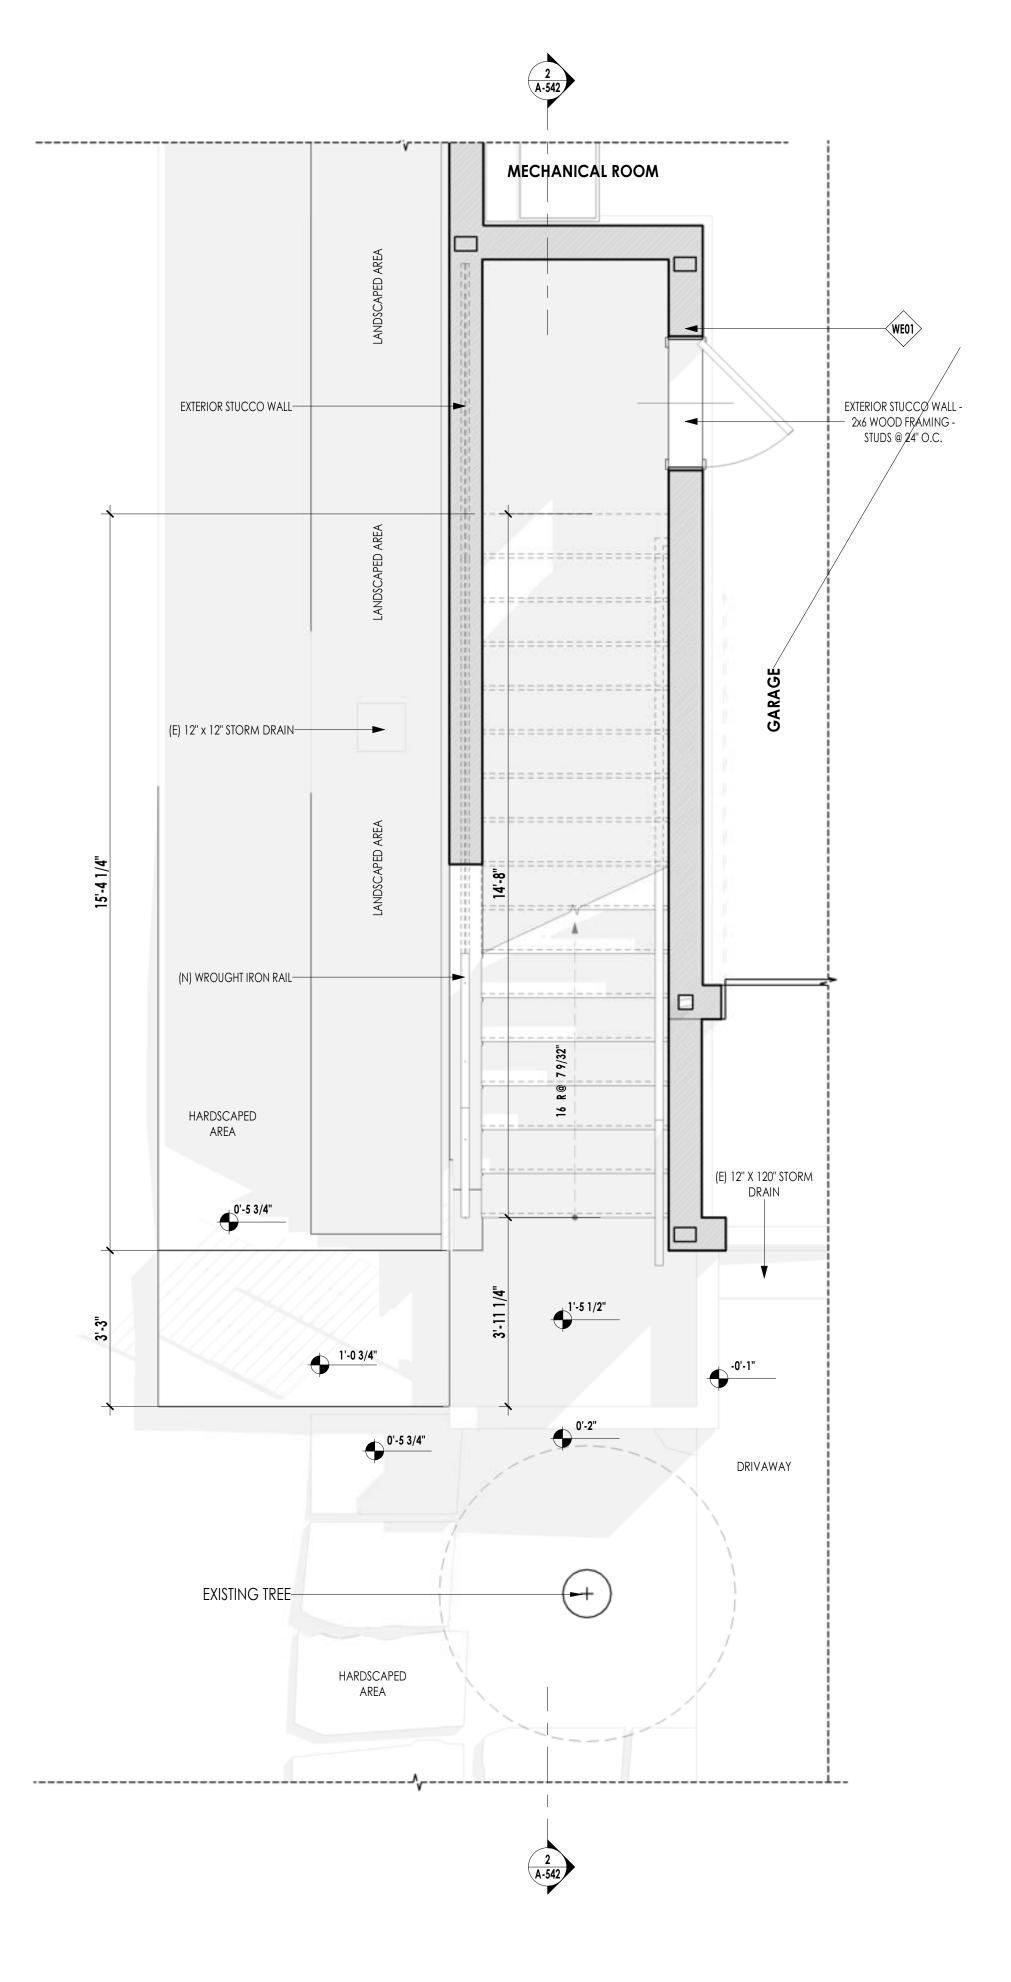

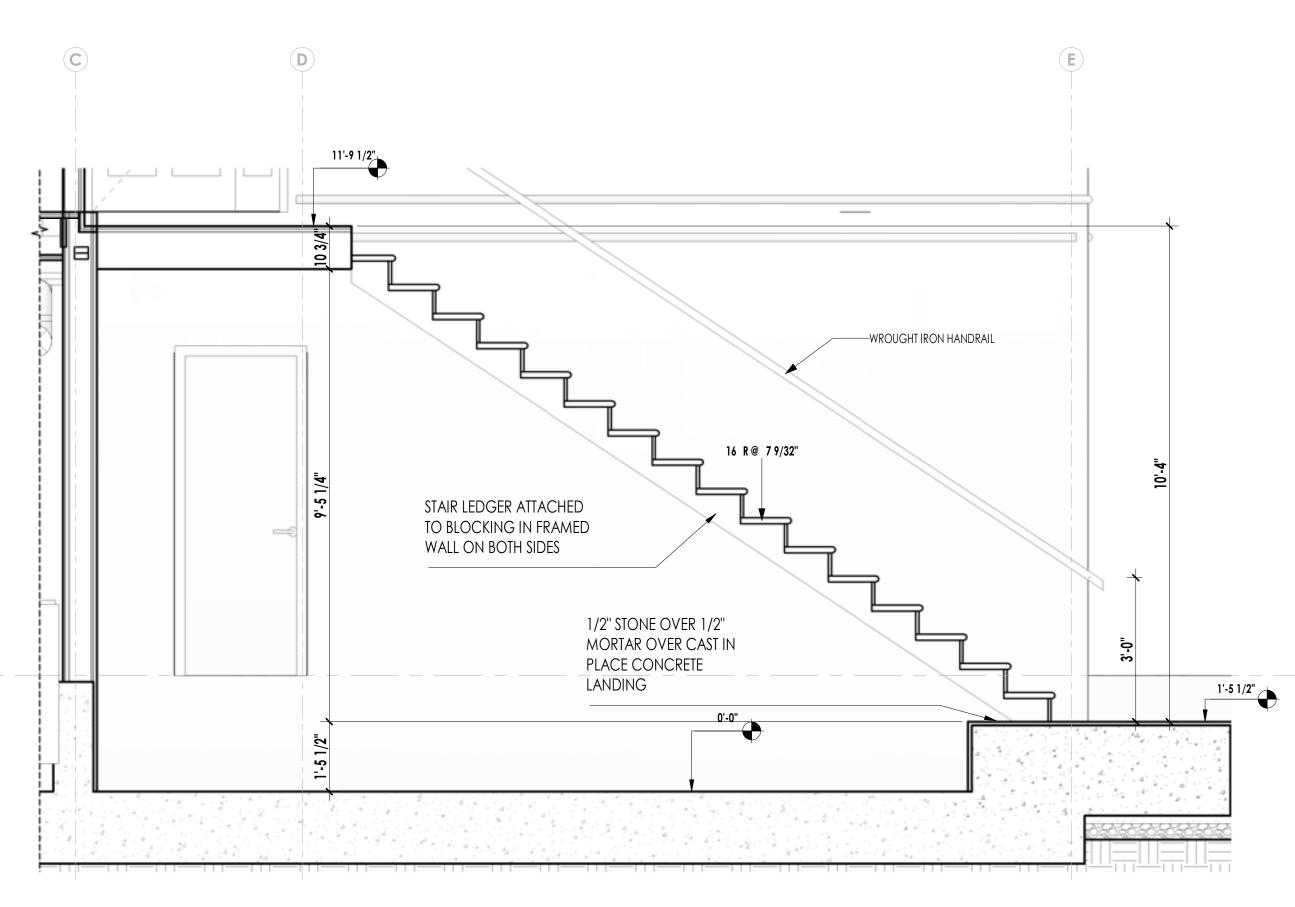

2 EXTERIOR STAIR DETAIL - SECTION 1 1/2" = 1'-0"

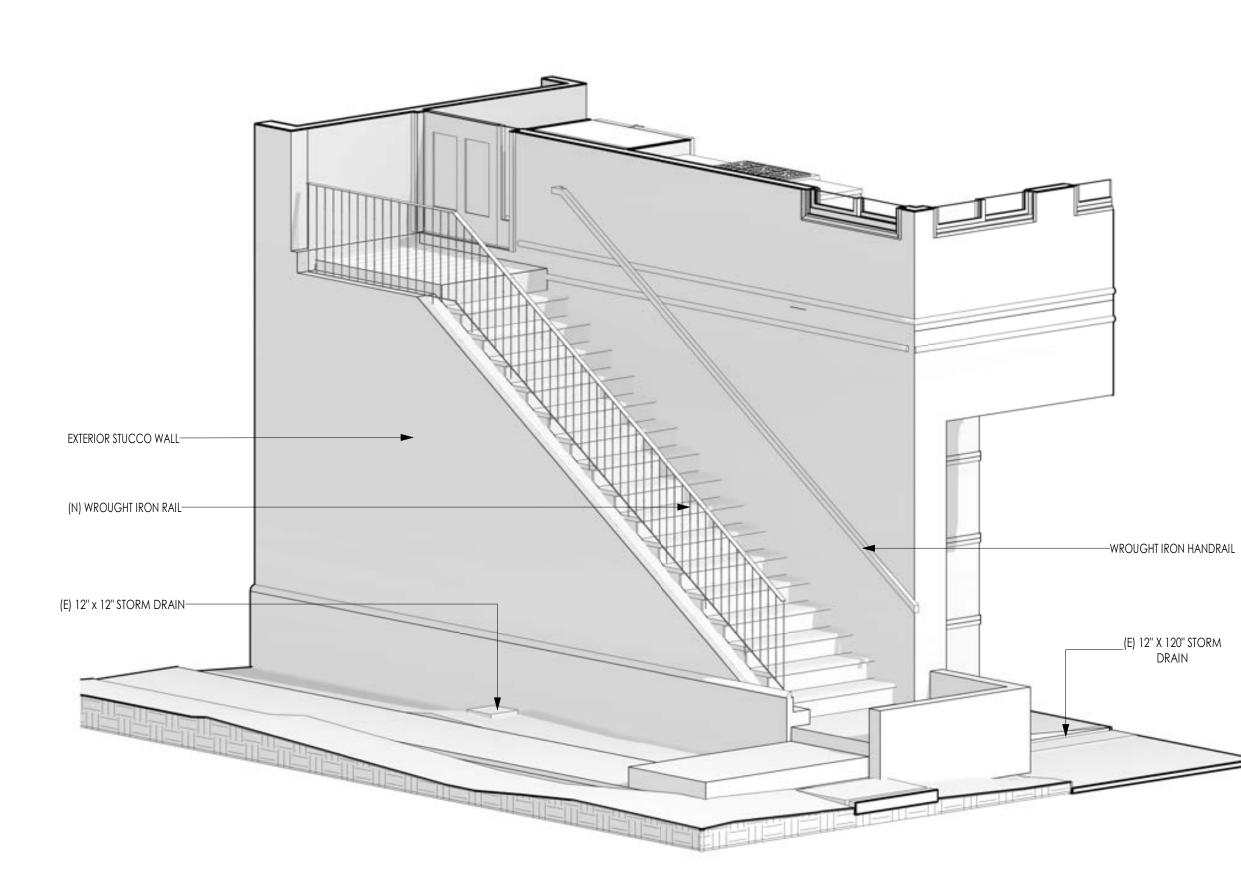

(N) LVL <u>1 FFL</u>

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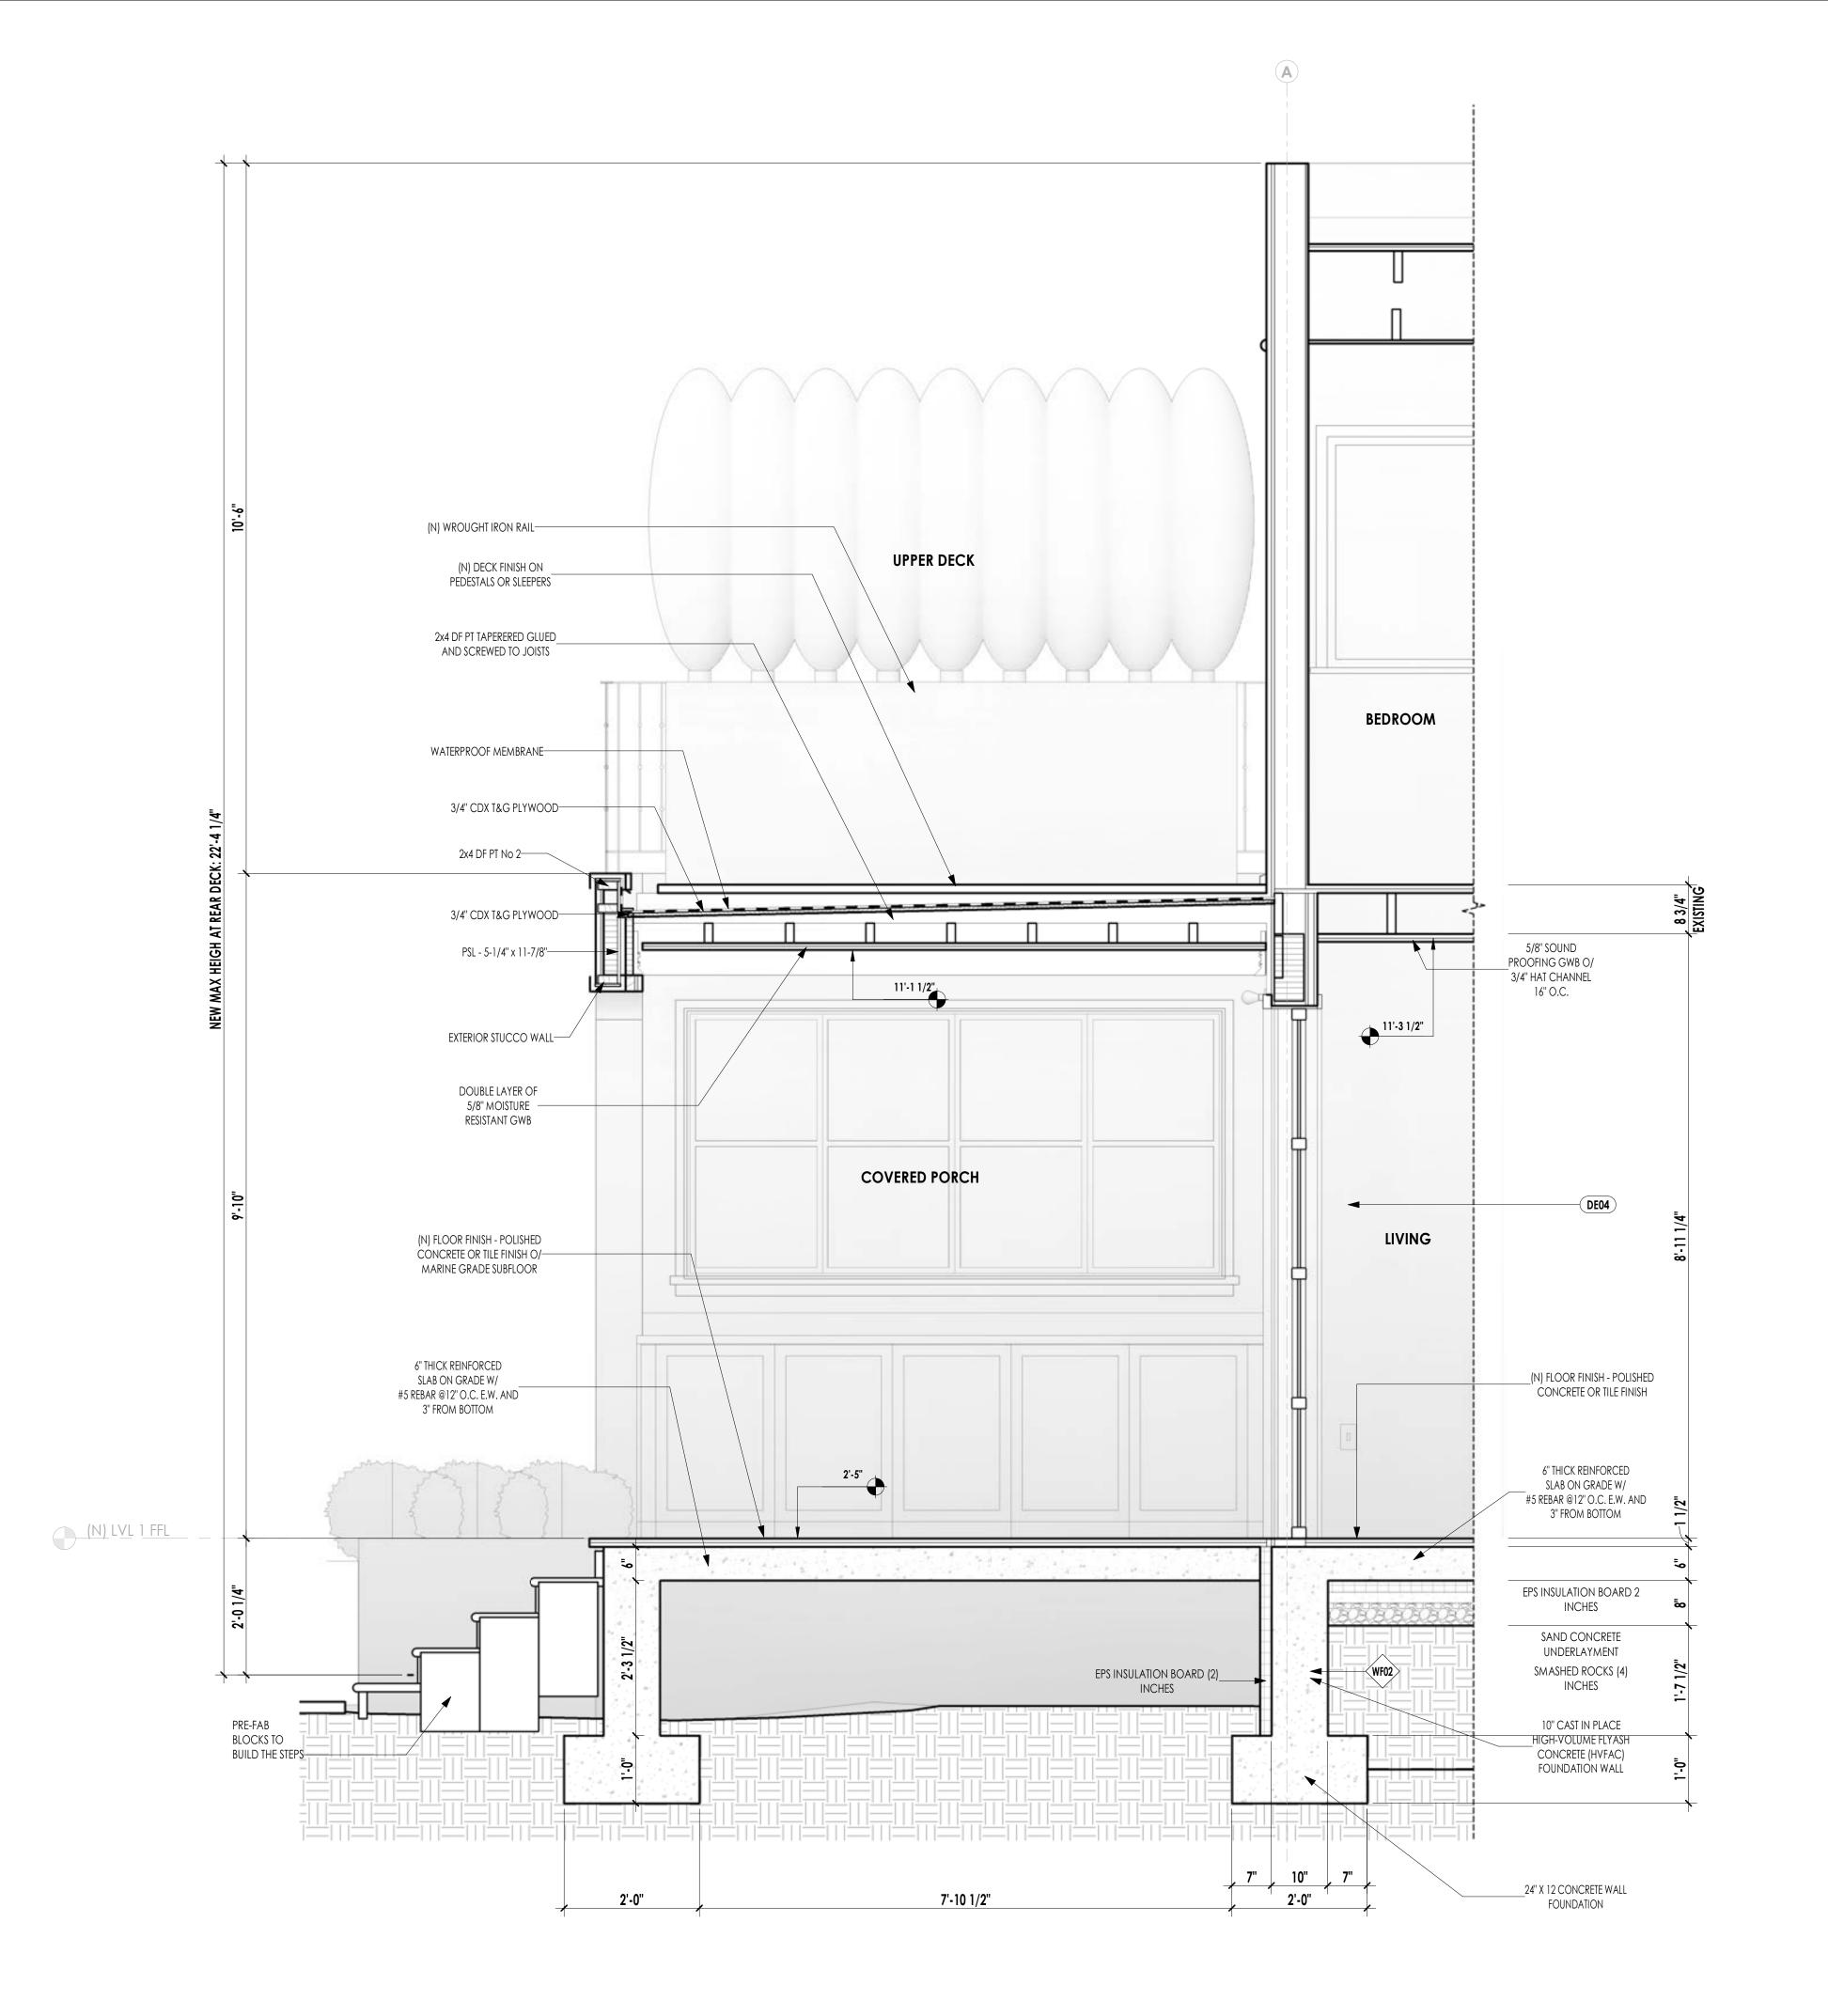
41 Poplar Kitchen Remodel


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Scale:	As Noted

Sheet Title

(N) EXTERIOR STAIR DETAILS





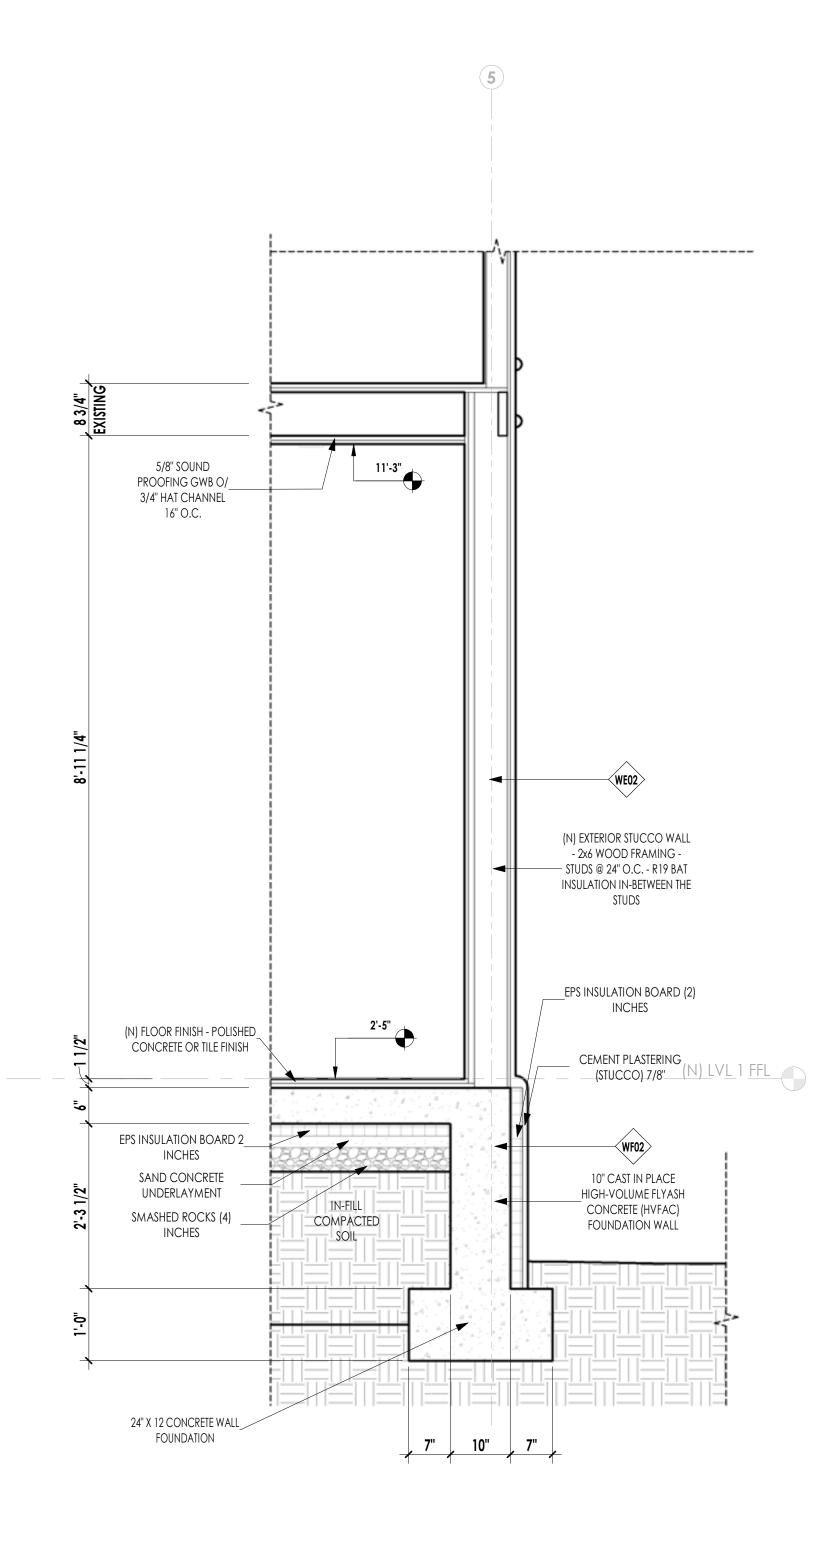

CRAFTED EARTH, INC. ENGINEERING & DESIGN

166 Alpine Street San Rafael, CA 94901 Tel. 415.699.9662 info@craftedearth.com





Michael and Mindy Whittington

41 Poplar Ave Ross, CA 94957

APN:073-273-04

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2 TOWN COUNCIL 03/02/23 1 CITY COMMENTS REV 1 01/11/23 Date Description

41 Poplar Kitchen Remodel

02/03/23 Date: Scale: As Noted

Sheet Title

ARCHITECTURAL DETAILS




(WI04)


EXTERIOR

- 5/8" TYPE-X GWB
- 1X Wood Framing2"X4" Wood Framing
- 1x Wood Framing


• 5/8" Non-Paper Faced Moisture Resistant GWB

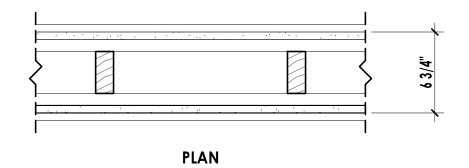


FIRE RATING:

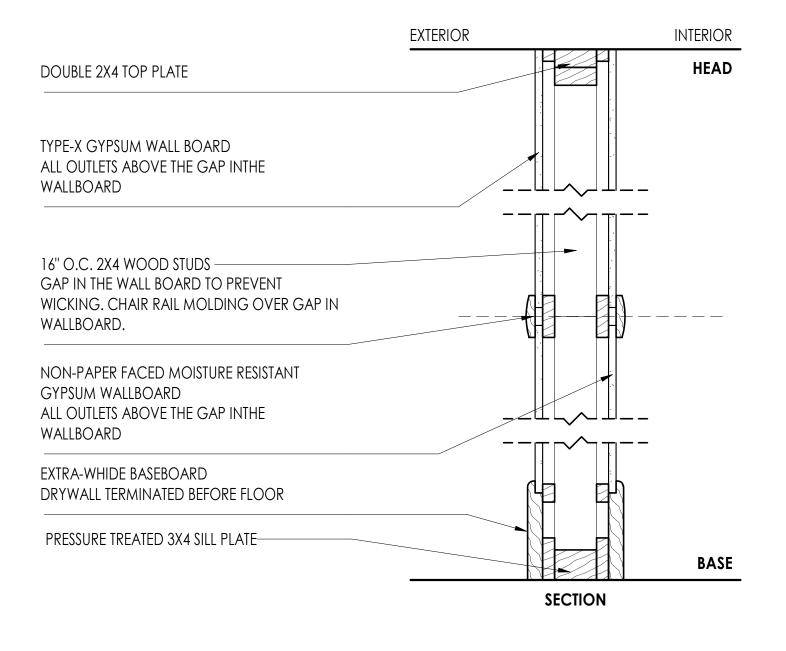

(WI05)

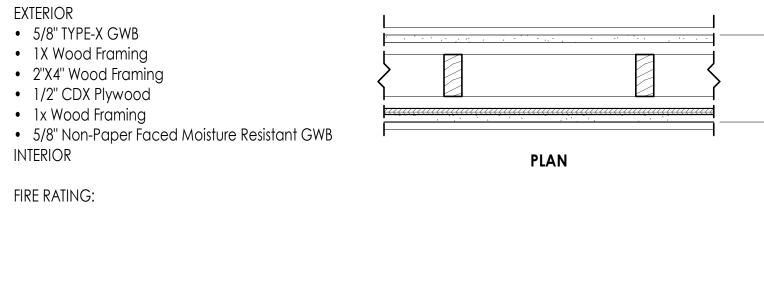

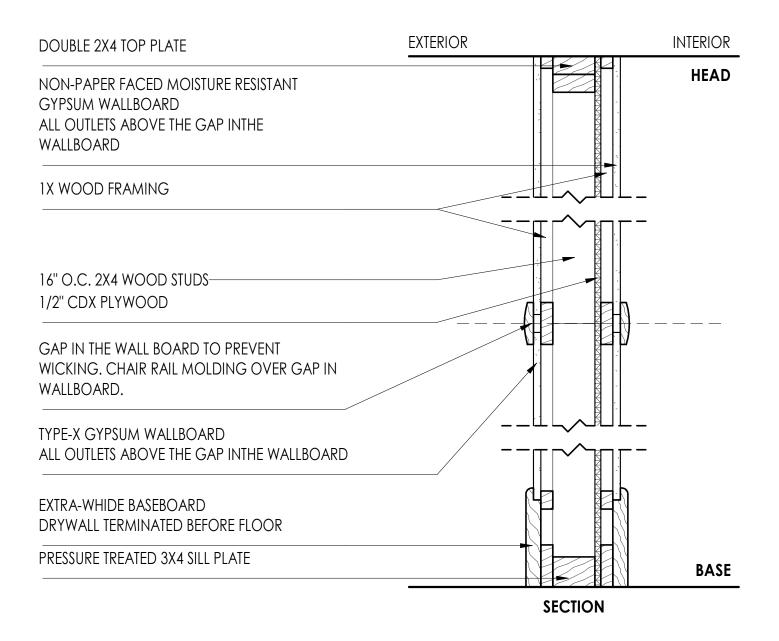

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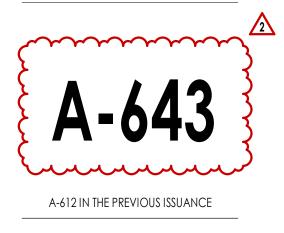
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Rev	Description	Date
1	CITY COMMENTS REV 1	01/11/23
2	TOWN COUNCIL	03/02/23

41 Poplar Kitchen Remodel


Date: 02/03/23 Scale: As Noted Sheet Title


WALL ASSEMBLIES



WF02

EXTERIOR • 20" CAST IN PLACE HIGH-VOLUME FLYASH CONCRETE (HVFAC) INTERIOR

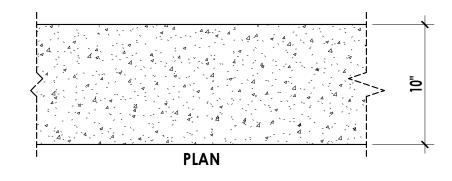


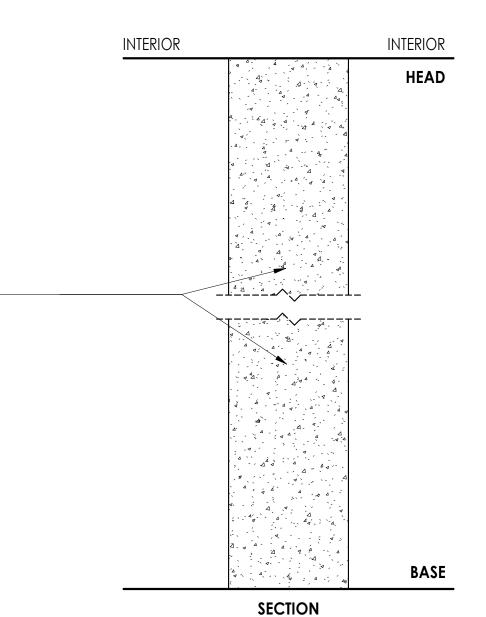


CAST IN PLACE HIGH-VOLUME FLYASH CONCRETE (HVFAC)

WE02


- EXTERIOR
- 7/8" Hard Coat Stucco 1/2" CDX Plywood
- 2"X6" Wall Framing With Bat R19 Insulation
- 1"X Wall Framing
- 5/8" Paperless Moisture Resistant GWB INTERIOR

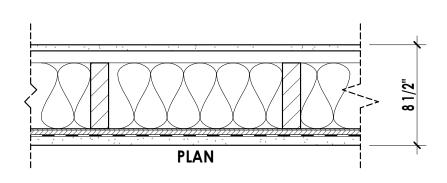

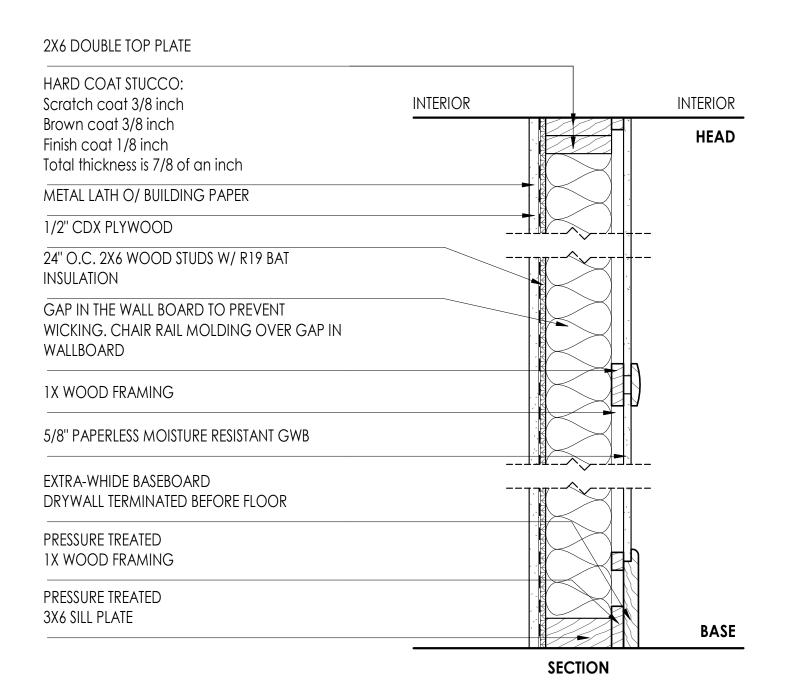

WF03

EXTERIOR • 12" CAST IN PLACE HIGH-VOLUME FLYASH CONCRETE (HVFAC) INTERIOR

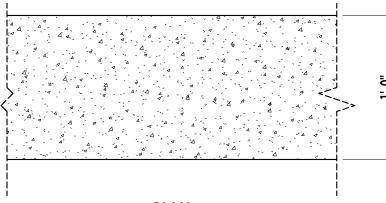

INTERIOR

HEAD

BASE

PLAN

______ . , ≰_____ .

SECTION

A . . A ..

INTERIOR



- 7/8" Hard Coat Stucco 1/2" CDX Plywood
- 2"X6" Wall Framing 1"X Wall Framing
- 5/8" Paperless Moisture Resistant GWB INTERIOR

2X6 DOUBLE TOP PLATE

HARD COAT STUCCO: Scratch coat 3/8 inch Brown coat 3/8 inch Finish coat 1/8 inch Total thickness is 7/8 of an inch

METAL LATH O/ BUILDING PAPER

1/2" CDX PLYWOOD

24" O.C 2X6 WOOD STUDS

GAP IN THE WALL BOARD TO PREVENT WICKING. CHAIR RAIL MOLDING OVER GAP IN Wallboard

1X WOOD FRAMING

5/8" PAPERLESS MOISTURE RESISTANT GWB

EXTRA-WHIDE BASEBOARD DRYWALL TERMINATED BEFORE FLOOR PRESSURE TREATED 1X WOOD FRAMING

PRESSURE TREATED 2X6 SILL PLATE

WE04

- EXTERIOR • 7/8" Hard Coat Stucco
- 1/2" CDX Plywood • 2"X4" Wall Framing
- 1/2" CDX Plywood
- 7/8" Hard Coat Stucco INTERIOR
- 2X4 DOUBLE TOP PLATE HARD COAT STUCCO: Scratch coat 3/8 inch Brown coat 3/8 inch Finish coat 1/8 inch Total thickness is 7/8 of an inch

METAL LATH O/ BUILDING PAPER

1/2" CDX PLYWOOD

16" O.C. 2X4 WOOD STUDS

PRESSURE TREATED 3X4 WOOD FRAMING


CAST IN PLACE HIGH-VOLUME FLYASH CONCRETE (HVFAC)


WE03

EXTERIOR

- 7/8" Hard Coat Stucco
- 1/2" CDX Plywood
- 2"X4" Wall Framing 1/2" CDX Plywood
- 7/8" Hard Coat Stucco

INTERIOR

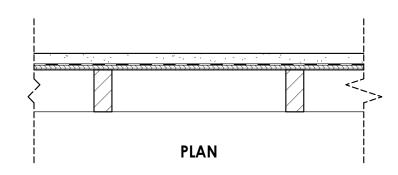

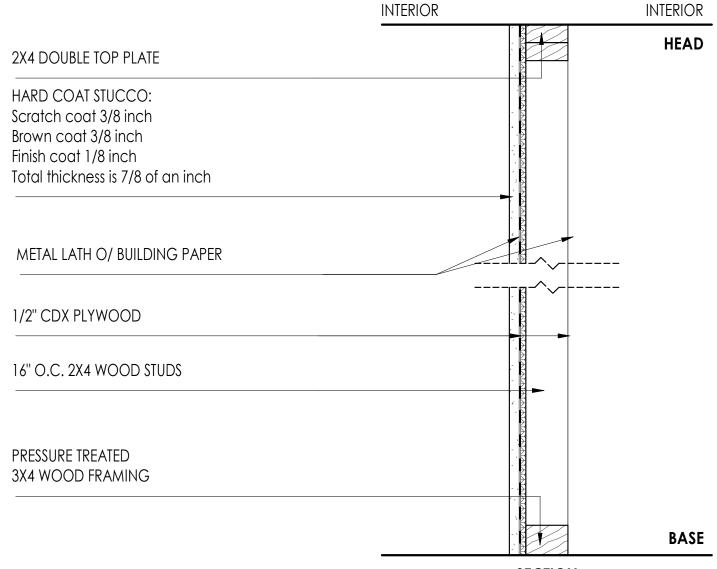

SECTION

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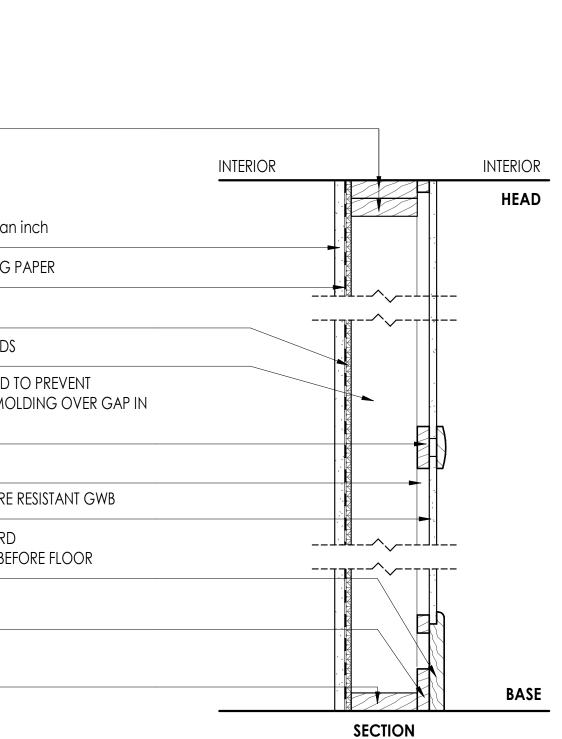
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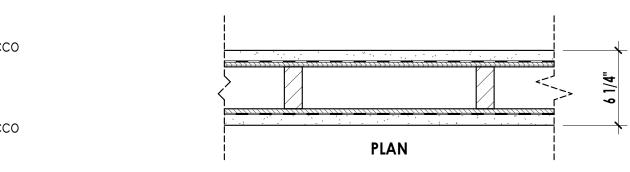
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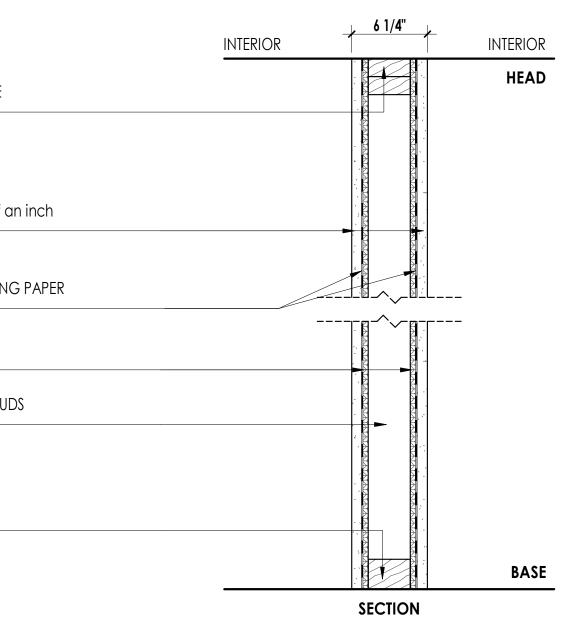
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PLAN






2	TOWN COUNCIL	03/02/23
1	CITY COMMENTS REV 1	01/11/23
Rev	Description	Date
41 Po Remo	plar Kitchen odel	
Date:	2/03/23	

As Noted Scale: Sheet Title


WALL ASSEMBLIES

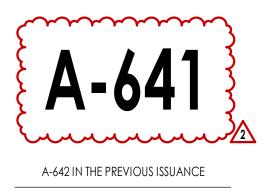


WE05

EXTERIOR

- 7/8" Hard Coat Stucco
- 1/2" CDX Plywood • 2"X6" Wall Framing
- 1/2" CDX Plywood
- 7/8" Hard Coat Stucco INTERIOR

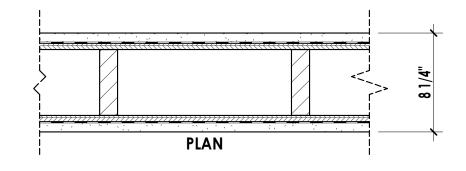


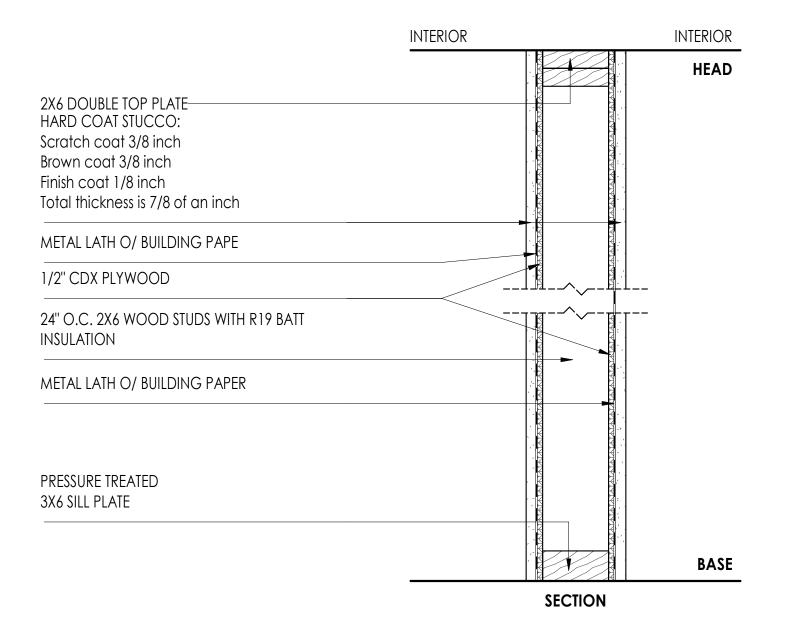


WI01

EXTERIOR

- 5/8" Non-Paper Faced Moisture Resistant GWB 1X Wood Framing
- 2"X4" Wood Framing
- 1x Wood Framing
- 5/8" PNon-Paper Faced Moisture Resistant GWB INTERIOR

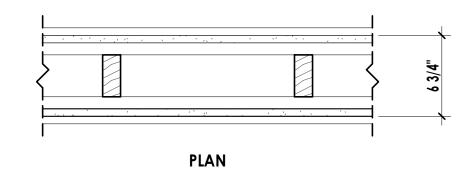


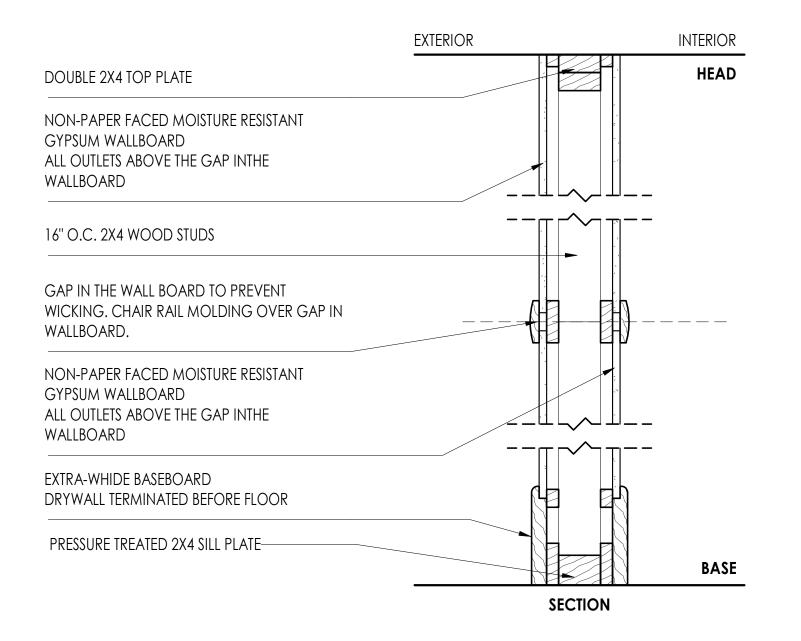

WE06

- EXTERIOR • 7/8" Hard Coat Stucco
- 1/2" CDX Plywood
- 2"X6" Wall Framing With R19 Bat Insulation
- 1/2" CDX Plywood
- 7/8" Hard Coat Stucco



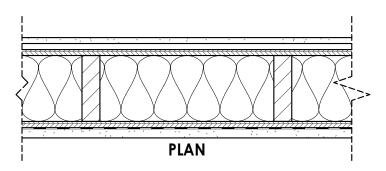

2X6 DOUBLE TOP PLATE


HARD COAT STUCCO:		
Scratch coat 3/8 inch	INTERIOR	INTERIOR
Brown coat 3/8 inch		HEAD
Finish coat 1/8 inch		
Total thickness is 7/8 of an inch		
METAL LATH O/ BUILDING PAPER		
1/2" CDX PLYWOOD		
24" O.C. 2X6 WOOD STUDS W/ R19 BAT		
INSULATION		
GAP IN THE WALL BOARD TO PREVENT		
WICKING, CHAIR RAIL MOLDING OVER GAP IN		
WALLBOARD		
		·
1X WOOD FRAMING		
5/8" PAPERLESS MOISTURE RESISTANT GWB		
EXTRA-WHIDE BASEBOARD		
DRYWALL TERMINATED BEFORE FLOOR		
PRESSURE TREATED		
1X WOOD FRAMING		
PRESSURE TREATED	/ - Z	
3X6 SILL PLATE		
		BASE

SECTION


(WI02)

EXTERIOR

- 5/8" TYPE-X GWB
- 1X Wood Framing
- 2"X4" Wood Framing W/ R13 Batt Insulation 1x Wood Framing
- 5/8" Non-Paper Faced Moisture Resistant GWB INTERIOR

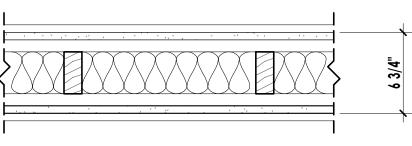

PLAN

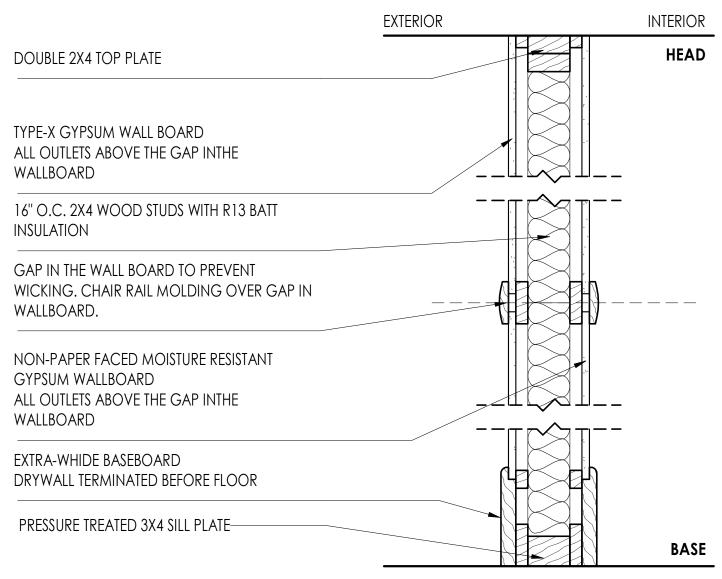

1/2" CDX Plywood 1x Wood Framing

WI03

EXTERIOR

• 5/8" Non-Paper Faced Moisture Resistant GWB INTERIOR

1X Wood Framing

• 2"X4" Wood Framing

INTERIOR EXTERIOR HEAD _____ _ _ _ _ _ ____ ╼╇┟┟ BASE

16" O.C. 2X4 WOOD STUDS 1/2" CDX PLYWOOD PRESSURE TREATED 3X4 SILL PLATE

DOUBLE 2X4 TOP PLATE NON-PAPER FACED MOISTURE RESISTANT GYPSUM WALLBOARD ALL OUTLETS ABOVE THE GAP INTHE WALLBOARD GAP IN THE WALL BOARD TO PREVENT WICKING. CHAIR RAIL MOLDING OVER GAP IN WALLBOARD. NON-PAPER FACED MOISTURE RESISTANT GYPSUM WALLBOARD ALL OUTLETS ABOVE THE GAP INTHE WALLBOARD 1X WOOD FRAMING EXTRA-WHIDE BASEBOARD DRYWALL TERMINATED BEFORE FLOOR



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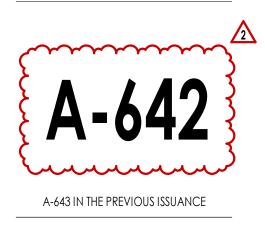
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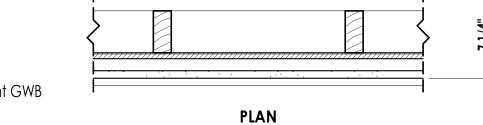
• 5/8" Non-Paper Faced Moisture Resistant GWB

2 TOWN COUNCIL 03/02/23 1 CITY COMMENTS REV 1 01/11/23 Date Description 41 Poplar Kitchen Remodel 02/03/23 Date:

As Noted Scale: Sheet Title

WALL ASSEMBLIES





				E	XISTING	WINDOWS					
Type Mark	Mark	Description			ENSIONS		- ROOM -	GLAZING		EGRESS (Y/N)	
			Width	Height	Area	SILL		Spec.	Tempered (Y/N)		
WN01	WN01.1	WINDOW	2' - 6''	3' - 9"	9.4 SF	3' - 2''					
WN02	WN02.1	WINDOW	2' - 8''	3' - 6''	9.3 SF	3' - 4''					
WN02	WN02.2	WINDOW	2' - 8''	3' - 6''	9.3 SF	3' - 4''					
WN02	WN02.3	WINDOW	2' - 8''	3' - 6''	9.3 SF	3' - 4''					
WN03	WN03.1	SINGLE AWNING	3' - 0''	2' - 0''	6.0 SF	5' - 0 1/2"					
WN04	WN04.1	WINDOW	2' - 5''	3' - 0''	7.3 SF	3' - 8''					
WN05	WN05.1	DOUBLE HUNG	2' - 0''	3' - 0''	6.0 SF	3' - 6 1/4''					
WN05	WN05.2	DOUBLE HUNG	2' - 0''	3' - 0''	6.0 SF	3' - 6''					
WN05	WN05.4	DOUBLE HUNG	1' - 9''	2' - 6''	4.4 SF	3' - 10''					
WN05	WN05.6	DOUBLE HUNG	2' - 0''	3' - 0''	6.0 SF	3' - 6 1/4''					
WN06	WN06.1	FIXED - SINGLE	2' - 0''	3' - 6''	7.0 SF	3' - 3"					
WN07	WN07.1	FIXED SINGLE	1' - 9''	2' - 9''	4.8 SF	3' - 3"					
WN08	WN08.4	WINDOW	3' - 10''	4' - 0''	15.3 SF	2' - 8''					
WN08	WN08.5	WINDOW	3' - 10''	4' - 0''	15.3 SF	2' - 6 5/8"					
WN08	WN08.6	WINDOW	3' - 10''	4' - 0''	15.3 SF	2' - 6 5/8"					
WN09	WN09.1	CASEMENT DOUBLE	5' - 4''	4' - 0''	21.3 SF	3' - 0''					
WN10	WN10.1	WINDOW 3 PANELS	11' - 4"	5' - 8''	64.2 SF	1' - 2"					
WN11	WN11.1	FIXED SINGLE	3' - 8''	2' - 9''	10.1 SF	3' - 1 1/2"					
WN13	WN13.1	TRIPLE XXO CASEMENT WINDOW	6' - 0''	3' - 4''	20.0 SF	3' - 4''					
WN14	WN14.1	WINDOW	7' - 10''	3' - 6''	27.4 SF	3' - 4''					
WN16	WN16.1	LOUVERS	1' - 2''	0' - 6''	0.6 SF	0' - 8''					
WN16	WN16.2	LOUVERS	1' - 2''	0' - 6''	0.6 SF	6' - 5 1/4''					
WN17	WN17.1	WINDOW	5' - 0''	3' - 5"	17.1 SF	3' - 1 1/2"					
WN18	WN18.1	WINDOW	5' - 10 1/2''	4' - 5''	25.9 SF	2' - 5''					
WN18	WN18.2	WINDOW	5' - 10 1/2"	4' - 5''	25.9 SF	2' - 5''					
5					344.0 SF						

	EXISTING WINDOWS TO BE DEMOLISHED												
	Mark	Description		DIN			- ROOM -	G	LAZING				
Type Mark	Mark	Description	Width	Height	Area	SILL	ROOM -	Spec.	Tempe				
WN03	WN03.1	SINGLE AWNING	3' - 0''	2' - 0''	6.0 SF	5' - 0 1/2"							
WN05	WN05.1	DOUBLE HUNG	2' - 0''	3' - 0''	6.0 SF	3' - 6 1/4''							
WN05	WN05.2	DOUBLE HUNG	2' - 0''	3' - 0''	6.0 SF	3' - 6"							
WN05	WN05.6	DOUBLE HUNG	2' - 0''	3' - 0''	6.0 SF	3' - 6 1/4"							
WN06	WN06.1	FIXED - SINGLE	2' - 0''	3' - 6''	7.0 SF	3' - 3"							
WN07	WN07.1	FIXED SINGLE	1' - 9''	2' - 9''	4.8 SF	3' - 3''							
WN09	WN09.1	CASEMENT DOUBLE	5' - 4''	4' - 0''	21.3 SF	3' - 0''							
WN11	WN11.1	FIXED SINGLE	3' - 8''	2' - 9''	10.1 SF	3' - 1 1/2"							
WN13	WN13.1	TRIPLE XXO CASEMENT WINDOW	6' - 0''	3' - 4''	20.0 SF	3' - 4''							
WN16	WN16.1	LOUVERS	1' - 2"	0' - 6''	0.6 SF	0' - 8''							
WN16	WN16.2	LOUVERS	1' - 2"	0' - 6''	0.6 SF	6' - 5 1/4''							
11					88.4 SF								

	NEW WINDOWS										
Type Mark	Mark	Description		DIM			ROOM	GI	AZING	EGRESS (Y/N)	
	Mark	Description	Width	Height	Area	SILL	KOOM	Spec.	Tempered (Y/N)		
WN19	WN19.1	SKYLIGHT	2' - 0''	4' - 0''	8.0 SF		STAIR	Low - E 2	Yes	No	
WN20	WN20.1	CASEMENT 24 X 54 WITH SCREENS	4' - 0''	4' - 6''	18.0 SF	3' - 0''	HALL	Low - E 2	Yes	No	
WN20	WN20.2	CASEMENT 24 X 54 WITH SCREENS	4' - 0''	4' - 6''	18.0 SF	3' - 0''	BEDROOM #1	Low - E 2	Yes	No	
WN20	WN20.3	CASEMENT 24 X 54 WITH SCREENS	4' - 0''	4' - 6''	18.0 SF	3' - 0''	HALL	Low - E 2	Yes	No	
WN21	WN21.1	CASEMENT 68 x 48	5' - 8''	4' - 0''	22.7 SF	3' - 0''	BEDROOM #2	Low - E 2	No	Yes	
WN23	WN23.1	DOUBLE HUNG WINDOW	2' - 0''	4' - 0''	8.0 SF	3' - 0''	BEDROOM #2	Low - E 2	No	No	
WN25	WC25.1	CASEMENT 24 X 54 WITH SCREENS	8' - 0''	4' - 0''	32.0 SF	2' - 0 1/16"	COVERED PORCH	Low - E 2	No	No	
WN26	WN22.1		5' - 10 1/2"	4' - 0''	23.5 SF	2' - 8 27/32''				Yes	
8					148.2 SF						

EXISTING EXTERIOR DOORS

	TAG	– DESCRIPTION							ROOI	٨
Туре	Mark	DESCRIPTION	Width	Height	Thickness	Area	% Glazed	Glass Area	From	То
DE01	DE01.1	SWING HALF GLASS	3' - 0''	6' - 8''	0' - 1 1/2"	20.0 SF	50%	10.0 SF		
DE02	DE02.1	SWING 2-PANEL FRENCH DOOR OX	5' - 4''	6' - 8''	0' - 0 3/4''	35.6 SF	80%	28.4 SF		
DE03	DE03.1	GARAGE DOO	9' - 6''	6' - 6''	0' - 1 1/2"	61.8 SF	0%	0.0 SF		
DE06	DE06.1	SWING DOUBLE	5' - 4''	6' - 8''	0' - 1 3/4"	35.6 SF	0%	0.0 SF		
DI05	DE09.1	SINGLE SWING WITH SIDE LIGHT	3' - 0''	6' - 8''	0' - 2''	20.0 SF				
5						172.9 SF		38.4 SF		

EXISTING EXTERIOR DOORS TO BE DEMOLISHED

TAG		- DESCRIPTION	DIMENSIONS						ROOM	
Туре	Mark	DESCRIPTION	Width	Height	Thickness	Area	% Glazed	Glass Area	From	То
DE01	DE01.1	SWING HALF GLASS	3' - 0''	6' - 8''	0' - 1 3/8''	20.0 SF	50%	10.0 SF		
DE02	DE02.1	SWING 2-PANEL FRENCH DOOR OX	5' - 4''	6' - 8''	0' - 0 3/4''	35.6 SF	80%	28.4 SF		
DE03	DE03.1	GARAGE DOO	9' - 6''	6' - 6''	0' - 1 1/2''	61.8 SF	0%	0.0 SF		
						117.3 SF		38.4 SF		

NEW EXTERIOR DOORS

	TAG	DESCRIPTION			DIMEN	ROOM				
Туре	Mark	DESCRIPTION	Width	Height	Thickness	Area	% rGlazed	Glass Area	From	То
DE04	DE04.1	SLIDING (4) PANELS OXXO	11' - 6"	7' - 10''	0' - 2 1/2''	90.1 SF	90%	81.1 SF	LIVING	COVERED PORCH
DI18	DE05.1		9' - 0''	9' - 3''	0' - 1 1/2''	83.3 SF	0%	0.0 SF	GARAGE	
2						173.3 SF		81.1 SF		

NOTES WINDOWS & DOORS

1 - GENERAL NOTES	
1.01	ALL EXTERIOR WINDOWS IN CONDITIONED SPACE TO BE NFRC RATED, CLEAR TEMPERED GLASS, DUAL GLAZED NOTED.
1.02	CONTRACTOR TO VERIFY DIMENSIONS PRIOR TO ORDERING ALL WINDOWS AND DOORS.
1.03	WINDOWS AND EXTERIOR DOORS ARE VIEWED FROM THE EXTERIOR.
1.04	DIMENSIONS IN DRAWINGS, U.O.N, ARE TYPICALLY AS FOLLOWS: INTERIOR DOORS: LEAF SIZE EXTERIOR SWING DOORS: LEAF SIZE EXTERIOR PIVOT DOOR: OUTSIDE OF FRAME GARAGE DOOR: OPENING SIZE (SIZE DOOR OVERLAP PER MFR'S TRACK REQUIREMENTS) LIFT AND SLIDE: OPENING SIZE LIFT AND SLIDE POCKET: OPENING SIZE
1.05	BATHROOMS, WATER CLOSET COMPARTMENTS, AND OTHER SIMILAR ROOMS SHALL BE PROVIDED WITH AN AG MUST BE OPERABLE. CRC R303.3.
1.06	ALL WINDOWS IN SHOWERS WHERE THE BOTTOM EXPOSED EDGE OF THE GLAZING IS LESS THAN 60" ABOVE TH
1.07	DOOR THRESHOLD HEIGHT IS LIMITED TO .75" AT SLIDING DOORS AND .5" AT ALL OTHER DOORS. AT THE FRON THE MAXIMUM HEIGHT TO THE THRESHOLD OF AN EXTERIOR DOOR OF A RESIDENCE IS 7.75" (CBC 1008.1.6).

EGRESS (Y/N) Tempered (Y/N)

DUAL GLAZED, LOW-E, U-FACTOR MAX. 0.32 7 SHGC MAX. 0.25, WOOD SASH & FRAME, UNLESS OTHERWISE

D WITH AN AGGREGATE GLAZING AREA IN WINDOWS OF NOT LESS THAN 3 SQUARE FEET, ONE-HALF OF WHICH

" ABOVE THE ADJACENT STANDING SURFACE SHALL BE SAFETY GLAZING. CRC SECTION R308.4.5

T THE FRONT DOOR OF A RESIDENCE, THERE MAY BE A SINGLE STEP WITH A MAXIMUM RISE OF 7" (CBC 1003.5).

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2 TOWN COUNCIL 03/02/23 1 CITY COMMENTS REV 1 01/11/23 Rev Description Date


41 Poplar Kitchen Remodel

02/03/23 Date:

Scale: As Noted Sheet Title

WINDOW & DOOR SCHEDULES



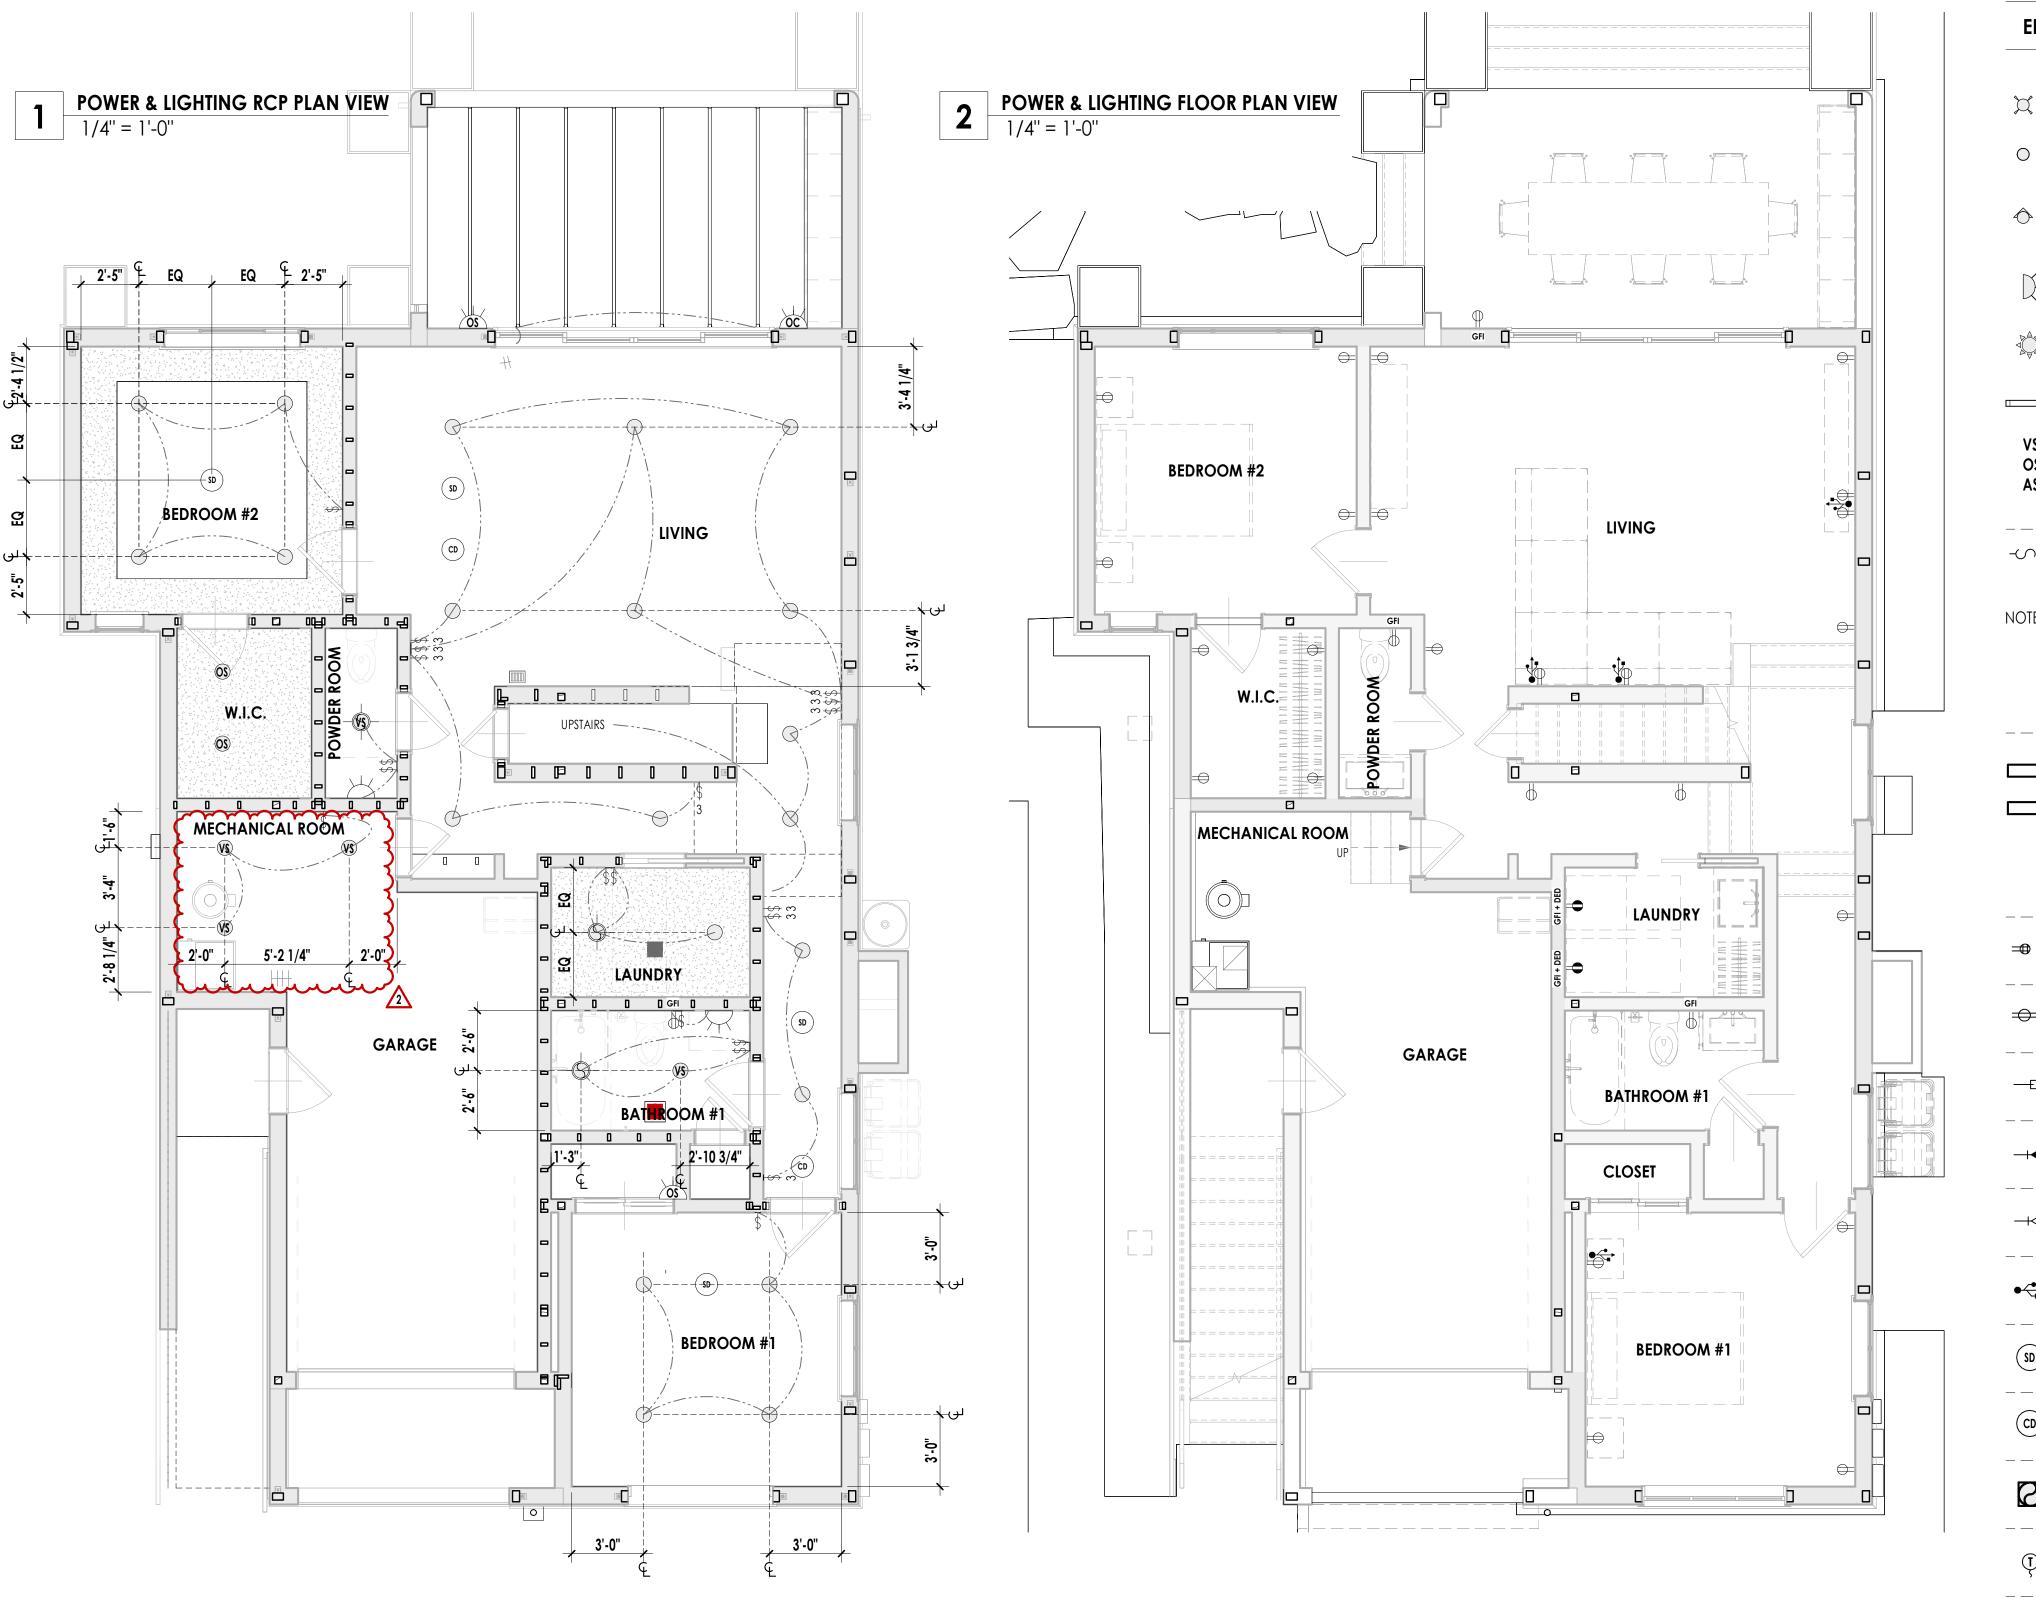

NOTES CEILINGS

1 - GENERAL NOTES

SCALES AS STATED ARE VALID ON THE ORIGINAL DRAWING ONLY. DO NOT SCALE FROM THESE DRAWINGS. WRITTEN DIMENSIONS TAKE PRECEDENCE OVER GRAPHIC PRESENTATION. DETAIL DIMENSIONS TAKE PRECEDENCE OVER PLAN DIMENSIONS. 1.01

NOTIFY DESIGNER OF ANY DIMENSIONAL DISCREPANCIES. ANY MODIFICATIONS OF DEVIATION TO BE BROUGHT TO THE ATTENTION OF THE DESIGNER FOR REVIEW AND APPROVAL. 1.02

CONTRACTOR TO COORDINATE WITH DESIGNER IF ANY LOCATION OF LIGHT FIXTURES OR DEVICES ARE NOT SHOWN DIMENSIONALLY PRIOR TO INSTALLATION. 1.03

CONTRACTOR TO COORDINATE WITH DESIGNER IN FIELD FOR MOUNTING HEIGHT OF ALL DECORATIVE PENDANT FIXTURES. 1.04

MECHANICAL AND ELECTRICAL CONTRACTOR SHALL COORDINATE WORK BETWEEN THE ENGINEERING AND ARCHITECTURAL CEILING PLAN SHALL GOVERN WITH RESPECT TO AESTHETIC CONSIDERATIONS, QUANTITY, LOCATIONS FOR FIXTURES, DEVICES, ETC. 1.05 CONTRACTOR SHALL BE RESPONSIBLE FOR VERIFICATIONS OF QUANTITIES (NEW OR EXISTING) INDICATED ON PLANS.

MECHANICAL AND ELECTRICAL CEILING PLAN SHALL GOVERN WITH RESPECT TO FUNCTIONAL CONSIDERATIONS AND OVERALL SCOPE OF WORK. 1.06

DOWNLIGHTS (INCANDESCENT OR LOW VOLTAGE) SHALL BE ON A SINGLE DIMMER RESPECTIVELY. ALL WALL WASHERS SHALL BE ON DIMMERS PER ARCHITECT'S INSTRUCTION. 1.07

SUBMITTALS ON ALL FIXTURES ARE REQUIRED PRIOR TO ORDERING. 1.08

ELECTRICAL/MECHANICAL LEGEND

X	HIGH EFFICACY OR LED SURFACE MOUNT OR PENDANT LAMP
0	HIGH EFFICACY OR LED RECESSED LED DOWN LIGHT, LOW VOLTAGE 4" ADJUSTABLE TEMPERATURE HALO RECESSED CAN U.O.N.
\Diamond	HIGH EFFICACY OR LEDRECESSED LED WALL WASHER LOW VOLTAGE 4" ADJUSTABLE TEMPERATURE HALO RECESSED CAN U.O.N.
Ď-	HIGH EFFICACY OR LED WALL MOUNTED LIGHTING FIXTURE
	TUBULAR SKYLIGHT WITH LIGHTING FIXTURE
	UNDER CABINET LED STRIP, LOW VOLTAGE
VS OS AS	CONTROLLED BY VACANCY SENSOR CONTROLLED BY OCCUPANCY SENSOR CONTROLLED BY ASTRONOMICAL TIME CLOCK OR BY BOTH A MOTION SENSOR AND PHOTCHELL
	LIGHT SWITCH @ 42" A.F.F. TYP., LUTRON DIVA CL SCREWLESS FACEPLATES, U.O.N.
NOTE 1	WHITE SATIN FINISH W/ ROCKER SWITCH D = W/ DIMMER R = REOSTAT FAN SPEED CONTROL O = OCCUPANCY SENSOR P = PHOTOCELL D = DIMMER
	 120V (N) DUPLEX RECEPTACLE @ 18" A.F.F. TYP. OR 42" A.F.F. @ COUNTER TOPS, U.O.N., WHITE SATIN FINISH 240V WITH SCREWLESS FACEPLATES:
	H = HORIZ. GFI = GFI PROTECTION WP = WATER PROOF
	(N) FOURPLEX RECEPTACLE @ 18" A.F.F. HORIZ. TYP., U.O.N.; $\mathbf{H} = \text{HORIZ.}; \mathbf{G} = \text{GFI PROTECTION}; \mathbf{WP} = \text{WATER PROOF}$
	FLOOR OUTLET - FLUSH BOX, BRASS W/ COVER
— D	TV CABLE
_+◀	TELEPHONE RJ11 JACK
\dashv	DATA JACK (VERIFY CABLE TYPE)
●	USB CHARGING PORT
SD	SMOKE DETECTOR, INTERCONNECTED & HARD WIRED, ALARMS SHALL COMPLY WITH CBC 2010 SECTION 420.1.
	CARBON MONOXIDE DETECTOR, INTERCONNECTED & HARD WIRED, ALARMS SHALL COMPLY WITH CBC 2010 SECTION 420.1.
	EXHAUST FAN/LIGHT/HEAT LAMP WITH HUMIDITY CONTROL, 50 C.F.M. MIN E = ENERGY RECOVERY VENTILATION
Ţ	
-+	HOSE FAUCET
X	SPRINKLER HEAD
	CEILING MOUNTED FAN

- HIGH EFFICACY OR LED SURFACE MOUNT OR PENDANT LAMP
 - LED DOWN LIGHT, PERATURE HALO RECESSED CAN
 - LED WALL WASHER PERATURE HALO RECESSED CAN
 - JNTED LIGHTING FIXTURE
 - FIXTURE
 - /OLTAGE

 - NSOR TIME CLOCK OR BY BOTH A MOTION
 - TRON DIVA CL SCREWLESS
 - /ITCH
 - CLE @ 18" A.F.F. TYP. OR 42" PS, U.O.N., WHITE SATIN FINISH eplates:

- _____ A.F.F. HORIZ. TYP., U.O.N.; **WP** = WATER PROOF
- _____ W/ COVER

- _____ NTERCONNECTED & HARD VITH CBC 2010 SECTION 420.1
- ----ITH HUMIDITY CONTROL, 50 ERY VENTILATION

NOTES ELECTRICAL

1 - GENERAL NOTES

- 1.01 PER CBC 504.1 ALL EQUIPMENT AND APPLIANCES PROVIDED BY THE BUILDER SHALL BE ENERGY STAR LABELED IF ENERGY STAR IS APPLICABLE TO THAT EQUIPEMENT OR APPLIANCE. 1.02 INSTALL MULTI-GANG WALL SWITCHES IN THE SAME
- CONFIGURATION AS SHOWN ON PLANS.
- **1.03** PROVIDE APPROPRIATE OUTLETS FOR ALL APPLIANCES.
- **1.04** EXISTING SMOKE ALARMS THAT ARE MORE THAN 10 YEARS OLD TO BEREPLACED. SECTION R314.3.2. SMOKE ALARMS SHALL BE INSTALLED IN EVERY ROOM USED FOR SLEEPING PURPOSES, ON THE WALL OR CEILING OUTSIDE OF EACH SLEEPING AREA (E.G. BEDROOMS), AND IN EVERY STORY OF THE DWELLING UNIT. IN ADDITION, A SMOKE ALARM IS REQUIRED INSIDE EACH BEDROOM. CRC R314.
- 1.05 CARBON MONOXIDE DETECTORS SHALL BE INSTALLED IN ALL PATHWAYS LEADING TO THE SLEEPING AREA AND ON EACH LEVEL OF THE DWELLING. CRC R315.
- **1.06** SPECIFICATIONS FOR ELECTRICAL DEVICES INSTALLED IN DWELLINGS: CEC ARTICLE 210 & 406 A) TAMPER RESISTANT RECEPTACLES FOR ALL LOCATIONS DESCRIBED IN 210.52 (I.E., ALLRECEPTACLES IN A DWELLING) B) WEATHER RESISTANT TYPE FOR RECEPTACLES INSTALLED IN DAMP OR WET LOCATIONS OUTSIDE). C) ARC-FAULT PROTECTION FOR ALL OUTLETS (NOT JUST RECEPTACLES) LOCATED IN ROOMS DESCRIBED IN NEC 210.8(A): FAMILY, LIVING, BEDROOMS, DINING, HALLS, ETC.
- **1.07** PER CEC ARTICLE 210.11(C)3, BATHROOM CIRCUITING SHALL BE EITHER: A) A 20 AMPERE CIRCUIT DEDICATED TO EACH BATHROOM, OR B) AT LEAST ONE 20 AMPERE CIRCUIT SUPPLYING ONLY
- BATHROOM RECEPTACLE OUTLETS. **1.08** ELECTRICAL RECEPTACLES MUST BE INSTALLED SO THAT NO
- POINT ALONG THE FLOOR LINE IN ANY WALL SPACE IS MORE THAN 6', MEASURED HORIZONTALLY, FROM AN OUTLET. THIS INCLUDES ANY WALL SPACE OF 2' OR MORE IN LENGTH. (CEC 210.52(A))
- **1.09** OUTDOOR LIGHTING IS TO BE HIGH EFFICACY THAT IS CONTROLLED BY ONE OF THE FOLLOWING PER CA ENERGY CODE SEC. 150.0(k)3A: PHOTOCONTROL & MOTION SENSOR; PHOTOCONTROL AND AUTOMATIC TIME SWITCH CONTROL; ASTRONOMICAL TIME SWITCH CONTROL; ENERGY MANAGEMENT CONTROL SYSTEM.
- 1.10 ADDRESS NUMBERS MUST BE IN PLACE ADJACENT TO THE FRONT DOOR AND MUST BE AT LEAST 4" TALL AND A MINIMUM OF 1/2" STROKE. IF NOT CLEARLY VISIBLE FROM THE STREET, ADDITIONAL NUMBERS ARE REQUIRED AT THE EDGE OF THE PROPERTY AND AT THE FRONT DOOR. RESIDENTIAL NUMBERS MUST BE INTERNALLYILLUMINATED (BACKLIT) OR ILLUMINATED BY AN ADJACENT LIGHT WHICH MUST BE CONTROLLED BY A PHOTOCELL AND SWITCHED ONLY BY A BREAKER SO IT WILL REMAIN ILLUMINATED ALL NIGHT. THIS LIGHT MUST NOT HAVE A SCREW-BASE SOCKET AND MUST CONSUME NO MORE THAN 5 WATTS OF POWER AND MAY NOT BE USED FOR GENERAL PORCH ILLUMINATION.
- 2 KITCHENS
- 1.11 KITCHENS

A) ALL KITCHEN LIGHTS TO BE HIGH EFFICACY. EXCEPTION: A MINIMUM OF 50% OF THE TOTAL WATTAGE OF PERMANENTLY INSTALLED LIGHT FIXTURES IN THE KITCHEN SHALL BE HIGH EFFICACY. CEnerC 150.0(k)3A B) PROVIDE A MINIMUM OF (2) 20 AMP DEDICATED BRANCH CIRUITS FOR KITCHEN. CEC ART. 210.11(C)(1) C) PERMANENTLY INSTALLED LIGHT FIXTURES THAT ARE INTERNAL TO CABINETS SHALL USE NO MORE THAN 20 WATTS OF POWER PER LINEAR FOOT OF ILLUMINATED CABINETS. CAenrC 150.0(k)4.A

- 3 BATHROOMS
- 1.12 BATHROOMS A) ALL 125-VOLT, SINGLE PHASE, 15- AND 20- AMPERE RECEPTACLE OUTLETS INSTALLED IN THE BATHROOM SHALL HAVEGROUND-FAULT CIRCUIT-INTERRUPTER PROTECTION. CEC 210.8.

B) LIGHT FIXTURES IN BATHROOMS MUST BE HIGH EFFICACY OR MUST BE CONTROLLED BY A VACANCY SENSOR. CEnerC 150.0(k)5.

C) ALL PERMANENTLY INSTALLED HIGH EFFICACY LUMINARIES IN BATHROOMS MUST BE SWITCHED SEPERATELY FROM LOW EFFICACY LUMINARIES. CEnerC 150(k)7.

D) ALL LIGHT FIXTURES IN BATHROOMS MUST BESWITCHED EPERATELY FROM EXHAUST FANS.

CRAFTED EARTH, INC. **ENGINEERING & DESIGN**

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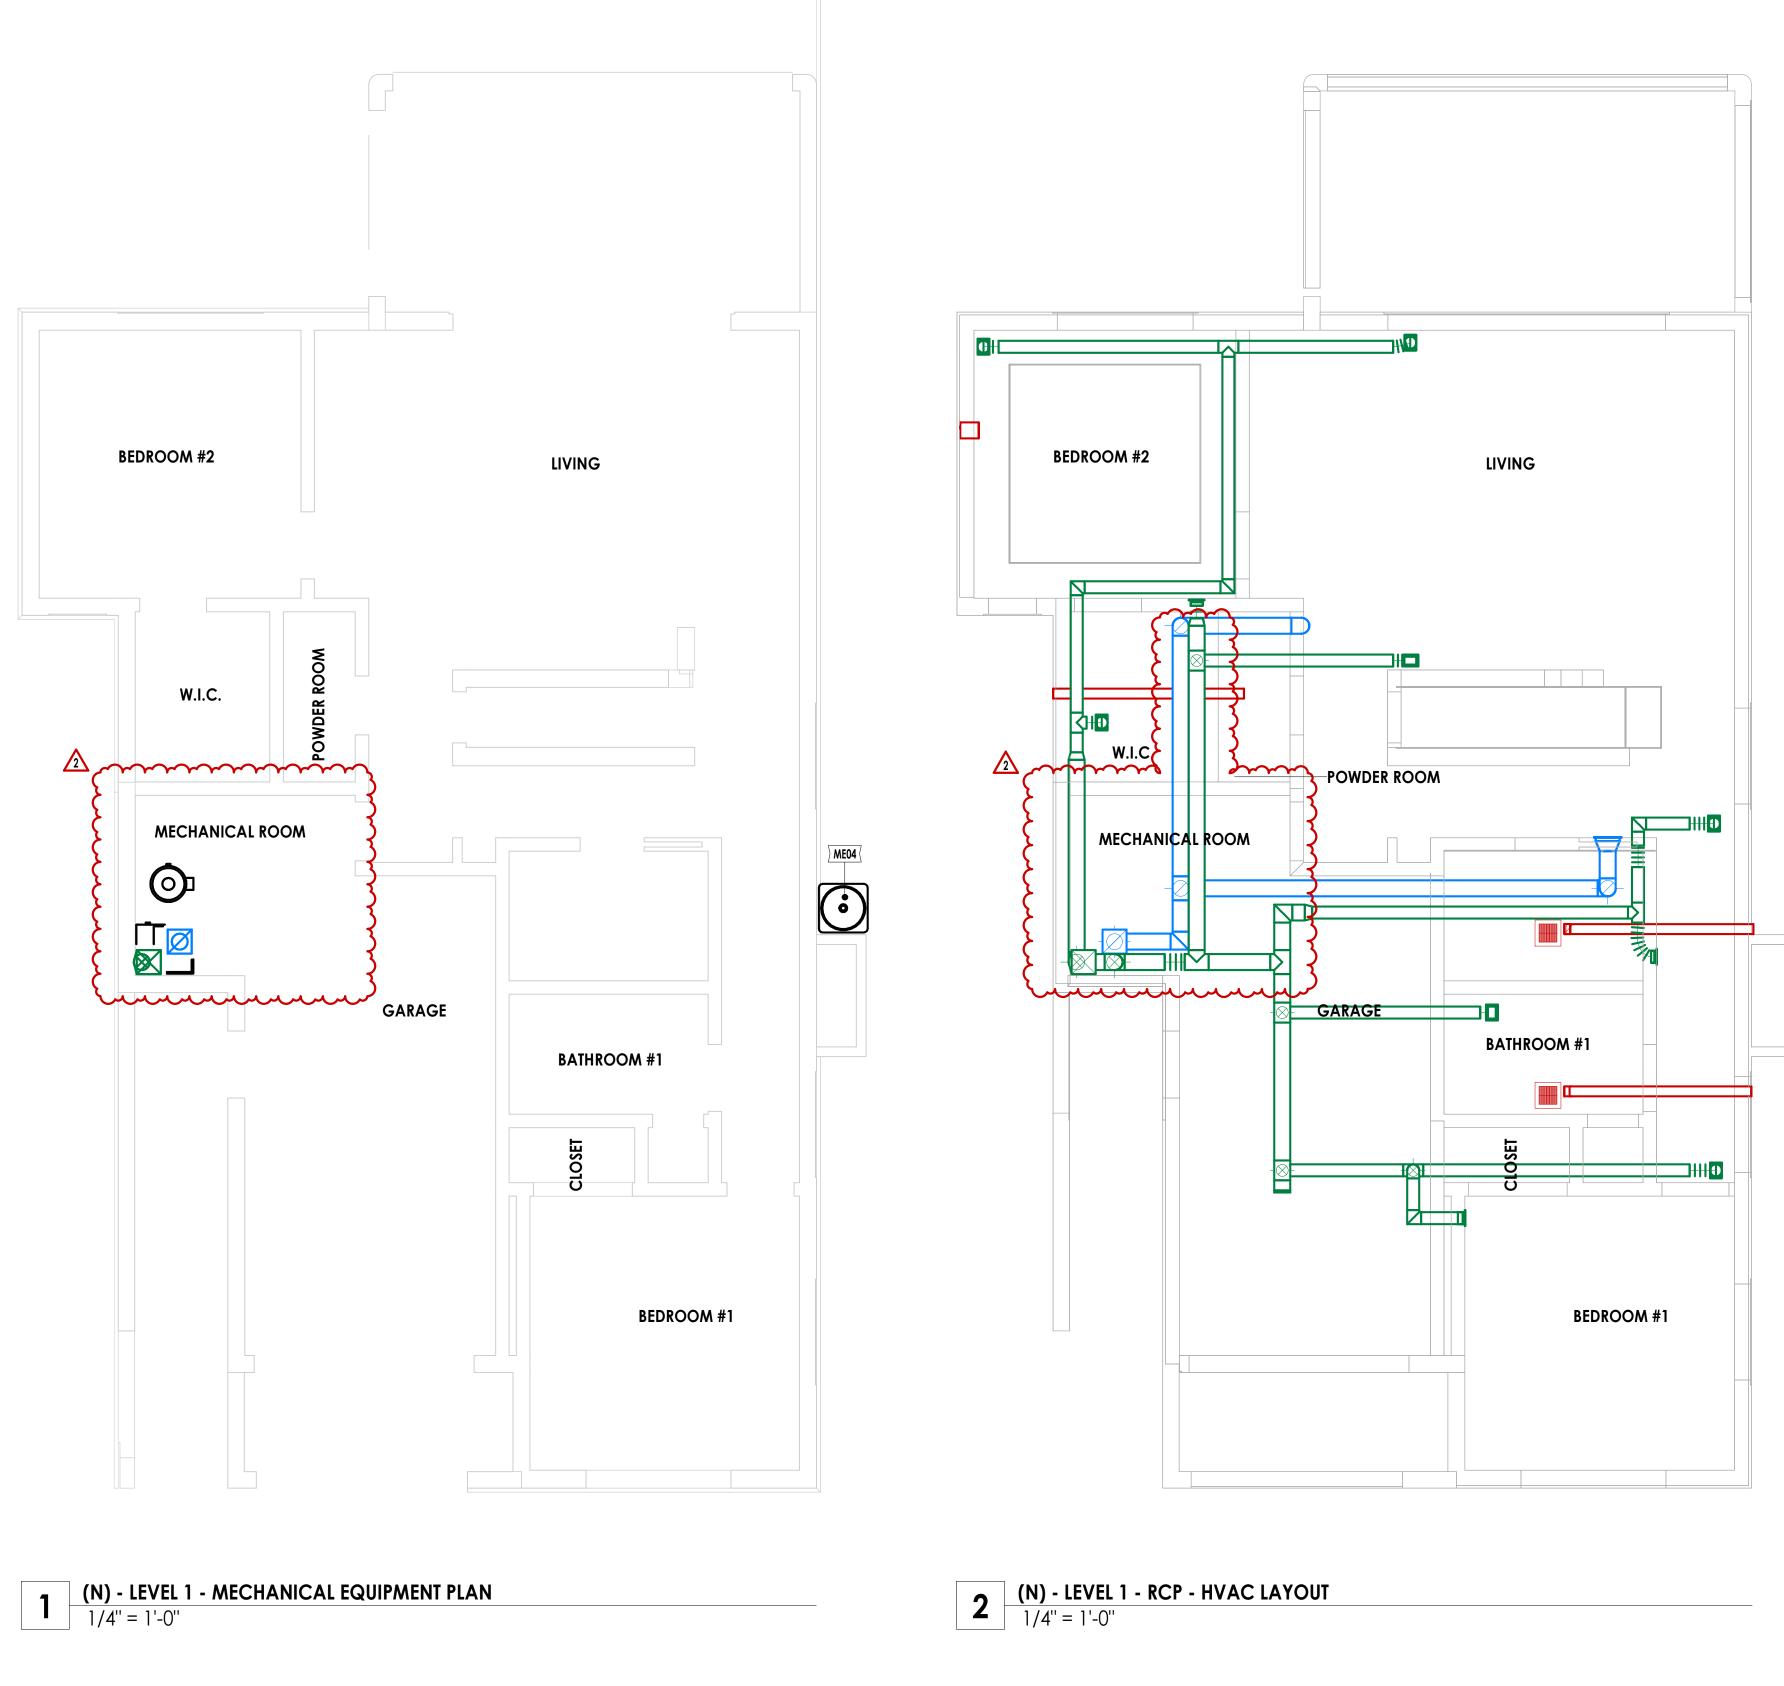


41 Poplar Kitchen Remodel


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ELECTRICAL & POWER






	NOTES MECHANICAL		MECHANICAL EQUIPM	ENT
- GENERAL	NOTES	TAG	DESCRIPTION	ROOM
1.01	RANGEHOOD FAN TO BE 100 C.F.M. MIN.			BATHROOM #1
1.02	KITCHENS REQUIRE MECHANICAL VENTILATION TO THE OUTSIDE (A NON-CIRCULATING FAN) WITH A MINIMUM OF			LAUNDRY
	AT LEAST 100CFM. (CEC 150(0) & ASHRAE 62.2).			POWDER ROOM
1.03	BATHROOMS REQUIRE MECHANICAL VENTILATION TO THE OUTSIDE WITH A MINIMUM OF 50 CFM. IF THEY INCLUDE A LIGHT, THEY MUST BE SWITCHED SEPERATELY. (CBC 1203.4.2.1	ME02	ELECATRIC HEAT PUMP FURNACE	MECHANICAL ROOM
	& CMC 403.7 & Table 4-4)(CEC 150(o), ASHRAE 62.2)	ME03	ELECATRIC WATER HEATER	MECHANICAL ROOM
1.04	HOT WATER PIPE MUST BE INSULATED FROM THE WATER			
1.04	HEATER TO THE KITCHEN.	ME04	(N) AC COMPRESSOR	
	AN EARTHQUAKE-ACTUATED SHUTOFF VALVE IS TO BE			
1.05	INSTALLED AT THE GAS METER. MARIN COUNTY MUNICIPAL CODE SECTION 19.04.090 ITEM B.	ME05	EXHAUST AIR FAN	BATHROOM #1
		ME05	EXHAUST AIR FAN	LAUNDRY

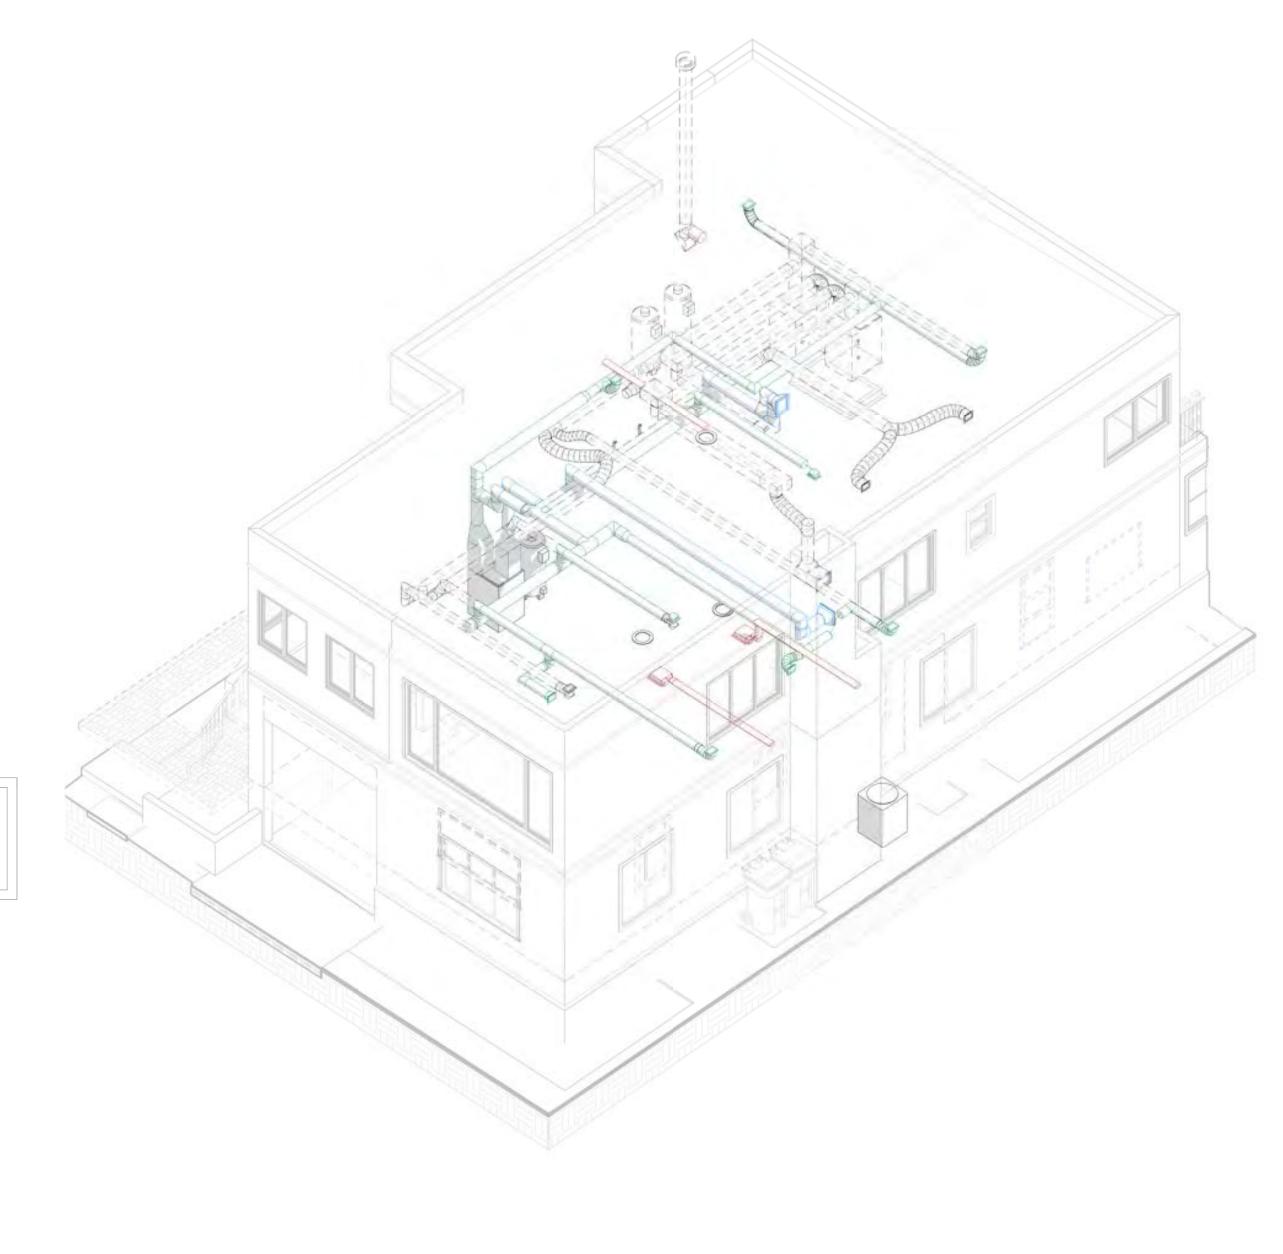

3 (N) - HVAC AXONOMETRIC VIEW

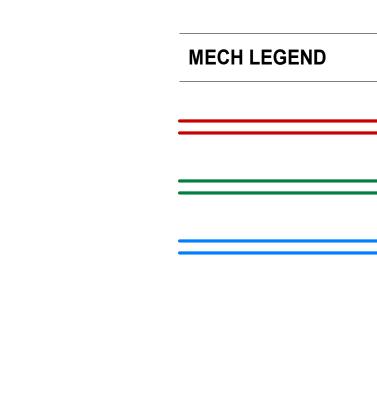

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Rev	Description	Date
1	CITY COMMENTS REV 1	01/11/23
2	TOWN COUNCIL	03/02/23

41 Poplar Kitchen Remodel

Date:	02/03/23
Scale:	As Noted
Sheet Title	

(N) MEP - HVAC PLANS



EXHAUST AIR DUCT
SUPPLY AIR DUCT
RETURN AIR DUCT

NOTES PLUMBING

1 - GENERAL NOTES


1.01	ALL PLUMBING FIXTURES TO COMPLY WITH 2016 CGC, SEC. 4.303.
1.02	THE CONTROL VALVES IN SHOWERS, BATHTUBS, AND BIDETS MUST BE PRESSURE BALANCED OR THERMOSTATIC MIXING VALVES. CPC SECTIONS 408, 409, 410.
1.03	ALL NEW GAS PIPING SHALL BE SIZED TO SUPPLY SUFFICIENT GAS TO THE APPLIANCES. CPC 1215. THE GAS PIPING SHALL BE TESTED WITH A PRESSURE OF 10 PSI FOR A MINIMUM OF 15 MINUTES. CPC 1213.3.
1.04	ALL GAS APPLIANCES CONNECTED TO A PIPING SYSTEM SHALL HAVE AN ACCESSIBLE APPROVED MANUAL SHUTOFF VALVE WITH A NON-DISPLACEABLE VALVE MEMBER, OR A LITED GAS CONVENIENCE OUTLET INSTALLED WITHIN 6 FEET OF THE EQUIPMENT IT SERVES. CPC 1211.
1.05	PROVIDE A 1" AIR-GAP BETWEEN THE DISHWASHER DRAINPIPE AND THE GARBAGE DISPOSAL INLET. CPC 603.3.
1.06	WATER CLOSETS SHALL BE 1.28 GALLONS PER FLUSH MAXIMUM. CPC 403.2.1, CALGREEN 4.303.1.
1.07	SHOWER HEADS SHALL HAVE A MAXIMUM FLOW RATE OF 2.0 GALLONS PER MINUTE, MEASURED AT 80 PSI. CPC 403.1.1; CALGREEN 4.303.1.
1.08	SHOWER HEAD SHALL NOT DISCHARGE DIRECTLY AT THE ENTRANCE; BATHER CAPABLE OF ADJUSTING PRIOR TO STEPPING INTO SPRAY. CPC 408.9.
1.09	FAUCETS FOR LAVATORIES SHALL HAVE A MAXIMUM FLOW RATE OF 1.5 GALLONS PER MINUTE, MEASURED AT 60 PSI. CPC 402.1.1.
1.10	BATHTUB AND WHIRLPOOL BATHTUBS SHALL HAVE A MAXIMUM HOT WATER TEMPERATURE OF 120 DEGREE FAHRENHEIT. THE WATER HEATER THERMOSTAT SHALL NOT BE CONSIDERED A SUITABLE CONTROL FOR MEETING THIS PROVISION. CPC 409.4.


PLUMBING FIXTURES

TAG	DESCRIPTION	ROOM
PF01	THERMOSTATIC MIXING VALVE	BATHROOM #1
PF02	BATHROOM SINK	BATHROOM #1
PF05	SINK	BATH
PF06	TOILET	BATH
PF06	TOILET	POWDER
PF07	TUB	BATH
PF07	TUB	BATHROOM #1
PF08	SINK	KITCHEN
PF09	BASIN	GARAGE
PF10	GENERIC TWO LEVERS FAUCET	BATHROOM #1
PF10	GENERIC TWO LEVERS FAUCET	LAUNDRY
PF10	GENERIC TWO LEVERS FAUCET	POWDER ROOM
PF11	WALL MOUNTED HAND SHOWER SET	BATHROOM #1
PF12	BATHROOM SINK	POWDER ROOM
PF13	WASHLET TOILET	BATHROOM #1
PF13	WASHLET TOILET	POWDER ROOM
PF16	PEDESTRAL SINK	POWDER
PF17	GENERIC VANITY QUEARE SINK - 24 - 20 - 0.5	LAUNDRY
PF18	WALL MOUNTED 3 HOLE FAUCET	BATHROOM #1
PF19	3-WAY DIVERTER	BATHROOM #1

PLUMBING LEGEND

DOMESTIC COLD WATER
DOMESTIC HOT WATER
 WASTE
VENT

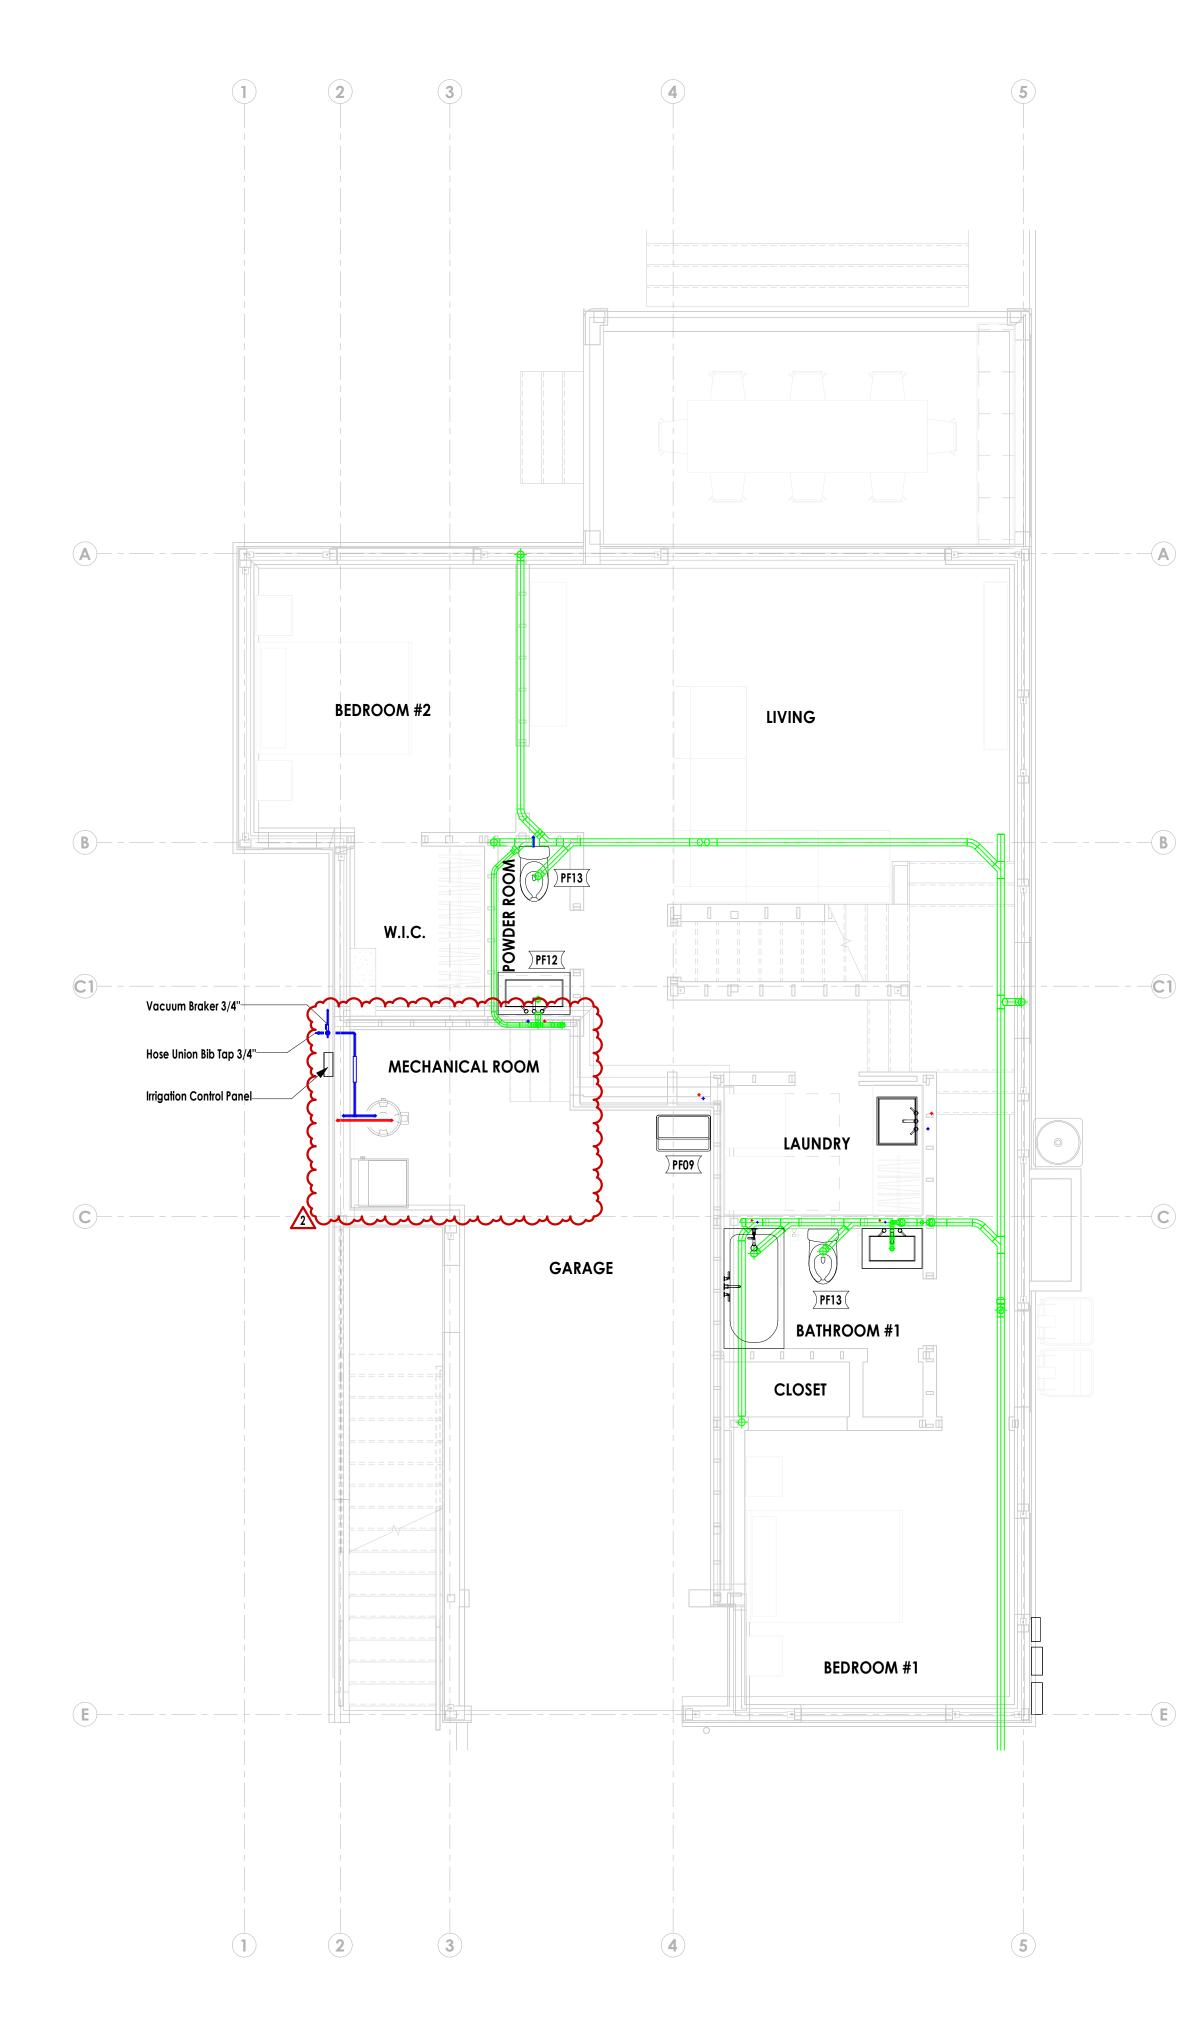

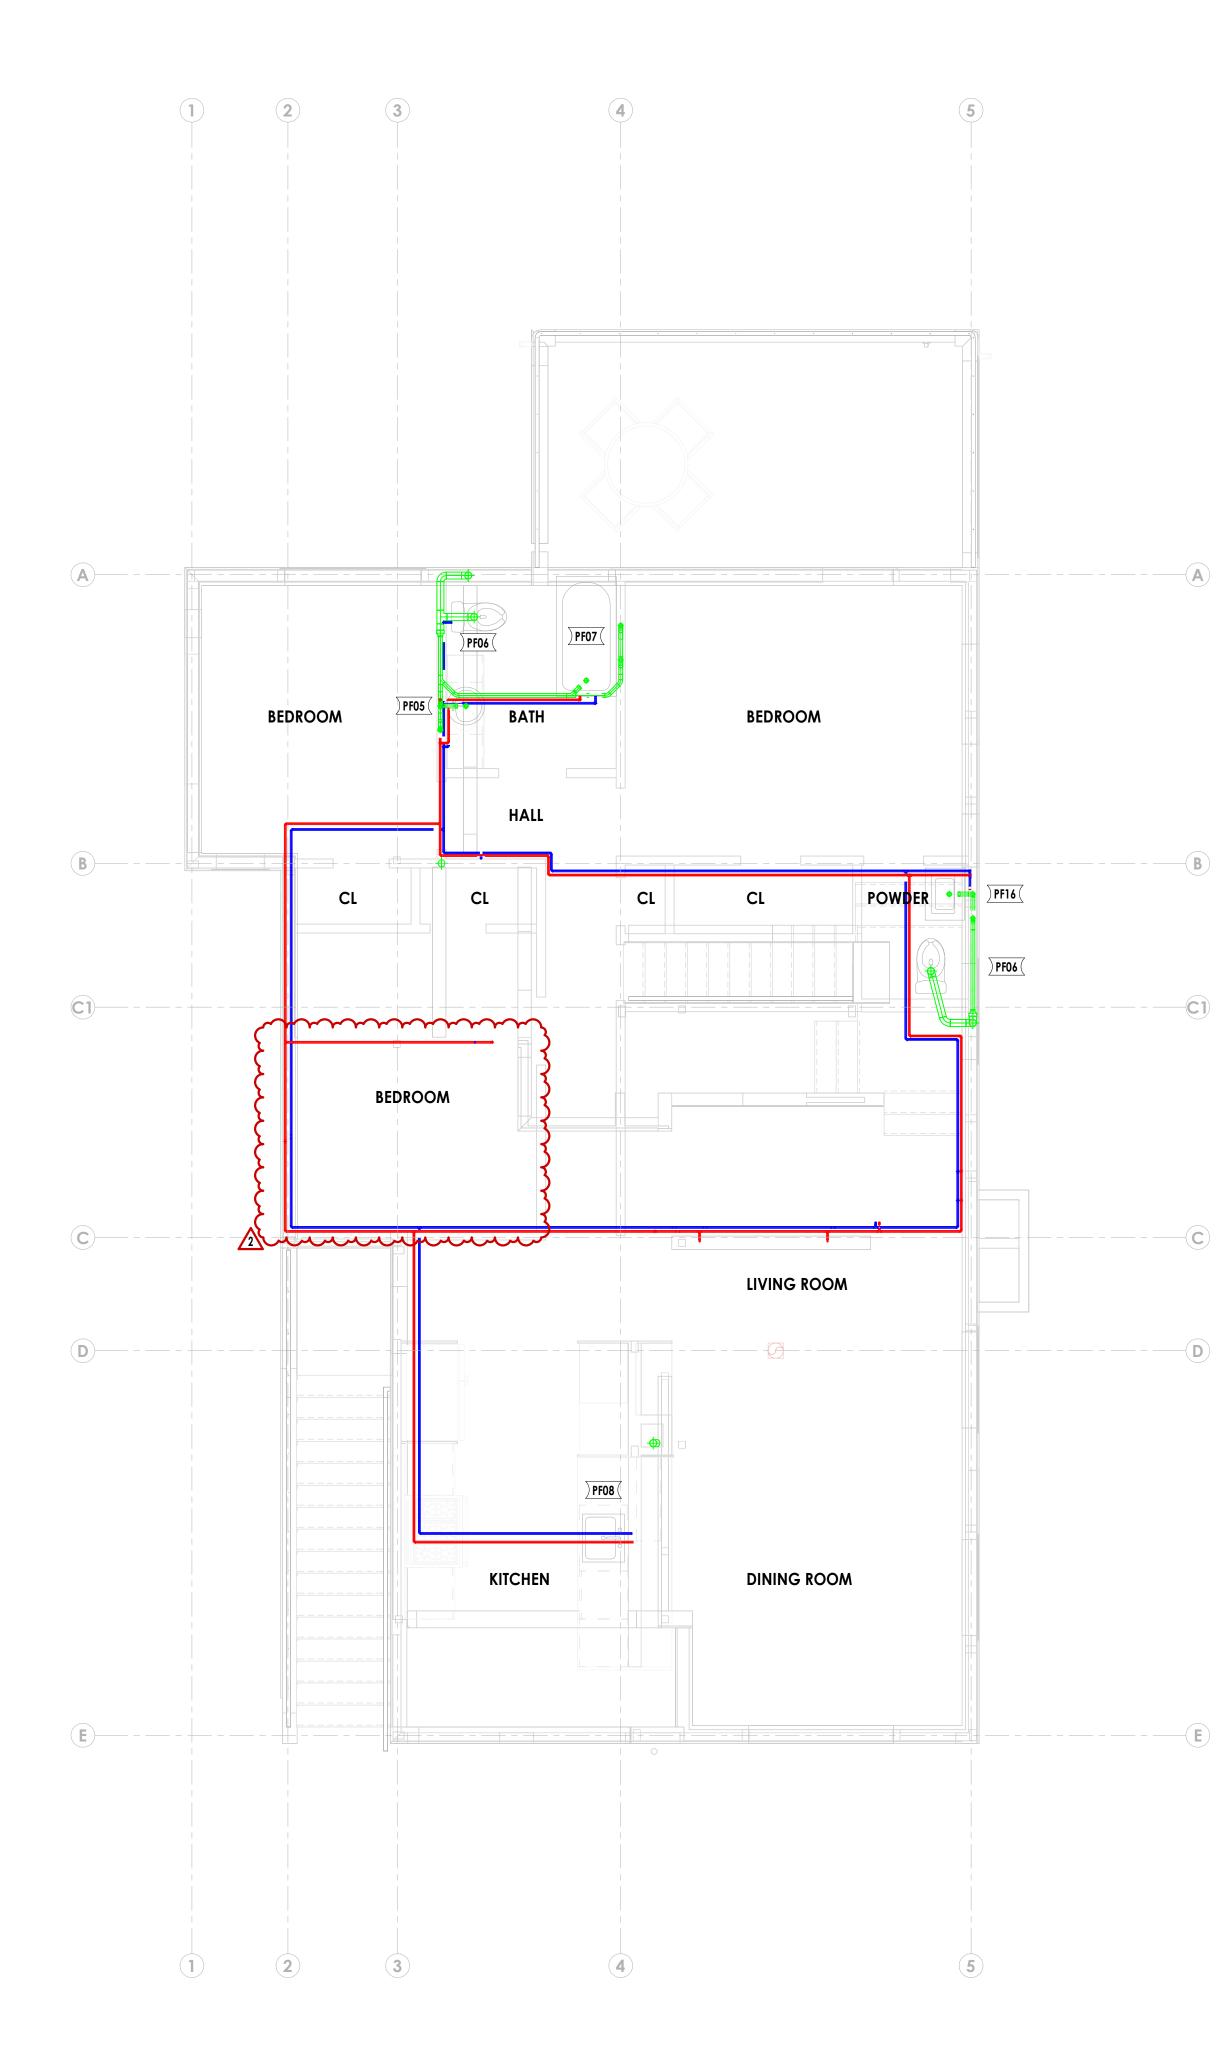

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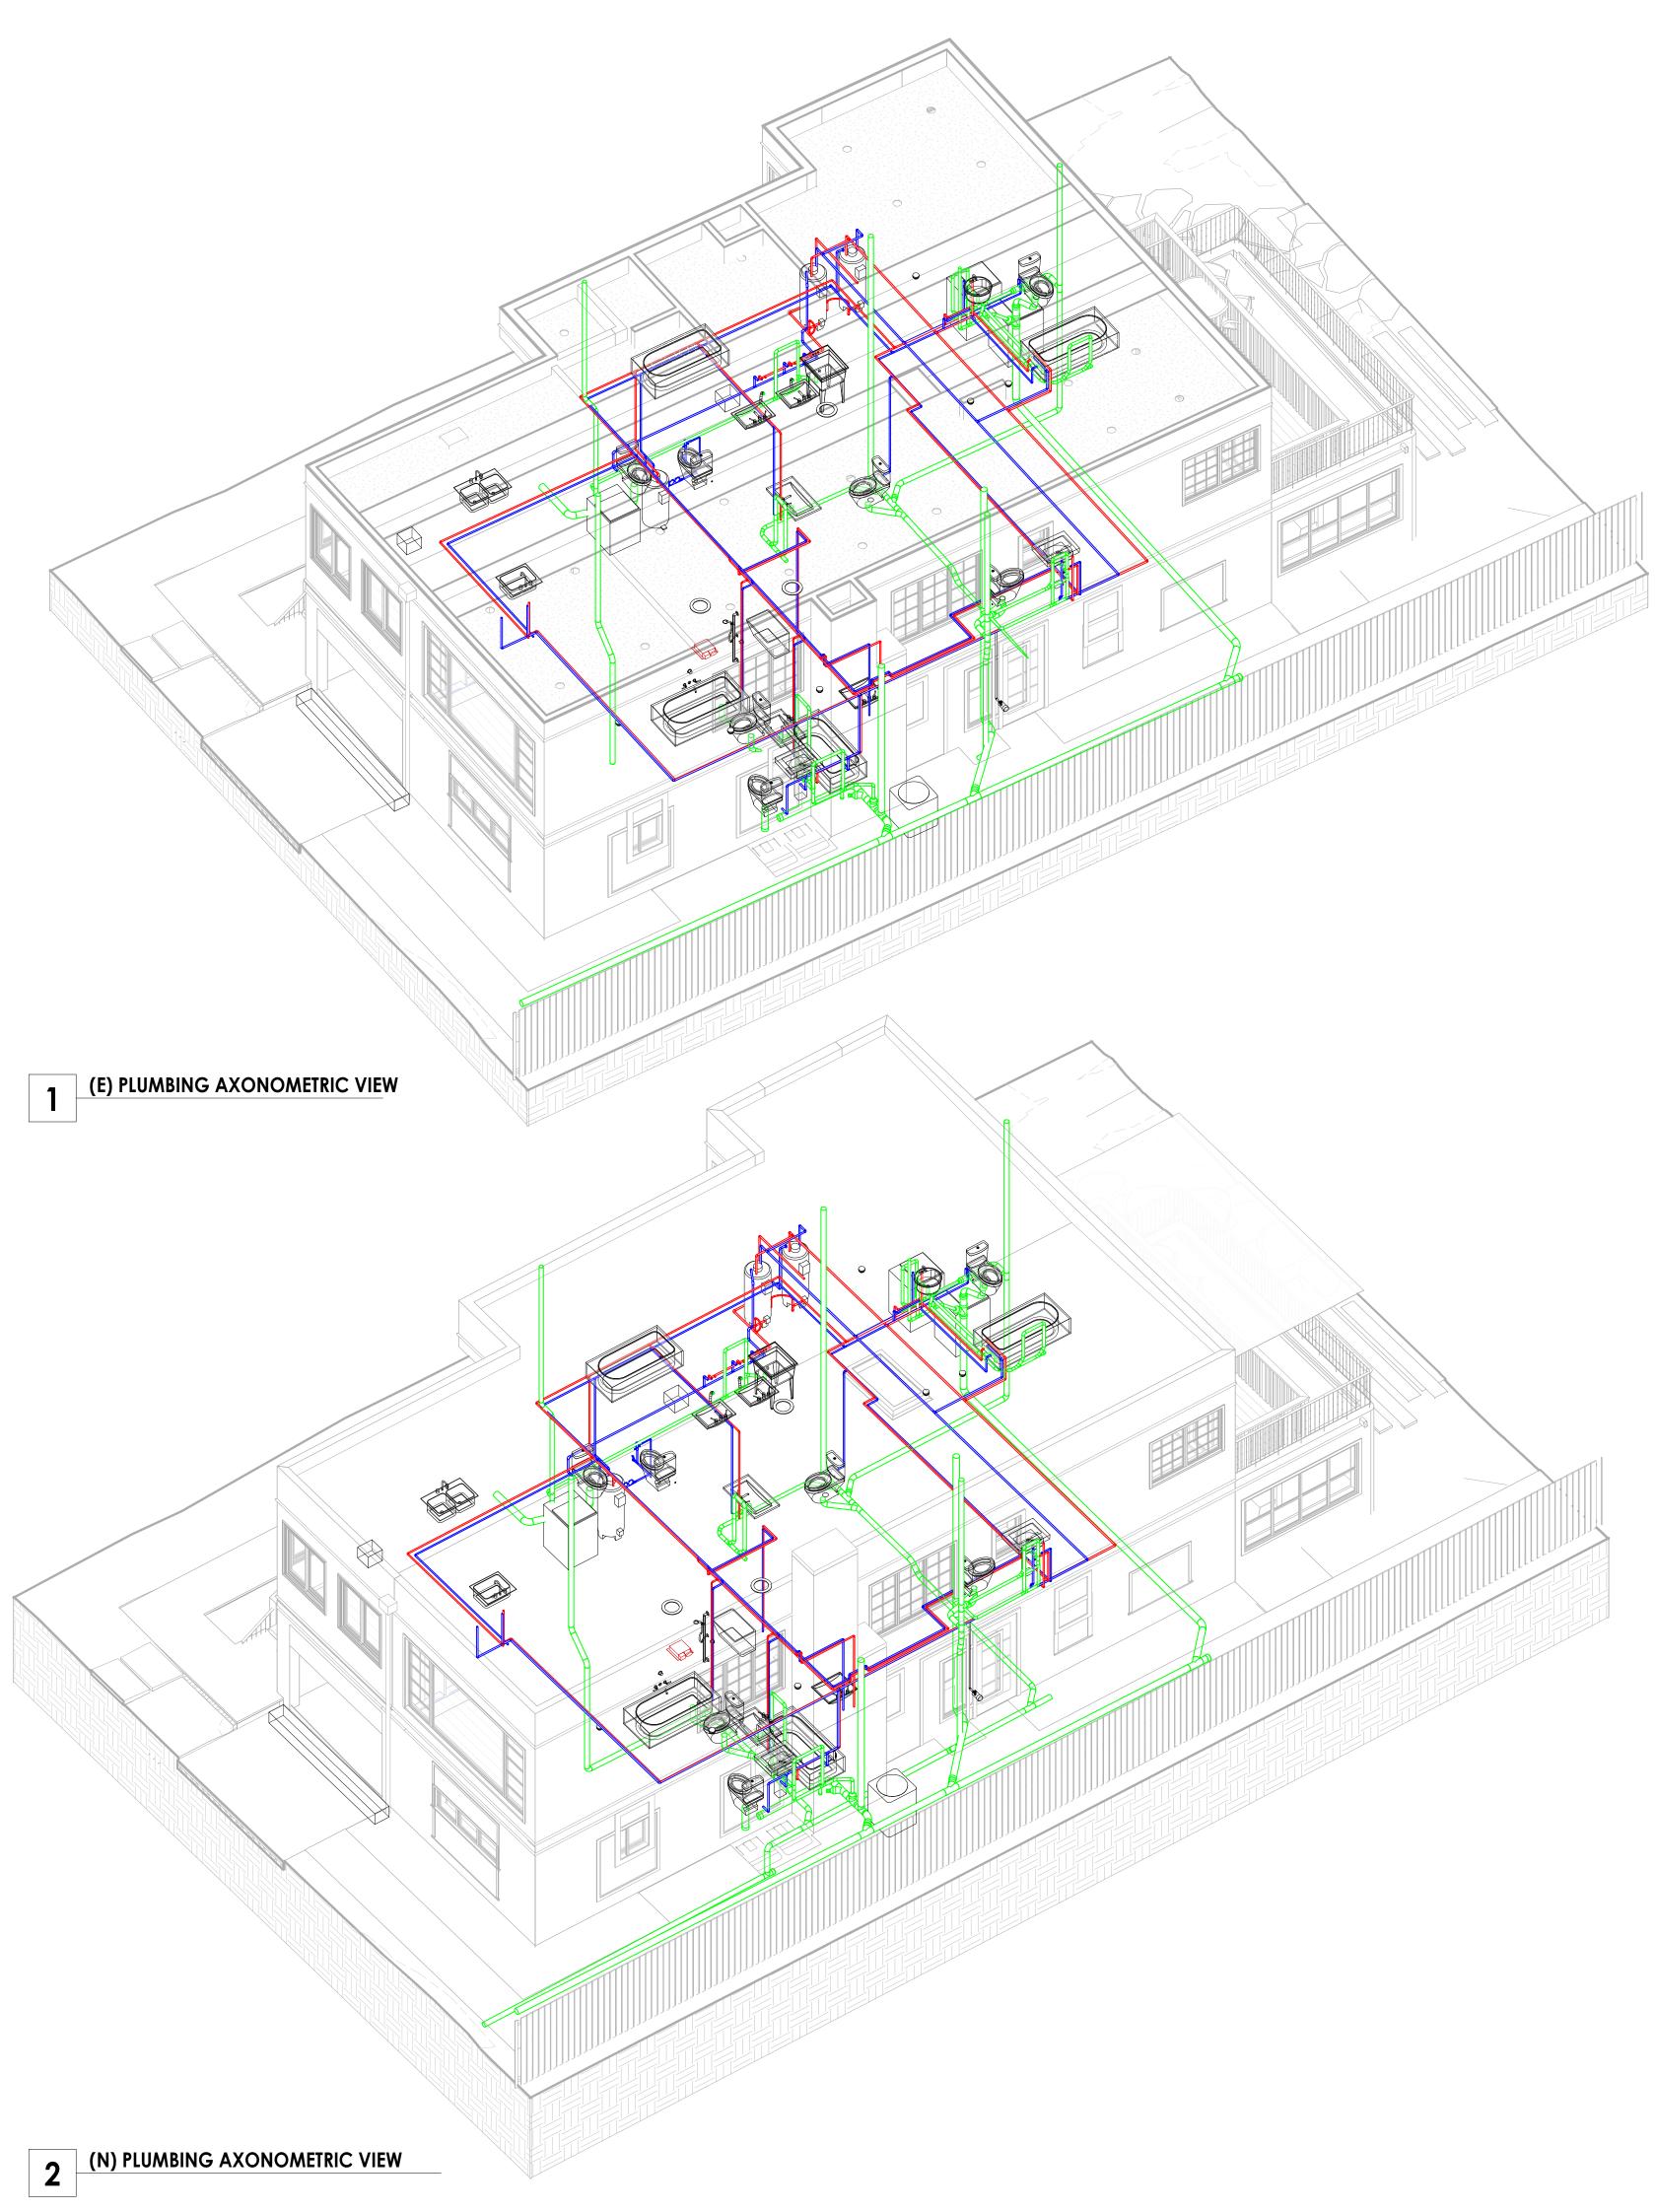
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2 TOWN COUNCIL 03/02/23 1 CITY COMMENTS REV 1 01/11/23 Rev Description Date 41 Poplar Kitchen Remodel

Date: 02/03/23 Scale: As Noted Sheet Title

(N) MEP - PLUMBING PLANS

M-144



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2	TOWN COUNCIL	03/02/23
1	CITY COMMENTS REV 1	01/11/23

Rev	Description	Date

41 Poplar Kitchen Remodel

Date:	02/03/23
Scale:	As Noted

MEP - PLUMBING AXONOMETRY VIEWS

Sheet Title



1 - GENERAL 1.01	IT IS THE INDIVIDUAL RESPONSIBILITY OF THE CONTRACTOR TO INFORM THE SPECIAL INSPECTION INDIVIDUAL OR AGENCY			
	AT LEAST ONE WORKING DAY PRIOR TO PERFORMING ANY WORK THAT REQUIRES SPECIAL INSPECTION.	3 - MATERIAL 3.01	s TIMBER: SAWN LUMBER SHALL CONFORM TO DOUGLAS FIR NO.2 OR BETTER EXCEPT AS NOTED ON THE DRAWINGS. TIMBER	6 - CONCRETE CONSTRUCTION 6.01 FRAMING CONNE
1 02	STRUCTURAL OBSERVATIONS IS REQUIRED PER CBC CHAPTER 17.		IN CONTACT WITH CONCRETE OR MASONRY SHALL BE EITHER PRESSURE TREATED OR FOUNDATION GRADE REDWOOD:	
1.02				
		3.02	CONCRETE: ALL REINFORCED CONCRETE TO BE MINIMUM 2500 PSI, 28-DAY COMPRESSIVE STRENGTH. CONCRETE SHALL COMPLY WITH ASTM C-94, READY MIX CONCRETE.	6.02 WOOD FRAMING STRONG-TIE CO. C
1.03	THE GENERAL CONTRACTOR SHALL VERIFY AND ASSUME RESPONSIBILITY FOR ALL DIMENSIONS AND SITE CONDITIONS. THE GENERAL CONTRACTOR SHALL INSPECT THE EXISTING PREMISES AND TAKE NOTE OF EXISTING CONDITIONS PRIOR TO			MANUFACTURER'S
	SUBMITTING PRICES. NO CLAIM SHALL BE ALLOWED FOR DIFFICULTIES ENCOUNTERED WHICH COULD HAVE REASONABLY BEEN INFERRED FROM SUCH AN EXAMINATION.	3.03	REINFORCING STEEL: ALL REINFORCING STEEL SHALL CONFORM TO ASTM A615, GRADE 60. ALL WELDED WIRE FABRIC SHALL CONFORM TO ASTM A185.	6.03 OPENINGS IN DIAF
1.04	THE GENERAL CONTRACTOR SHALL BE RESPONSIBLE FOR COORDINATION BETWEEN ARCHITECTURAL, STRUCTURAL,		SHALL CONFORM TO ASIM ATOS.	BLOCKING AT OPE
	LANDSCAPE, CIVIL, MECHANICAL, PLUMBING, ELECTRICAL, AND FIRE PROTECTION. THIS INCLUDES REVIEWING REQUIREMENTS OF INDIVIDUAL SYSTEMS BEFORE ORDERING AND INSTALLATION OF ANY WORK. VERIFY ALL	3.04	BOLTS: ALL BOLTS TO BE A325N UNLESS OTHERWISE NOTED.	6.04 ALL NAILS TO BE H
	ARCHITECTURAL DETAILS AND ALL FINISH CONDITIONS (WHETHER DEPICTED IN DRAWINGS OR NOT) WITH SAME DISCIPLINES.			
1.05	THE GENERAL CONTRACTOR SHALL BE RESPONSIBLE FOR COORDINATION BETWEEN ARCHITECTURAL, STRUCTURAL, LANDSCAPE, CIVIL, MECHANICAL, PLUMBING, ELECTRICAL, AND FIRE PROTECTION. THIS INCLUDES REVIEWING			
	REQUIREMENTS OF INDIVIDUAL SYSTEMS BEFORE ORDERING AND INSTALLATION OF ANY WORK. VERIFY ALL ARCHITECTURAL DETAILS AND ALL FINISH CONDITIONS (WHETHER DEPICTED IN DRAWINGS OR NOT) WITH SAME			6.05 WOOD TIMBERS EX A PORTABLE FINIS
1.06	DISCIPLINES. ANY ERRORS, OMISSIONS, OR CONFLICTS FOUND IN THE VARIOUS PARTS OF THE CONSTRUCTION DOCUMENTS SHALL BE	4 - REINFORC 4.01	LAP SPLICES SHALL BE 57db U.O.N.	
	BROUGHT TO THE ATTENTION OF THE ARCHITECT AND THE OWNER BEFORE PROCEEDING WITH THE WORK.	4.01		6.06 ALL LAG SCREWS ELEMENT WILL BE S
1.07	DO NOT WRITTEN DIMENSIONS GOVERN. ALL CLEAR DIMENSIONS ARE NOT TO BE ADJUSTED WITHOUT APPROVAL OF THE ARCHITECT.	4.02	SPLICES IN REINFORCING STEEL SHALL DEVELOP FULL STRENGTH OF THE BAR.	6.07 ALL FRAMING SHA
1.08	WHEN IN PLAN, ALL DIMENSIONS ARE TO FACE OF STUD, CONCRETE, CENTERLINE OF COLUMNS, OR CENTERLINE OF STUD WITHIN WALL ASSEMBLIES, UNLESS OTHERWISE NOTED.	4.03	BENDS AND HOOKS IN THE REINFORCING STEEL SHALL CONFORM TO UBC AND ACI REQUIREMENTS REGARDING BEND	
	WITHIN WALL ASSEMIDLIES, UNLESS OTHERWISE NOTED.		RADIUS AND EXTENSION.	6.08 ALL FASTENERS FO HOT DIPPED ZINC
1.09	WHEN IN SECTION OR ELEVATION, ALL DIMENSIONS ARE TO TOP OF PLATE OR TOP OF CONCRETE UNLESS OTHERWISE	4.04		
1.07	NOTED.	4.04	ALL CONCRETE SHALL BE REINFORCED. WHERE REINFORCING IS NOT SPECIFICALLY SHOWN OR WHERE DETAILS ARE NOT GIVEN, PROVIDE REINFORCING SIMILAR TO THAT SHOWN FOR SIMILAR CONDITIONS SUBJECT TO REVIEW BY CRAFTED EARTH, INC.	
1.10	DETAILS SHOWN ARE TYPICAL, SIMILAR DETAILS APPLY IN SIMILAR CONDITIONS.	4.05	DOWELS OR BOLTS EMBEDDED IN PREVIOUSLY CAST CONCRETE SHALL BE ANCHORED WITH SIMPSON ET (EPOXY) MEETING ASTM C881-90 EPOXY ADHESIVE OR EQUIVALENT. FOLLOW MANUFACTURERS PROCEDURES FOR USE. TO DEVELOP SHEAR	
			RESISTANCE REQUIRED IN STRUCTURAL CALCULATIONS, ALL ANCHOR BOLTS WILL BE EMBEDDED A MINIMUM OF 8". HOLD DOWN BOLTS SHALL BE CAST IN PLACE WHERE THEY OCCUR IN NEW FOUNDATIONS, AND SHALL BE EMBEDDED TO THE	
1.11	THE SHALL BE RESPONSIBLE FOR APPLYING AND OBTAINING ALL REQUIRED INSPECTIONS TO CONFORM WITH LOCAL	4 06	SPECIFIED DEPTH. ALL REINFORCING STEEL AND HOLD DOWN ANCHORS SHALL BE ACCURATELY LOCATED IN THE FORMS AND HELD FIRMLY	
	BUILDING AND FIRE CODES.	4.00	IN PLACE BEFORE AND DURING THE PLACING OF CONCRETE BY MEANS OF WIRE SUPPORTS ADEQUATE TO PREVENT DISPLACEMENT DURING THE COURSE OF CONSTRUCTION AND TO KEEP THE STEEL AT A PROPER DISTANCE FROM THE	
1.12	PROVIDE AND INSTALL 2x FLAT WOOD BLOCKING FOR ALL BATH ACCESSORIES, HANDRAILS, CABINETS, TOWEL BARS, WALL		FORMS. BAR SUPPORTS ARE TO BE SUFFICIENT IN NUMBER AND SUFFICIENTLY HEAVY TO PROPERLY CARRY THE STEEL THEY SUPPORT. ACCESSORIES SHALL BE AS SPECIFIED IN THE LATEST EDITION OF CRSI DESIGN HANDBOOK. MAXIMUM	
	MOUNTED FIXTURES AND ANY OTHER ITEMS ATTACHED TO WALLS.		ACCESSORIES SPACING 4' O.C. UNDER NO CONDITIONS SHALL CONCRETE BE PLACED WITHOUT ADEQUATE TIES OR SUPPORTS AS OUTLINED ABOVE.	
		4.07	DOWELS SHALL BE PROVIDED AT POUR CONSTRUCTION JOINTS AND SHALL BE SAME SIZE AS DETAILED STANDARD LAP SPLICE.	
1.13	ALL CHANGES IN FLOOR MATERIALS OCCUR AT CENTERLINE OF DOOR OR FRAMED OPENINGS UNLESS OTHERWISE INDICATED ON THE DRAWINGS.			
		4.08	SPLICES IN ADJACENT HORIZONTAL WALL REINFORCEMENT BARS SHALL BE STAGGERED 4'-0" MINIMUM UNLESS OTHERWISE	
1.14	INSTALL ALL FIXTURES, AND MATERIALS PER MANUFACTURER'S RECOMMENDATIONS AND THE REQUIREMENTS OF THE		NOTED.	
	CODES. ALL APPLIANCES, FIXTURES, AND EQUIPMENT ASSOCIATED WITH PLUMBING, ELECTRICAL, AND MECHANICAL SYSTEMS SHALL BE LISTED BY A NATIONALLY RECOGNIZED AND APPROVED AGENCY.			
1.15	VERIFY FOR FLUES, VENTS, CHASES, SOFFITS, FIXTURES, FIREPLACES, ETC., BEFORE ANY CONSTRUCTION, ORDERING OF, OR	4.09	ALL REINFORCING ANCHOR BOLTS AND OTHER INSERTS SHALL BE SECURED IN PLACE PRIOR TO PLACING CONCRETE OR GROUTING MASONRY.	
	INSTALLATION OF ANY ITEM OF WORK.			
		4.10	PROVIDE THE FOLLOWING MINIMUM PROTECTIVE COVERING OF CONCRETE: BELOW GRADE (UNFORMED) 3" CLEAR.	
1.16	FIRE-@ ALL CONCEALED DRAFT OPENINGS (VERTICAL & HORIZONTAL). AS PER 2013 CBC 718.2.2 & R302.11, FIRE-BLOCKING SHALL BE PROVIDED IN THE FOLLOWING LOCATIONS:		BELOW GRADE (FORMED) 2" CLEAR. ABOVE GRADE 1.5" CLEAR, EXPOSED TO WEATHER. FOR ABOVE GRADE SHELL AND FOLDED PLATE MEMBERS NOT	
	- IN SPACES OF STUD WALLS AND PARTITIONS, INCLUDING FURRED SPACES, AT THE CEILING AND FLOOR LEVELS AND HORIZONTALLY AT MIN. 10-FOOT INTERVALS.	4.11	EXPOSED TO WEATHER, MIN. COVERAGE IS 1/2" CLEAR. WELDING OF REBAR IS NOT PERMITTED UNLESS PROCEDURE APPROVED BY ENGINEER. ADDITIONAL HEATING OF REBAR IS	
	- IN CONCEALED INTERCONNECTIONS SUCH AS DROP CEILINGS & COVE CEILINGS. - IN CONCEALED SPACES STAIR STRINGERS AT THE TOP AND BOTTOM OF THE RUN.	4.11	NOT ALLOWED.	
	- IN OPENINGS AROUND VENTS, PIPES, DUCTS, CABLES, AND WIRES AT CEILING & FLR. LEVEL W/ AN APPROVED MATERIAL TO RESIST THE FREE PASAGE OF FLAME & PRODUCTS OF COMBUSTION.			
1.17	PROVIDE DRAFT-STOPPING @ ALL CONCEALED DRAFT OPENINGS (VERTICAL & HORIZONTAL). AS PER 2013 CBC 718.3-4 & R302.11, DRAFT-STOPS SHALL BE INSTALLED SO THE CONCEALED SPACE DOES NOT EXCEED 1,000 SQ. FT. AND IS DIVIDED IN			
	APPROX. EQUAL AREAS. WHERE A FLLOR IS ENCLOSED ABV. & BELOW, DRAFT-STOPPING SHOULD BE PROVIDED IN THE FOLLOWING CIRCUMSTANCES:			
	- SUSPENDED CEILING UNDER FLOOR FRAMING - OPEN WEB TRUSS OR PERFORATED FLOOR FRAMING MEMBERS.	5.01	CONCRETE BEAMS AND COLUMNS SHALL BE CONSTRUCTED IN ONE CONTINUOUS MONOLITHIC POUR WITHOUT CONSTRUCTION JOINTS, U.N.O. OR APPROVED BY CRAFTED EARTH, INC.	
1.18	PRESSURE TREATED LUMBER TO BE USED IF IN DIRECT CONTACT WITH CONCRETE WALLS IF THERE IS NO PROVIDED AIRGAP.			
		5.02	SLAB-ON-GRADE MAY BE CONSTRUCTED WITH CONTROL AND CONSTRUCTION JOINTS SUBJECT TO REVIEW OF CRAFTED EARTH, INC.	
2 - FOUNDAT	ONS	5.03	PIPES MAY PASS THROUGH STRUCTURAL CONCRETE IN SLEEVES, BUT NOT BE EMBEDDED THEREIN.	
2.01	CONCRETE FOOTINGS SHALL BE CONSTRUCTED IN ONE CONTINUOUS MONOLITHIC POUR WITHOUT CONSTRUCTION JOINTS UNLESS NOTED OTHERWISE.			
2.02	CONCRETE FOOTINGS SHALL USE A MINIMUM STRENGTH CONCRETE OF 2500 PSI COMPRESSIVE STRENGTH AT 28 DAYS.	5.04	CURING CONCRETE SHALL NOT BE EXPOSED TO TEMPERATURES LESS THAN 40° FAHRENHEIT FOR THE FIRST THREE DAYS.	

2.03 DRILLED, CAST-IN-PLACE, REINFORCED CONCRETE PIERS SHOULD BE A MINIMUM OF 12" AND SHOULD EXTEND A MINIMUM OF 6' INTO BEDROCK, WHICH WAS PENETRATED AT DEPTHS OF 3' TO 4' BELOW EXISTING GROUND SURFACE.

ЛС

ONNECTIONS AND DETAILS NOT SPECIFIED SHALL CONFORM TO UBC MINIMUM NAILING STANDARDS.

MING CONNECTIONS AND ACCESSORIES DESIGNATED ON DRAWINGS ARE MANUFACTURED BY SIMPSON CO. OR EQUIVALENT. ALL SIMPSON OR EQUIVALENT PRODUCTS TO BE INSTALLED ACCORDING TO THE JRER'S RECOMMENDATIONS.

N DIAPHRAGMS SHALL BE STIFFENED BY EXTENDING FRAMING MEMBERS OR BLOCKING AT LEAST 16" BEYOND F THE OPENING. NAIL PLYWOOD TO BLOCKING AS SPECIFIED FOR PANEL EDGES. METAL STRAPPING AT AT OPENINGS.

BE HOT DIPPED GALVANIZED PER CBC 2304.3.

ERS EXPOSED TO VIEW IN FINISHED WORK, PLANED ON SITE USING EITHER A HAND HELD 6" TIMBER PLANER OR FINISH PLANER.

REWS MUST HAVE LEAD HOLES THAT COMPLY WITH NDS SPECIFICATION 11.1.3.2. LEAD HOLES IN ATTACHED LE BE SET TO SHAFT DIAMETER AND LEAD HOLES INTO SUPPORTING MEMBERS WILL BE 1/2 THE SHAFT DIAMETER.

G SHALL HAVE 18" CLEAR BETWEEN SOIL AND JOISTS, AND 12" CLEAR AT GIRDERS.

RS FOR PRESSURE TREATED WOOD SHALL BE APPROVED SILICON BRONZE OR COPPER, STAINLESS STEEL OR ZINC COATED STEEL.

CRAFTED EARTH, INC. ENGINEERING & DESIGN

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1	CITY COMMENTS REV 1	01/11/23
Rev	Description	Date


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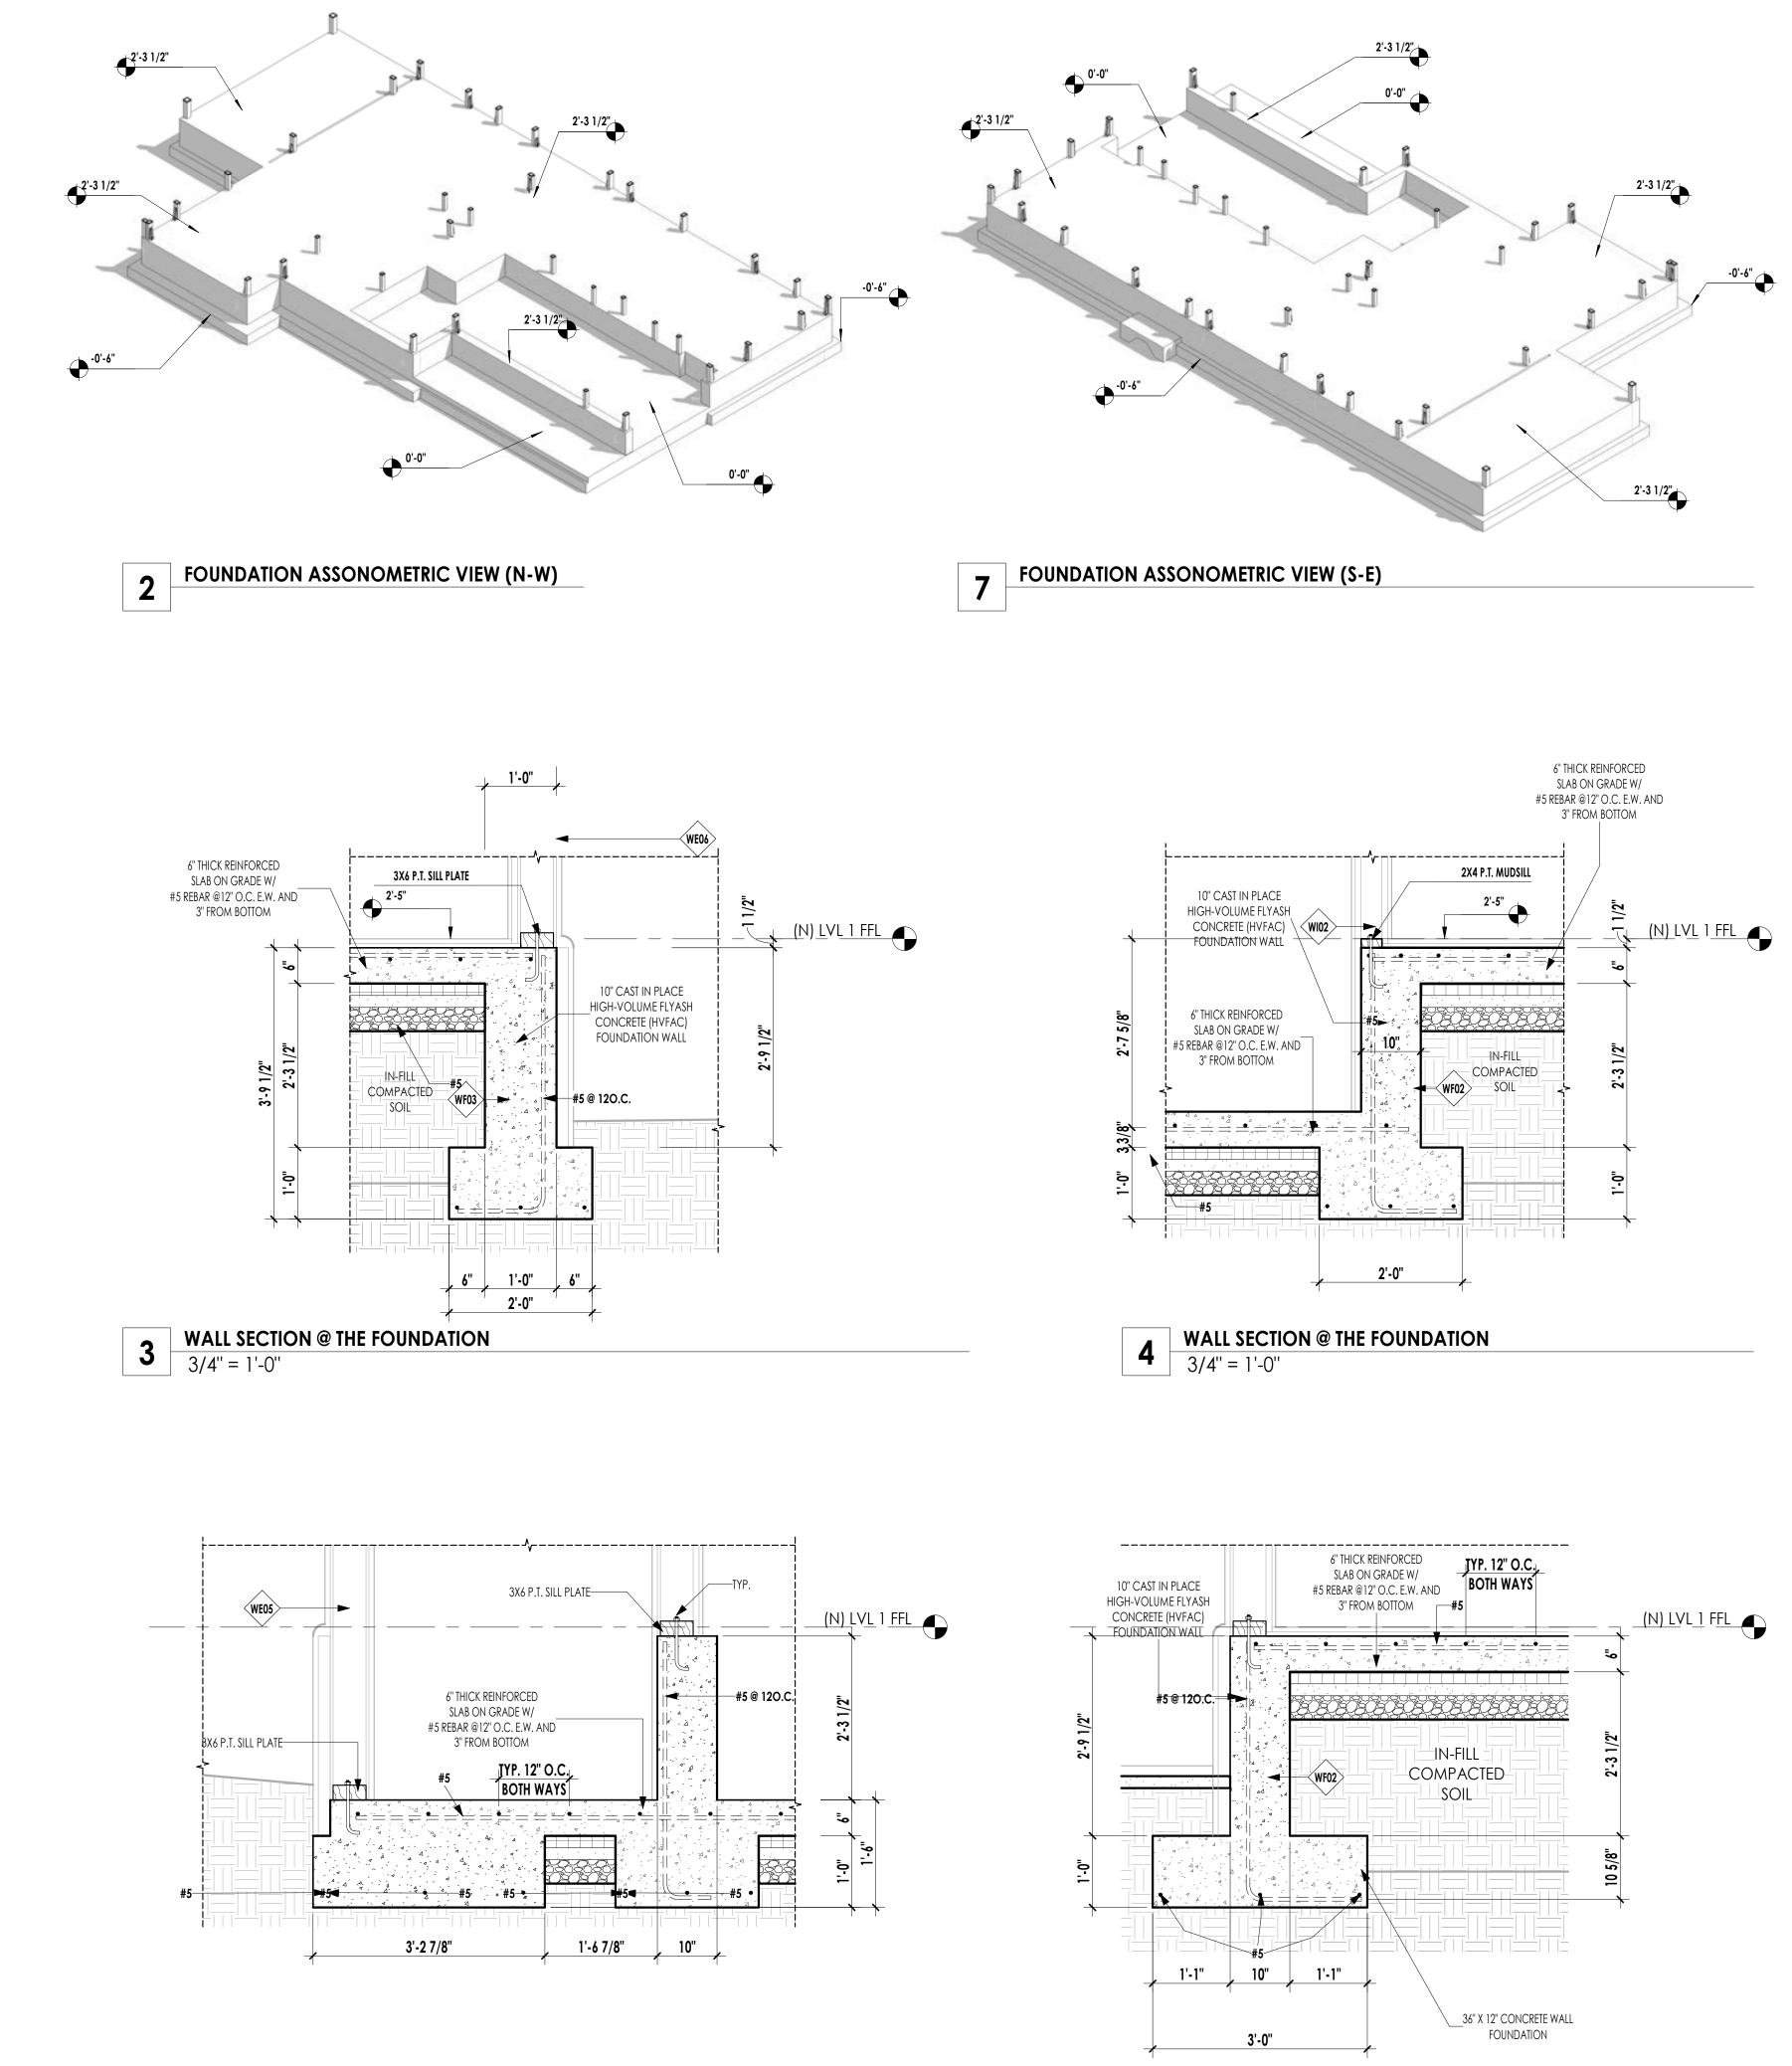
Date:	02/03/23
Scale:	As Noted

STRUCTURAL NOTES

Sheet Title





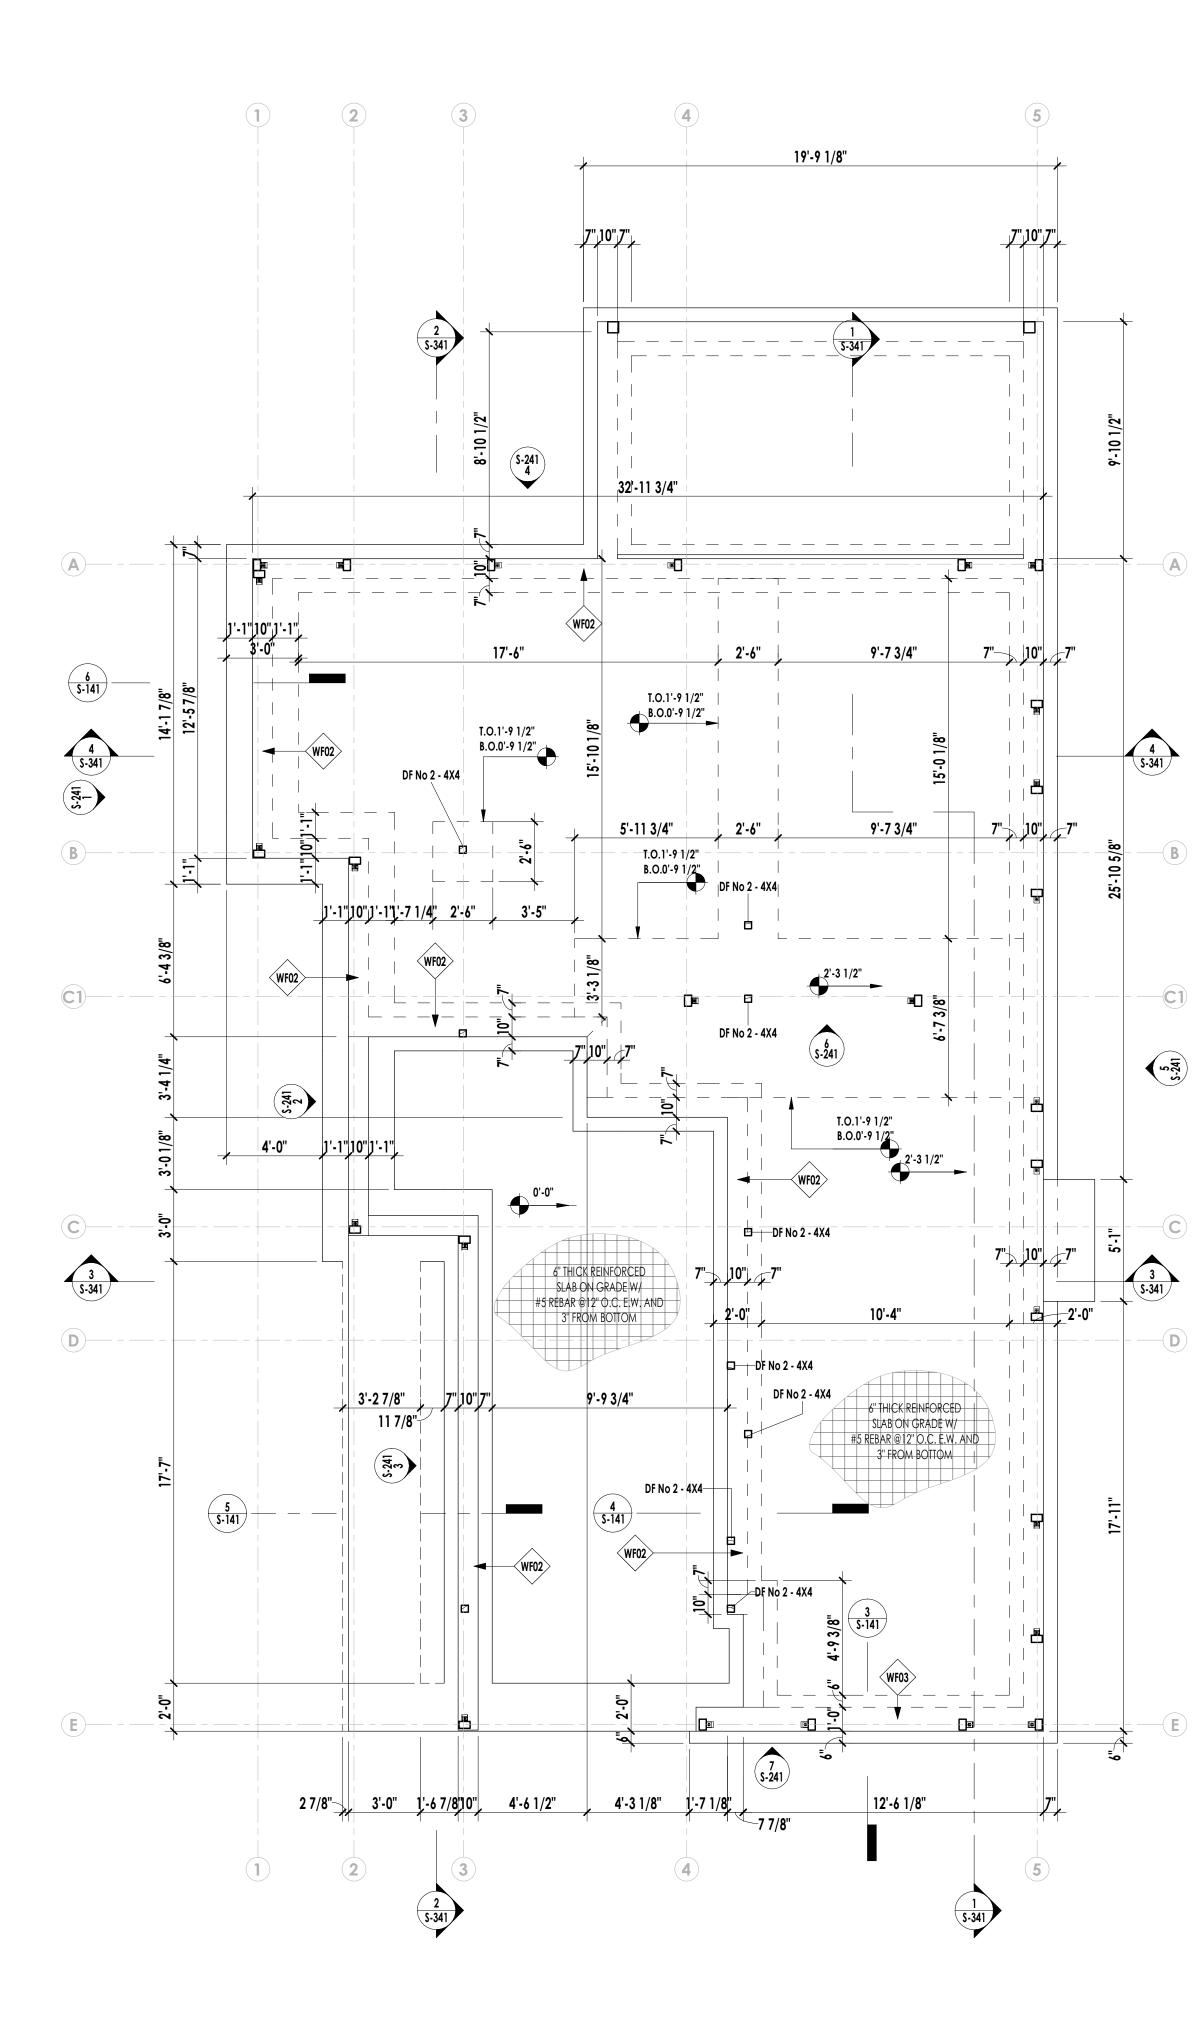

WALL SECTION @ THE FOUNDATION 3/4" = 1'-0" 5

 $6 \quad \frac{\text{WALL SECTION @ THE FOUNDATION}}{3/4'' = 1'-0''}$

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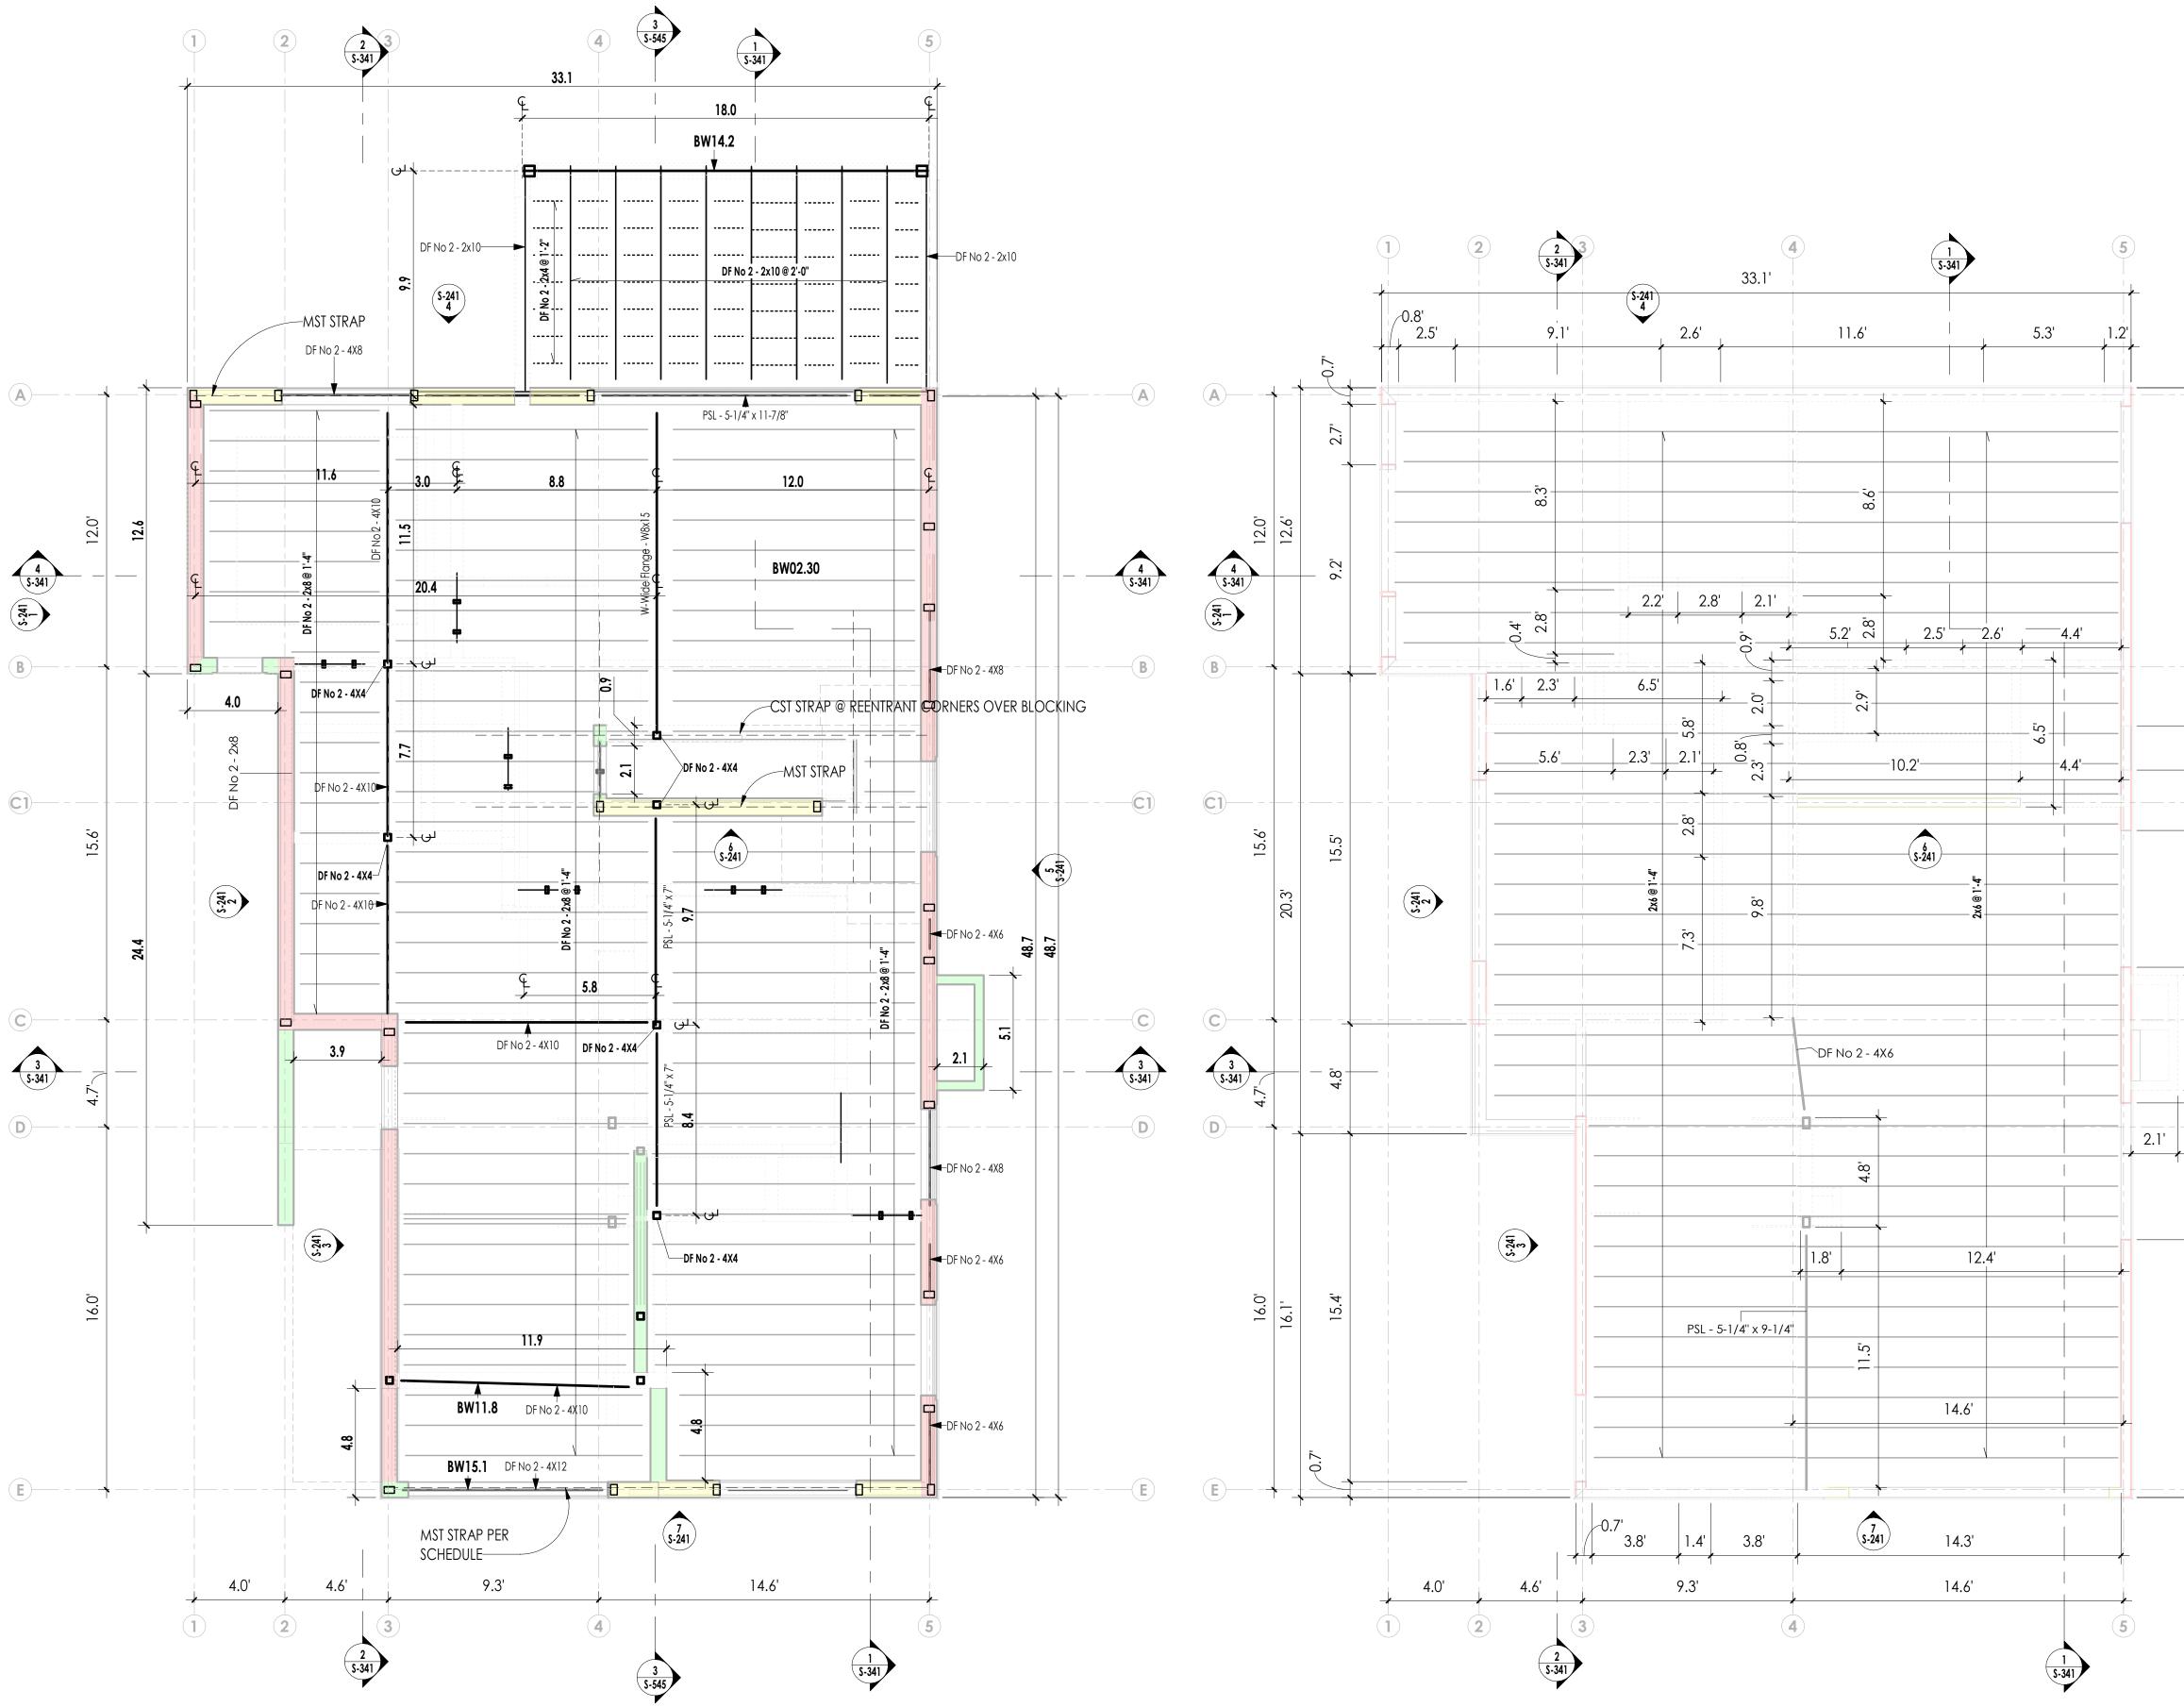
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	1	CITY COMMENTS REV	/ 1 01/11/23
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41 Poplar Kitchen Remodel			
[Date:		02/03/23

As Noted Scale: Sheet Title

FOUNDATION PLAN

S-141



GIRDER SCHEDULE

GIRDER SCHEDULE			
	TAG Instance	DESCRIPTION	LENGTH
BS01	BS01.1	W-Wide Flange - W8x15	
BW04	BW04.1	DF No 2 - 4X8	4'-0''
BW04	BW04.2	DF No 2 - 4X8	5'-8 1/2"
BW04	BW04.3	DF No 2 - 4X8	4'-6"
BW05	BW05.1	DF No 2 - 4X6	4'-10 1/2"
BW05	BW05.4	DF No 2 - 4X6	1'-10 1/2"
BW05	BW05.7	DF No 2 - 4X6	2'-1"
BW05	BW05.8	DF No 2 - 4X6	3'-2 1/2"
BW06	BW06.1	PSL - 5-1/4" x 9-1/4"	12'-1 1/2"
BW11	BW11.1	DF No 2 - 4X10	13'-4"
BW11	BW11.2	DF No 2 - 4X10	11'-6 1/2"
BW11	BW11.3	DF No 2 - 4X10	11'-5"
BW11	BW11.4	DF No 2 - 4X10	7'-8"
BW11	BW11.5	DF No 2 - 4X10	7'-3"
BW11	BW11.6	DF No 2 - 4X10	5'-5"
BW11	BW11.7	DF No 2 - 4X10	11'-4 1/2"
BW11	BW11.8	DF No 2 - 4X10	10'-6"
BW14	BW14.1	PSL - 5-1/4" x 11-7/8"	11'-6 1/2"
BW14	BW14.2	PSL - 5-1/4" x 11-7/8"	17'-10 1/2"
BW14	BW14.3	PSL - 5-1/4" x 11-7/8"	2'-11"
BW14	BW14.4	PSL - 5-1/4" x 11-7/8"	7'-6"
BW15	BW15.1	DF No 2 - 4X12	9'-6 1/2"
BW16	BW16.2	PSL - 5-1/4" x 7"	8'-5"
BW16	BW1601	PSL - 5-1/4" x 7"	9'-8"

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1	CITY COMMENTS REV 1	01/11/23
Rev	Description	Date

41 Poplar Kitchen Remodel

02/03/23 Date: Scale: As Noted Sheet Title

FRAMING PLANS

S-142

-A Ō 4 S-341 Ō 0 —(B) 2.0' 2.7 --C1 5-241 Ō Ō —(**C**) -1 5.1 6.0' 3 5-341 -(D) Ō


SHEAR WALL LEGEND

-(E)

└──

STRUCTURAL BEARING (NO SHEAR) STRUCTURAL SHEAR


STRUCTURAL COMBINED (BEARING AND SHEAR)

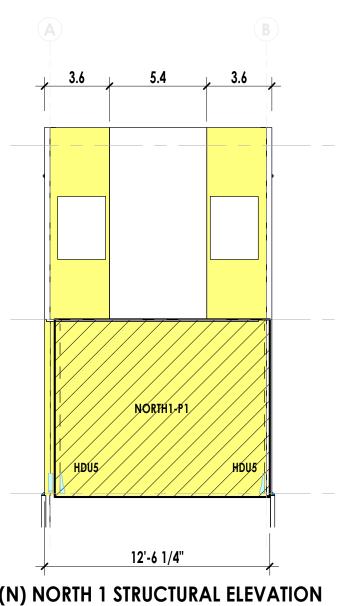

1


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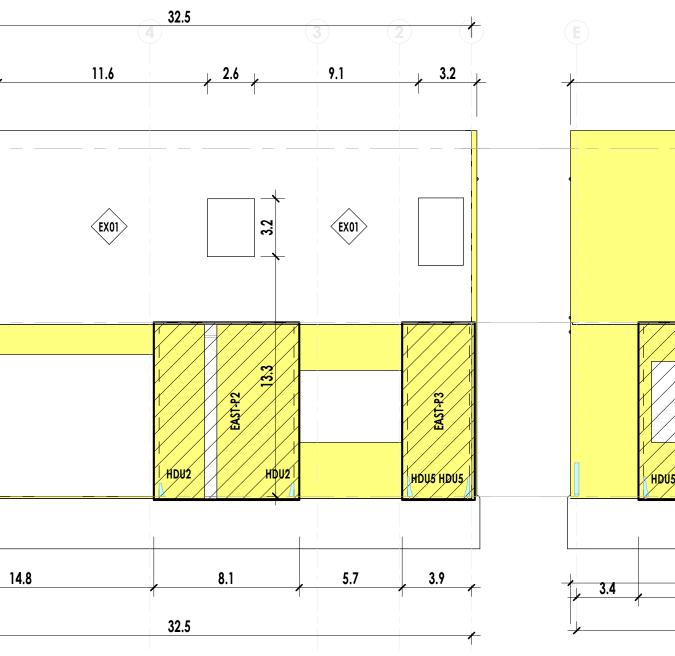
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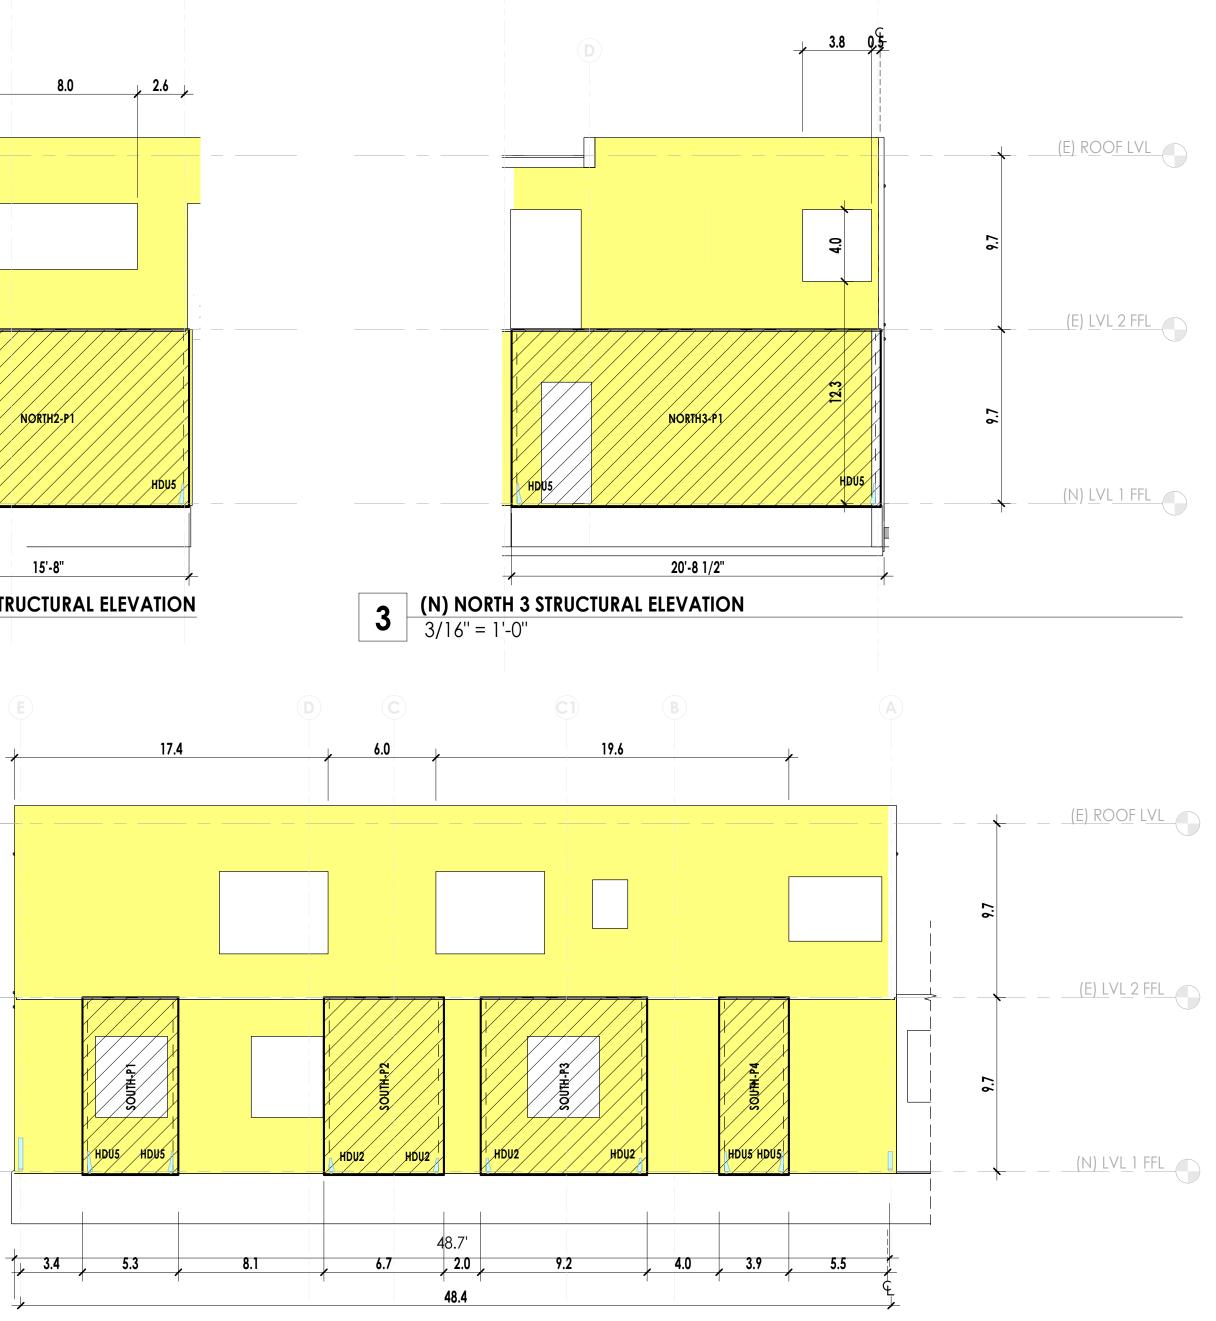



0.3 4.7

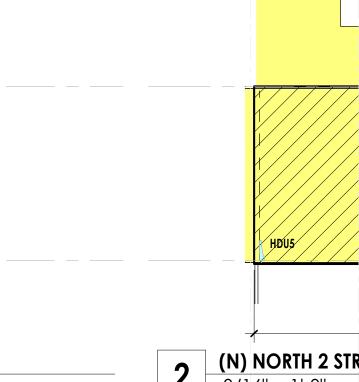





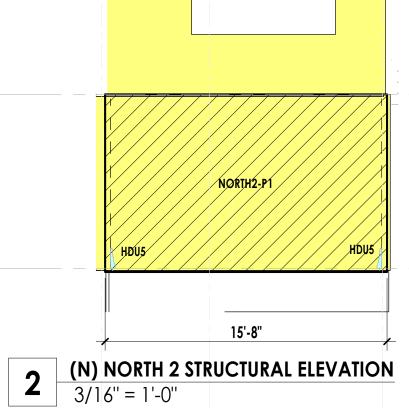

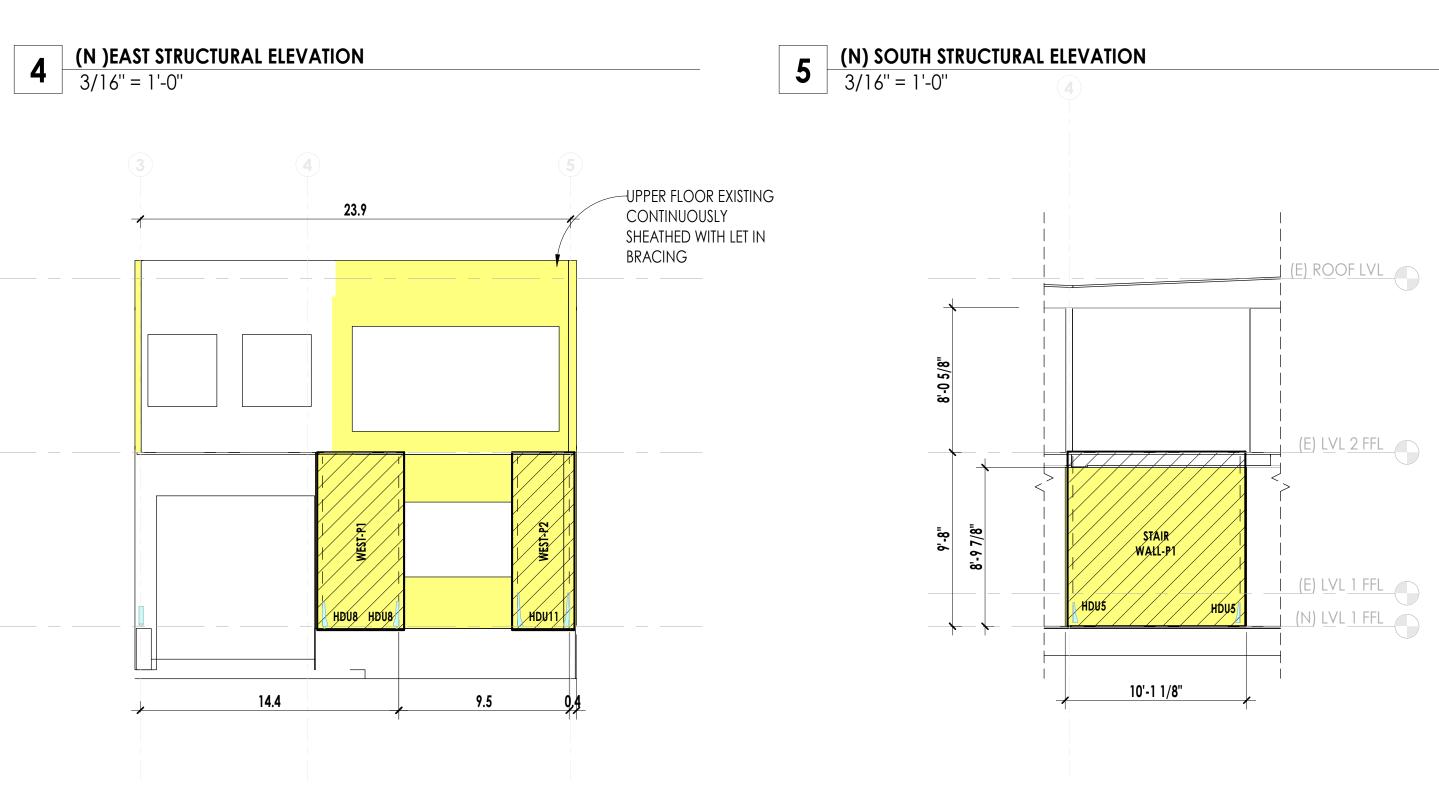

6 (N) SHER WALL @ INTERIOR STAIR 3/16" = 1'-0"

MARK	CONSTRUCTION	WALL CHORD	HOLD DOWN	SHEATING	NAILING
EAST-P1	2X6	0' - 3 1/2"	HDU5	2x 1/2" CDX PLY	6" AT PANEL EDGES, 12" IN FIELD
EAST-P2	2X6	0' - 3 1/2"	HDU2	2x 1/2" CDX PLY	6" AT PANEL EDGES, 12" IN FIELD
EAST-P3	2X6	0' - 3 1/2"	HDU5	2x 1/2" CDX PLY	6" AT PANEL EDGES, 12" IN FIELD
NORTH1-P1	2X6	0' - 3 1/2"	HDU5	1/2" CDX PLY	6" AT PANEL EDGES, 12" IN FIELD
NORTH2-P1	2X6	0' - 3 1/2"	HDU5	1/2" CDX PLY	6" AT PANEL EDGES, 12" IN FIELD
NORTH3-P1	2X6	0' - 3 1/2"	HDU5	1/2" CDX PLY	6" AT PANEL EDGES, 12" IN FIELD
SOUTH-P1	2X6	0' - 3 1/2"	HDU5	1/2" CDX PLY	4" AT PANEL EDGES, 12" IN FIELD
SOUTH-P2	2X6	0' - 3 1/2"	HDU2	1/2" CDX PLY	6" AT PANEL EDGES, 12" IN FIELD
SOUTH-P3	2X6	0' - 3 1/2"	HDU2	1/2" CDX PLY	6" AT PANEL EDGES, 12" IN FIELD
SOUTH-P4	2X6	0' - 3 1/2"	HDU5	1/2" CDX PLY	4" AT PANEL EDGES, 12" IN FIELD
STAIR WALL-P1	2X6	0' - 3 1/2"	HDU5	1/2" CDX PLY	4" AT PANEL EDGES, 12" IN FIELD
WEST-P1	2X6	0' - 3 1/2"	HDU8	2x 1/2" CDX PLY	2" AT PANEL EDGES, 12" IN FIELD
WEST-P2	2X6	0' - 3 1/2"	HDU11	2x 1/2" CDX PLY	2" AT PANEL EDGES, 12" IN FIELD

NOTE:

SHEAR WALL SCHEDULE

ALL NAILING OF WOOD STRUCTURAL PANELS TO BE WITH 10D FASTENERS WITH MIN. PENETRATION OF 1 1/2"

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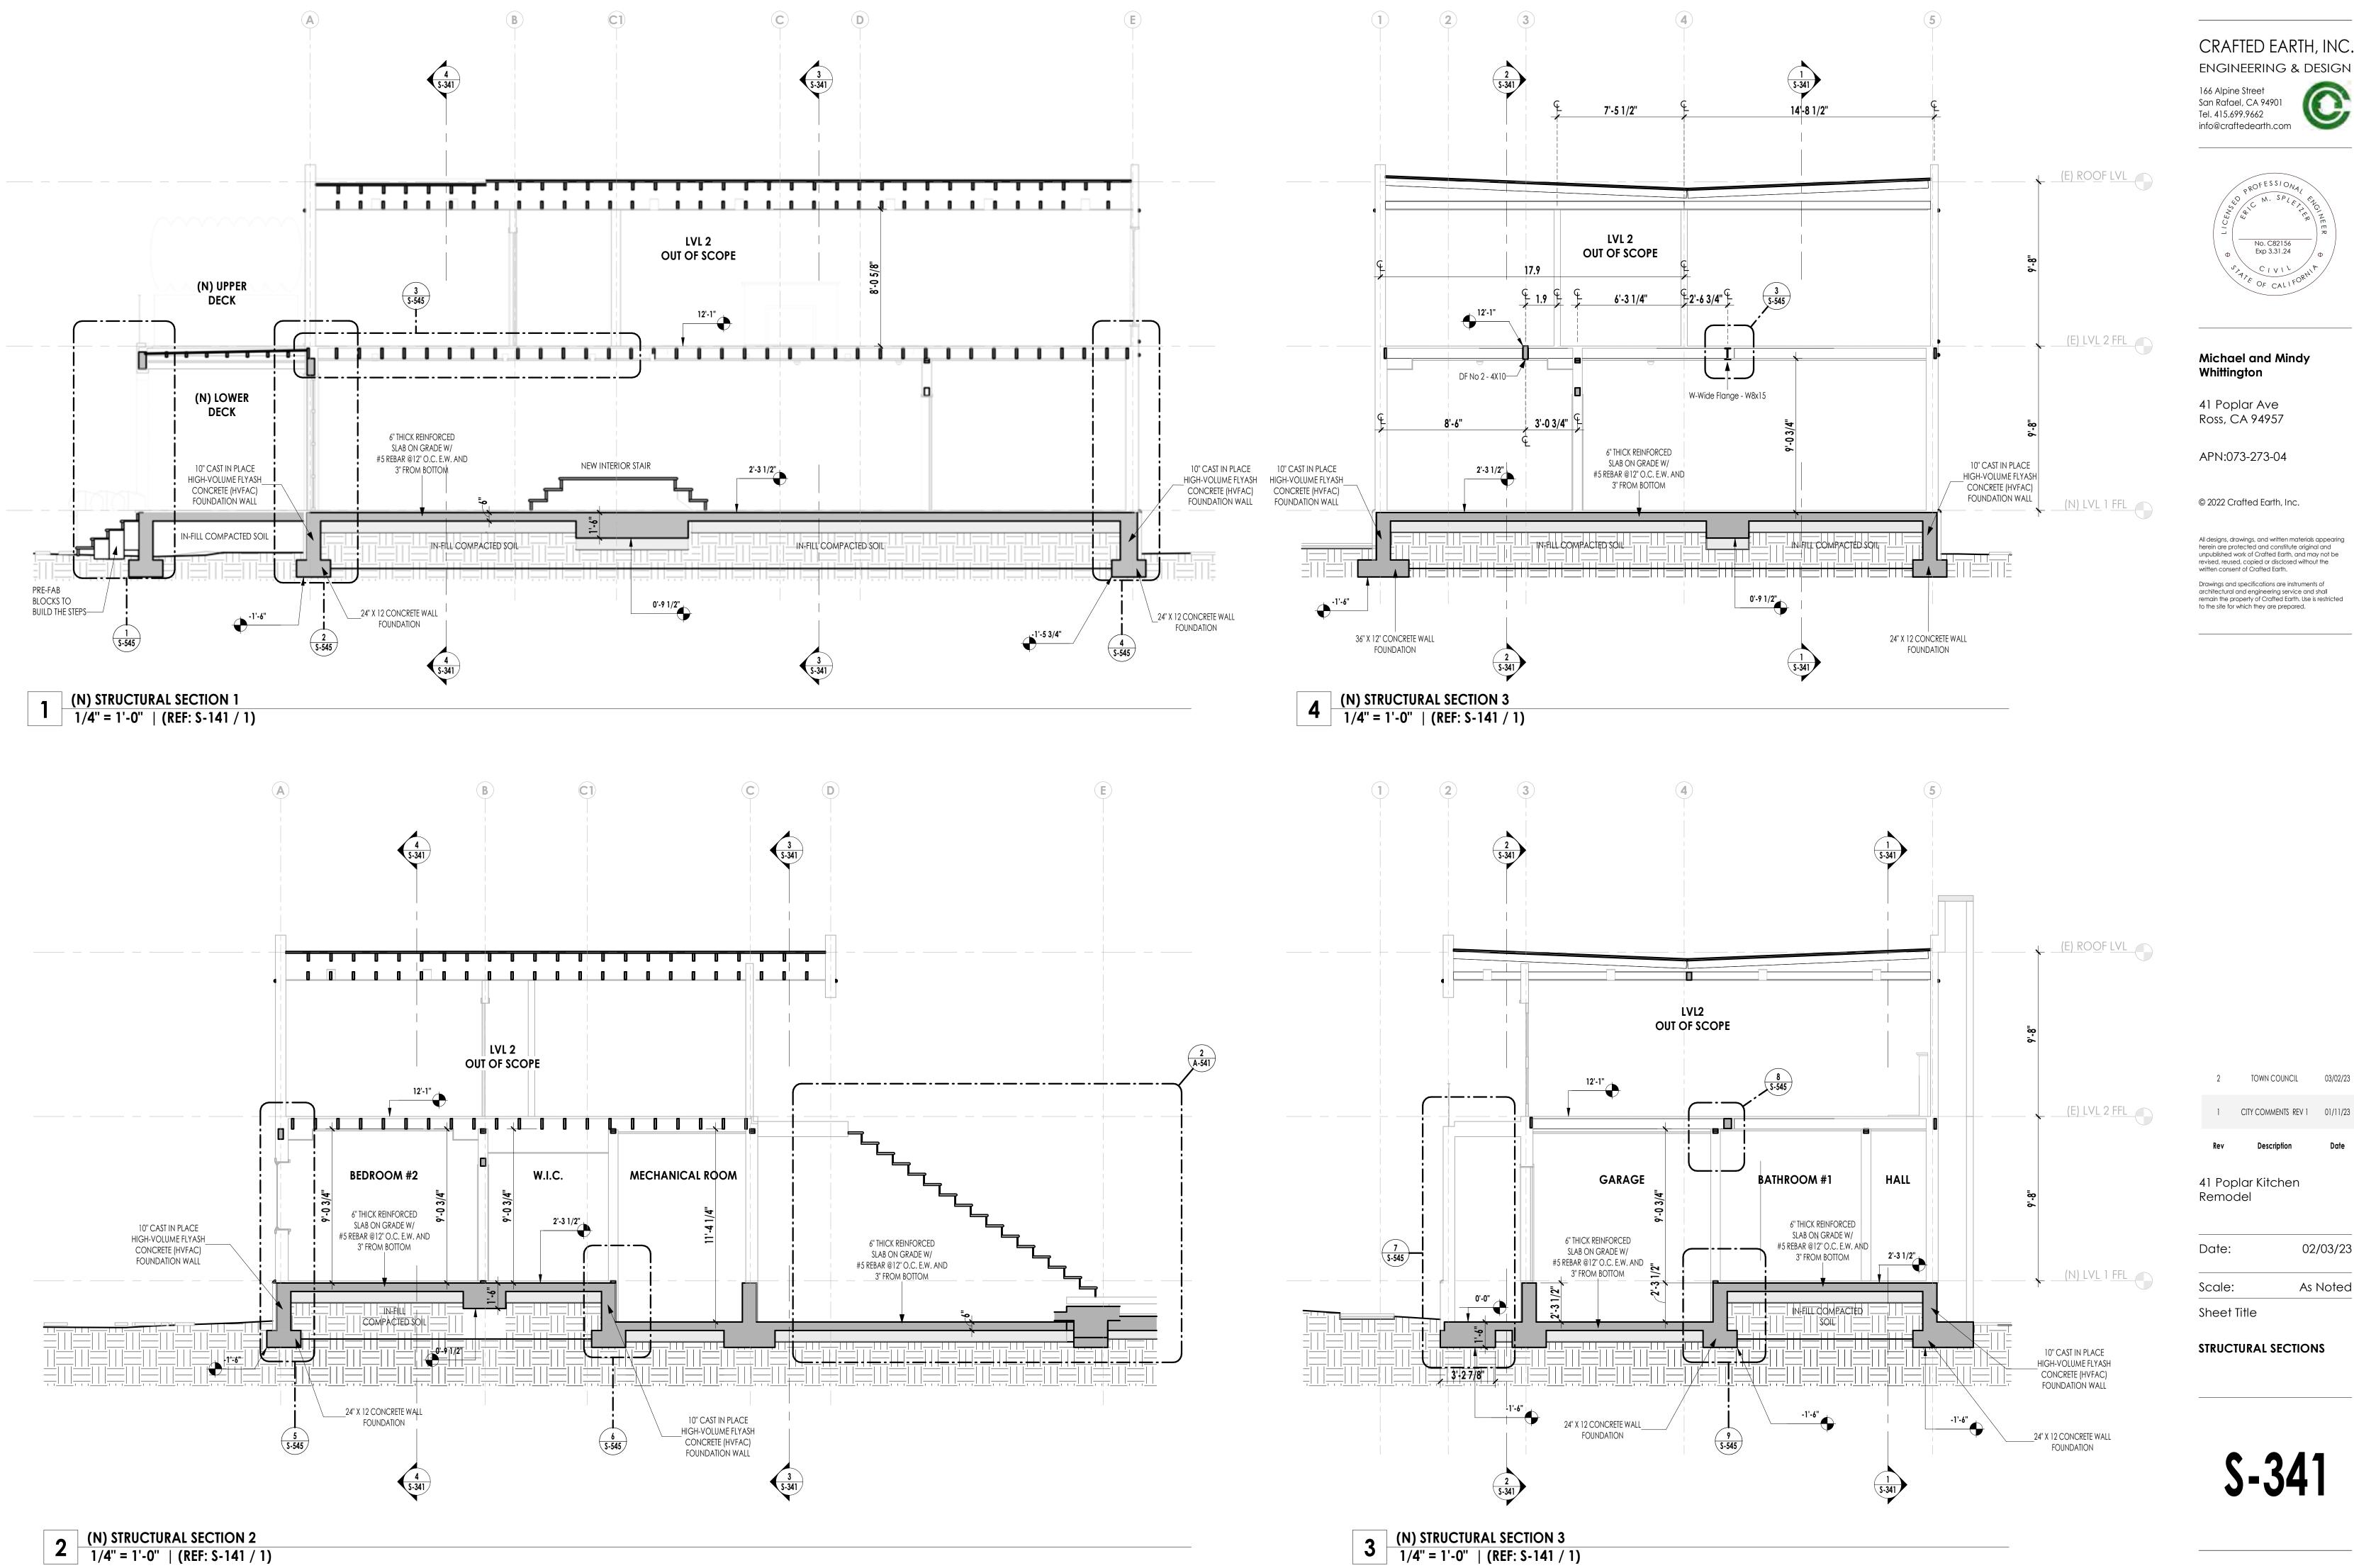
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1	CITY COMMENTS REV 1	01/11/23
2	TOWN COUNCIL	03/02/23

41 Poplar Kitchen Remodel

Date:	02/03/23
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SHEAR WALL ELEVATIONS






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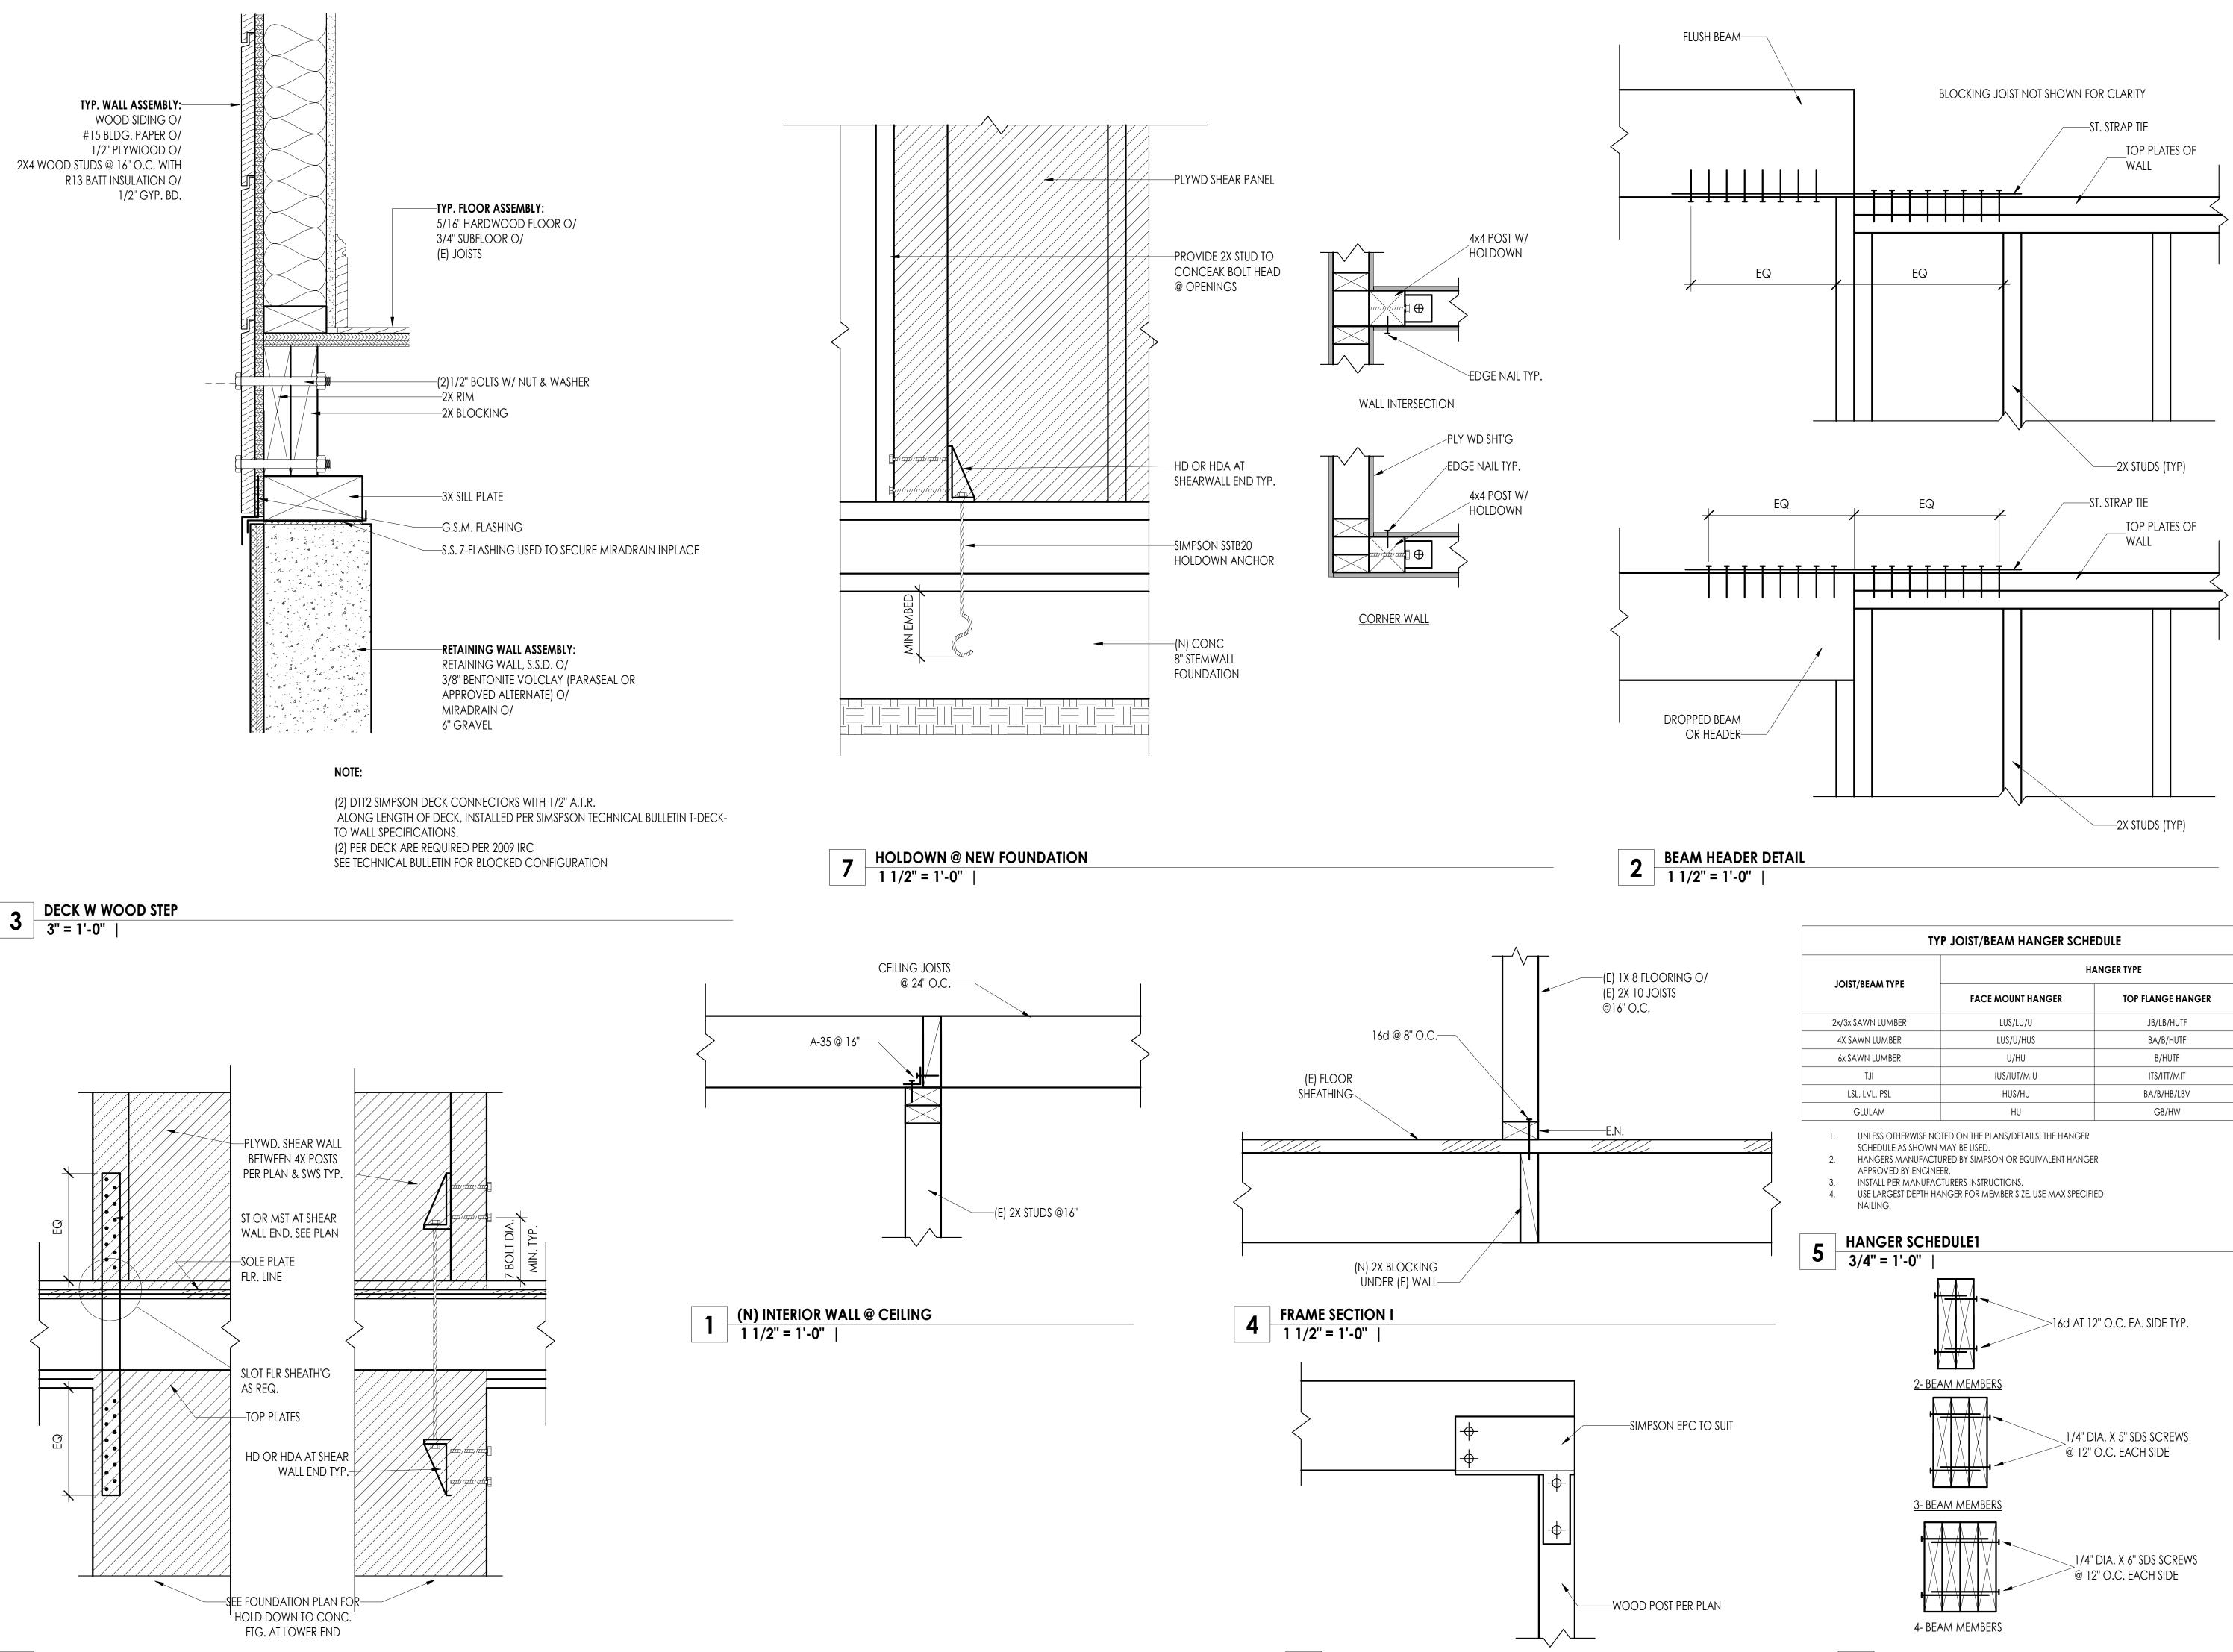
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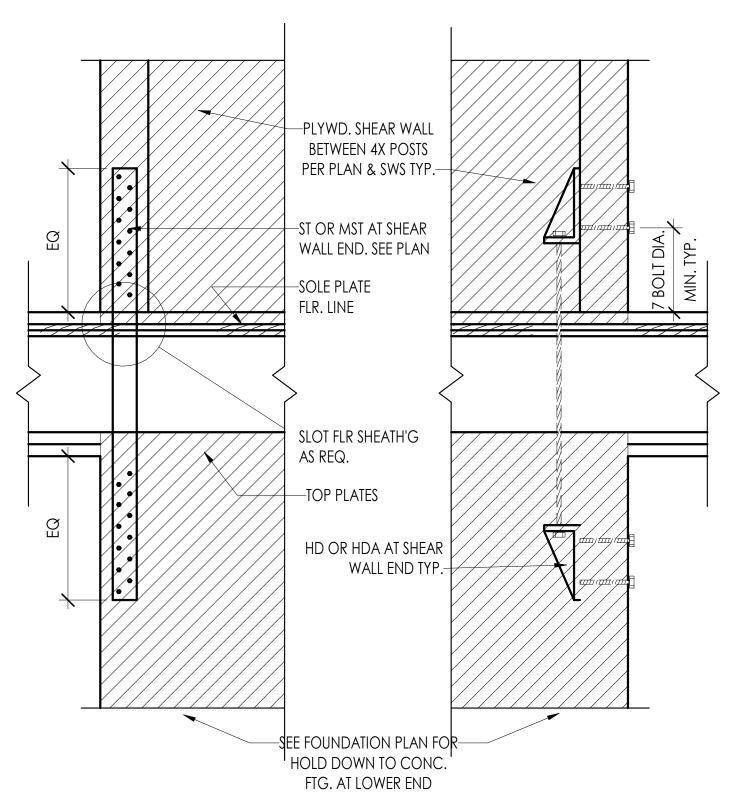



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TYPICAL FRAMING DETAILS

S-541

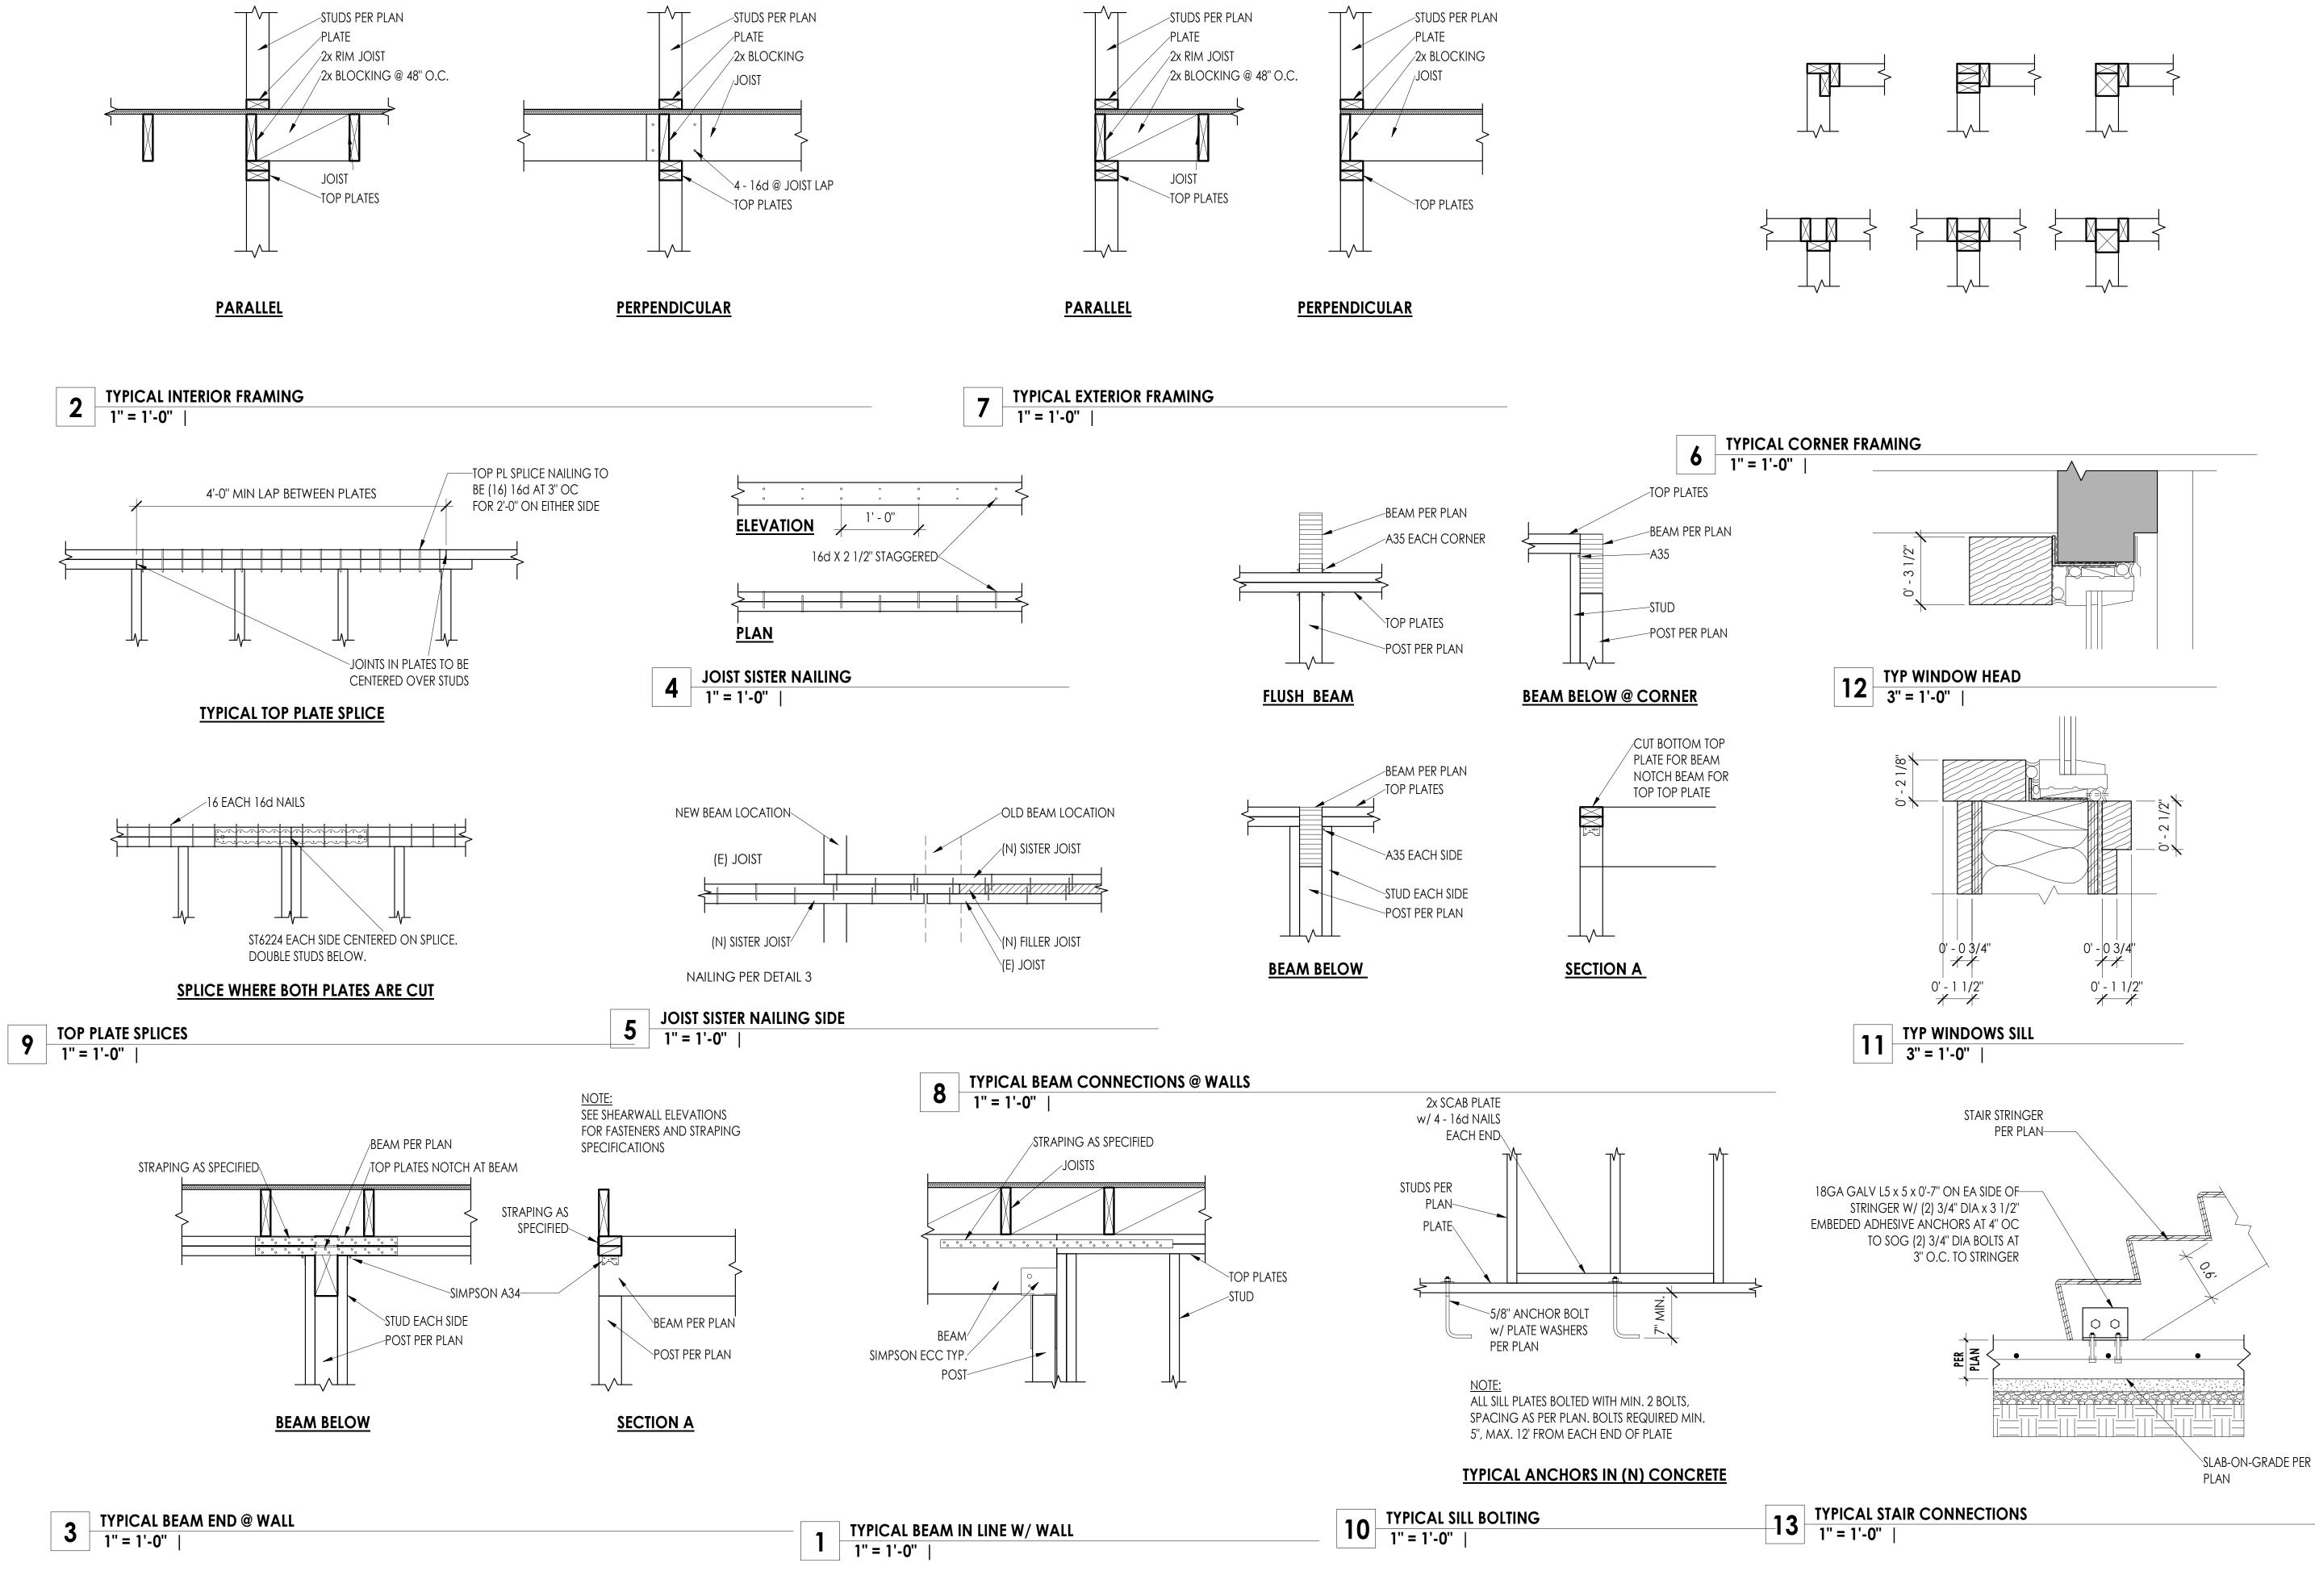



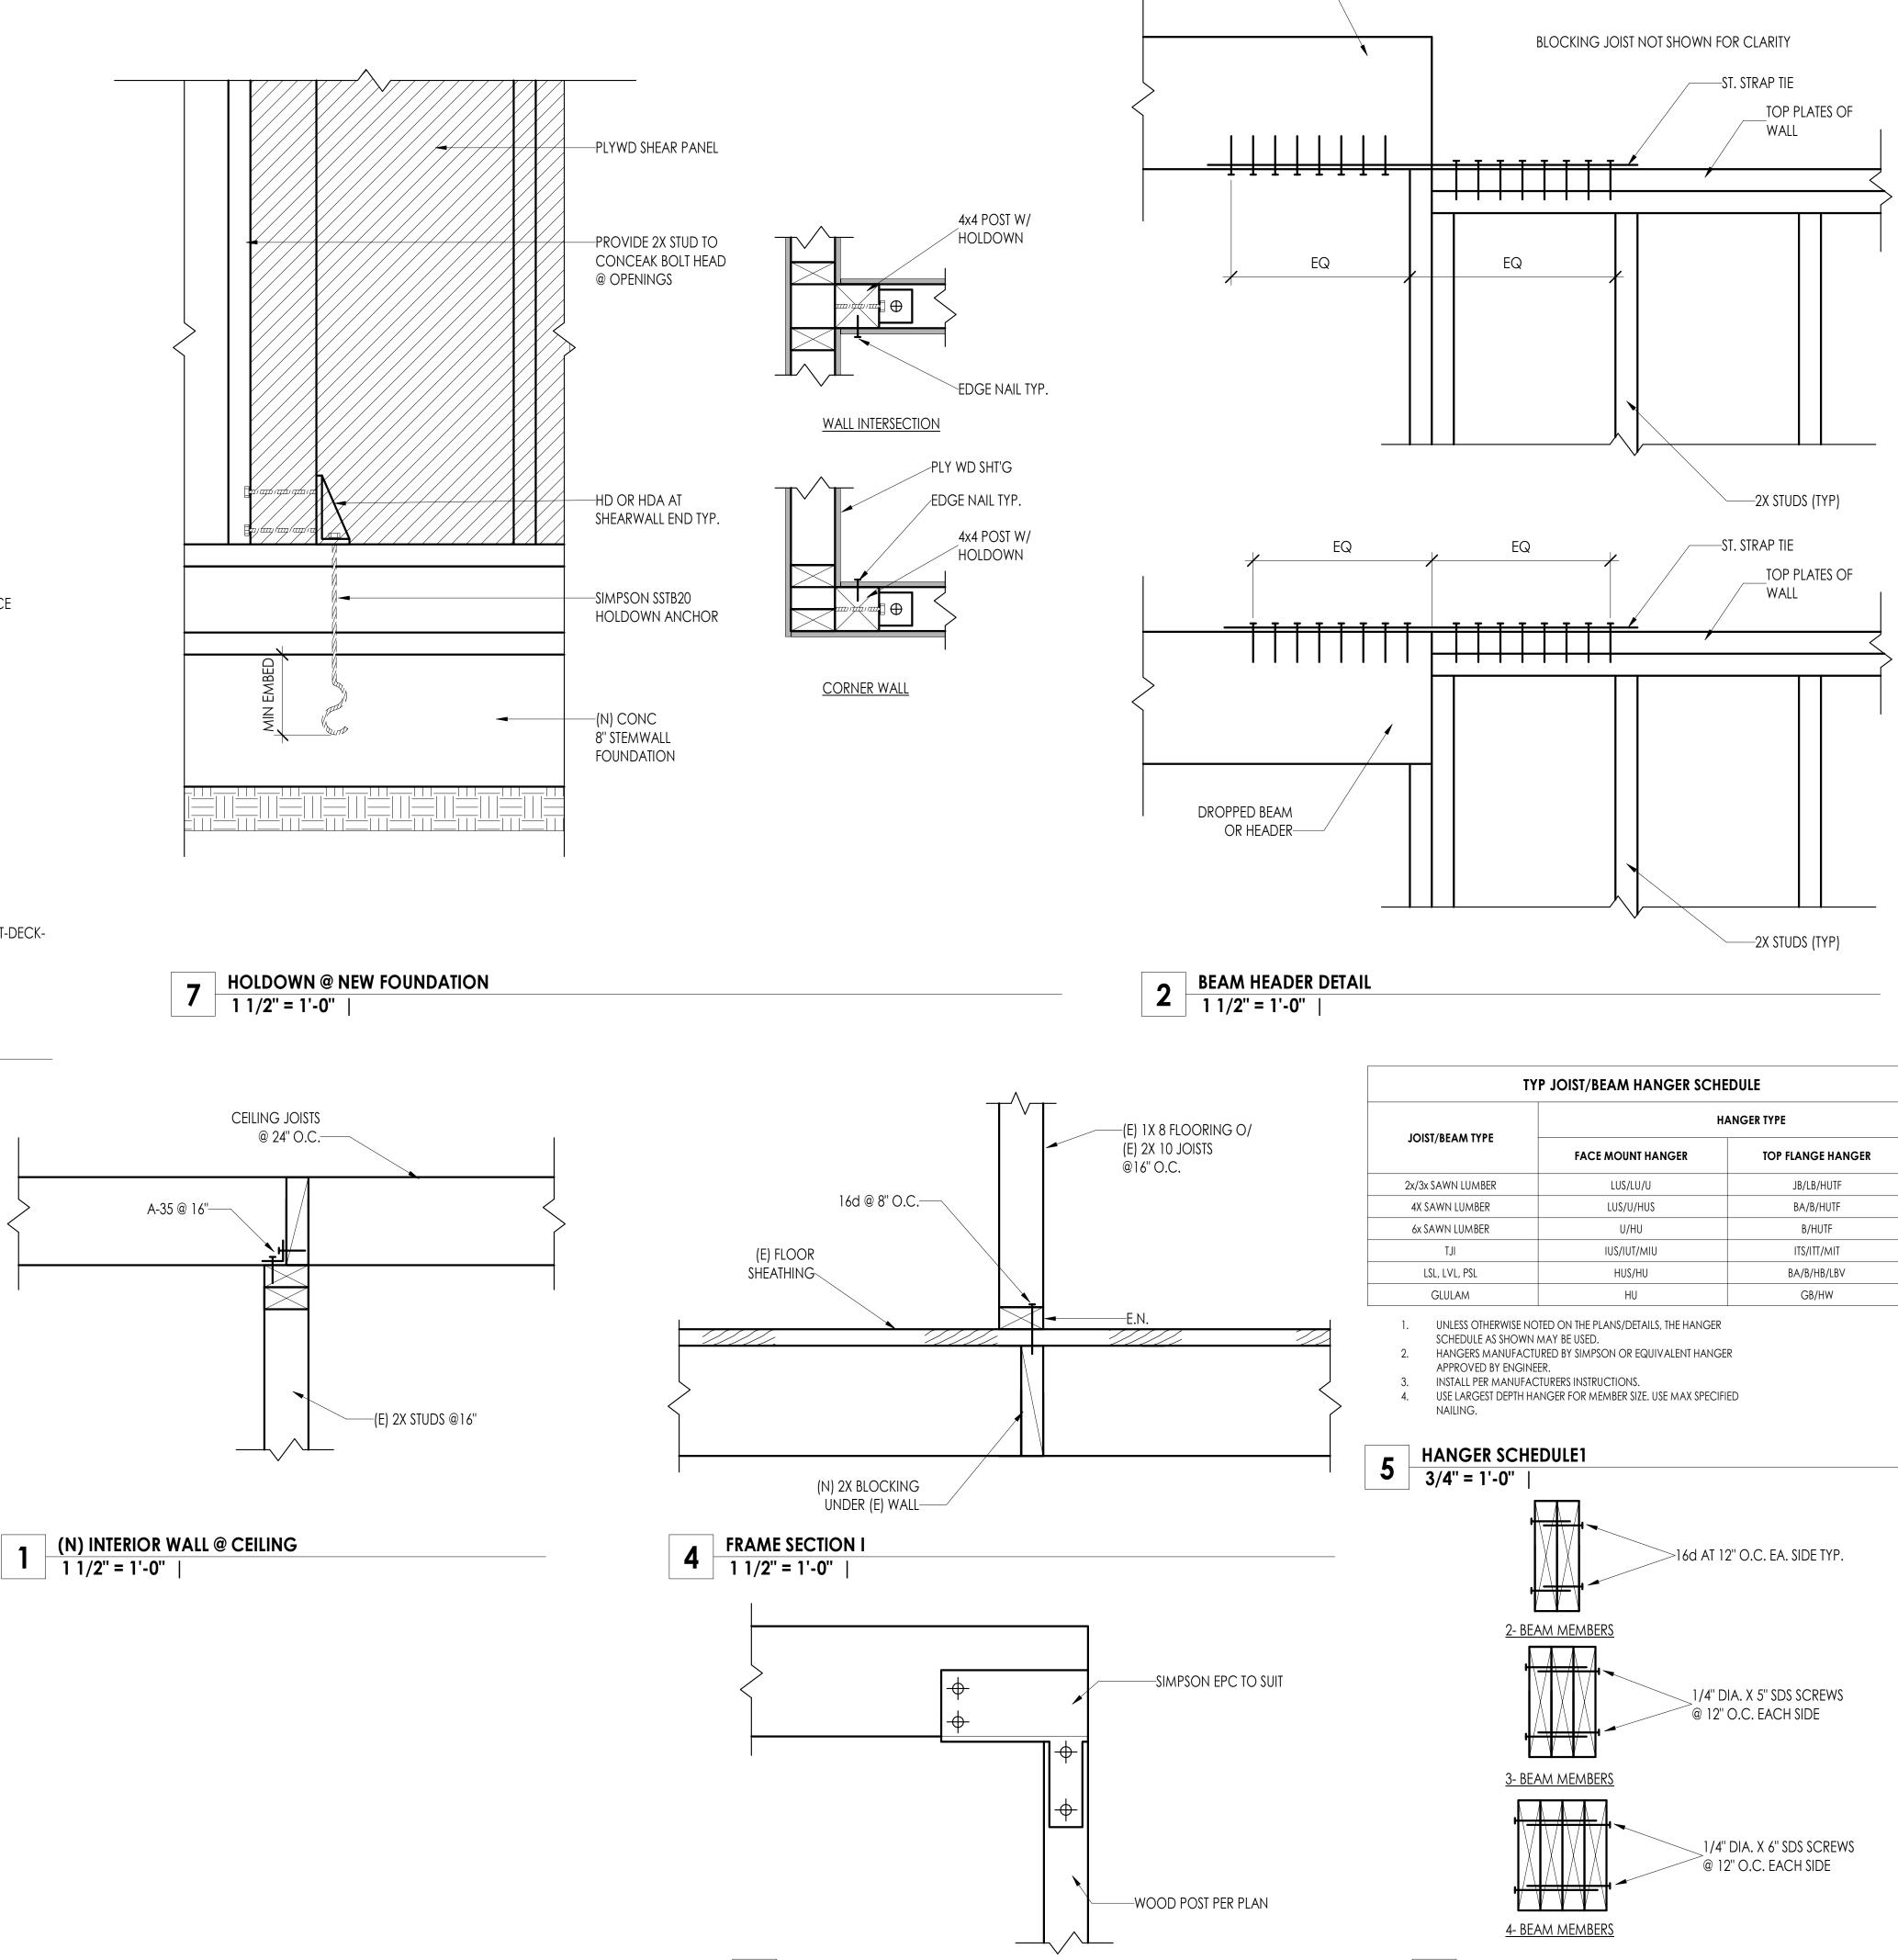

8 POST @ BEAM DETAIL 1 1/2" = 1'-0" |

T	(P JOIST/BEAM HANGER SCH	EDULE
	HANGER TYPE	
JOIST/BEAM TYPE	FACE MOUNT HANGER	TOP FLANGE HANGER
2x/3x SAWN LUMBER	LUS/LU/U	JB/LB/HUTF
4X SAWN LUMBER	LUS/U/HUS	BA/B/HUTF
6x SAWN LUMBER	U/HU	B/HUTF
TJI	IUS/IUT/MIU	ITS/ITT/MIT
LSL, LVL, PSL	HUS/HU	BA/B/HB/LBV
GLULAM	HU	GB/HW



CRAFTED EARTH, INC.

ENGINEERING & DESIGN

No. C82156 Exp 3.31.24 CIVIL

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Whittington

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41 Poplar Kitchen Remodel


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TYPICAL FRAMING DETAILS

S-542



SHEAR WALLS-D3 MULTI MEMBERS MIN CONNECTION **9** SHEAR WALLS-D3 1 1/2" = 1'-0" |

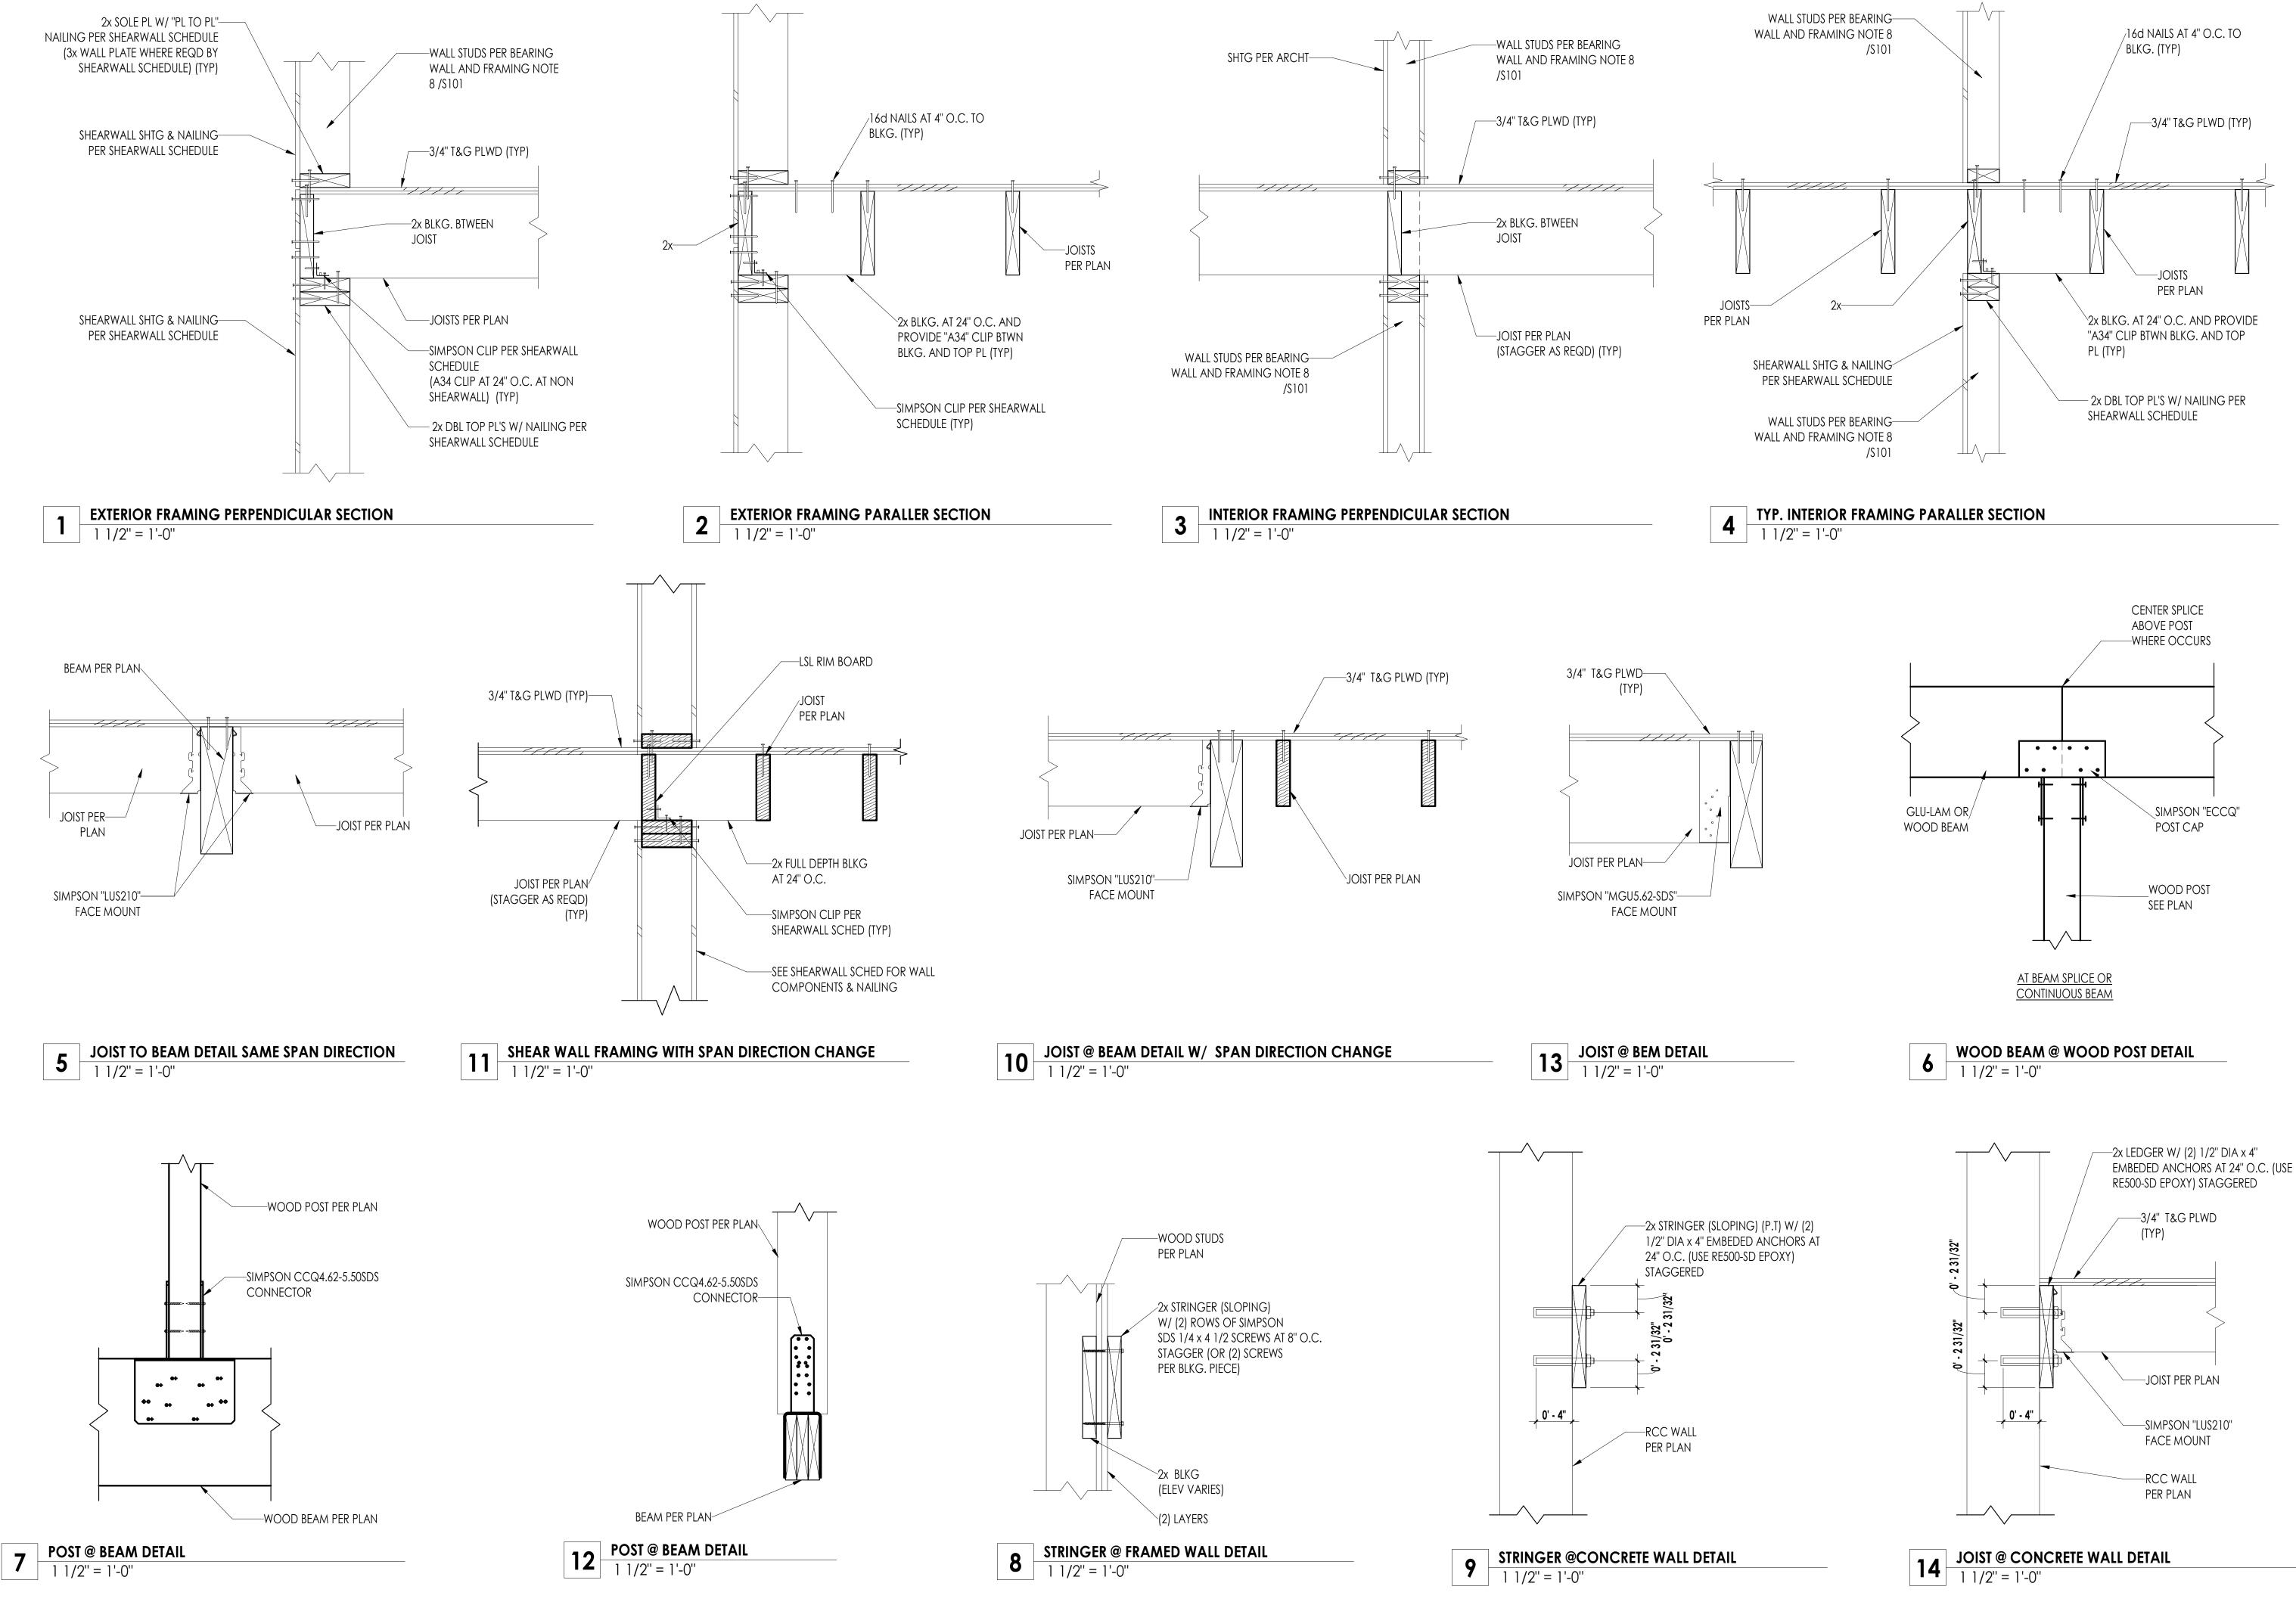

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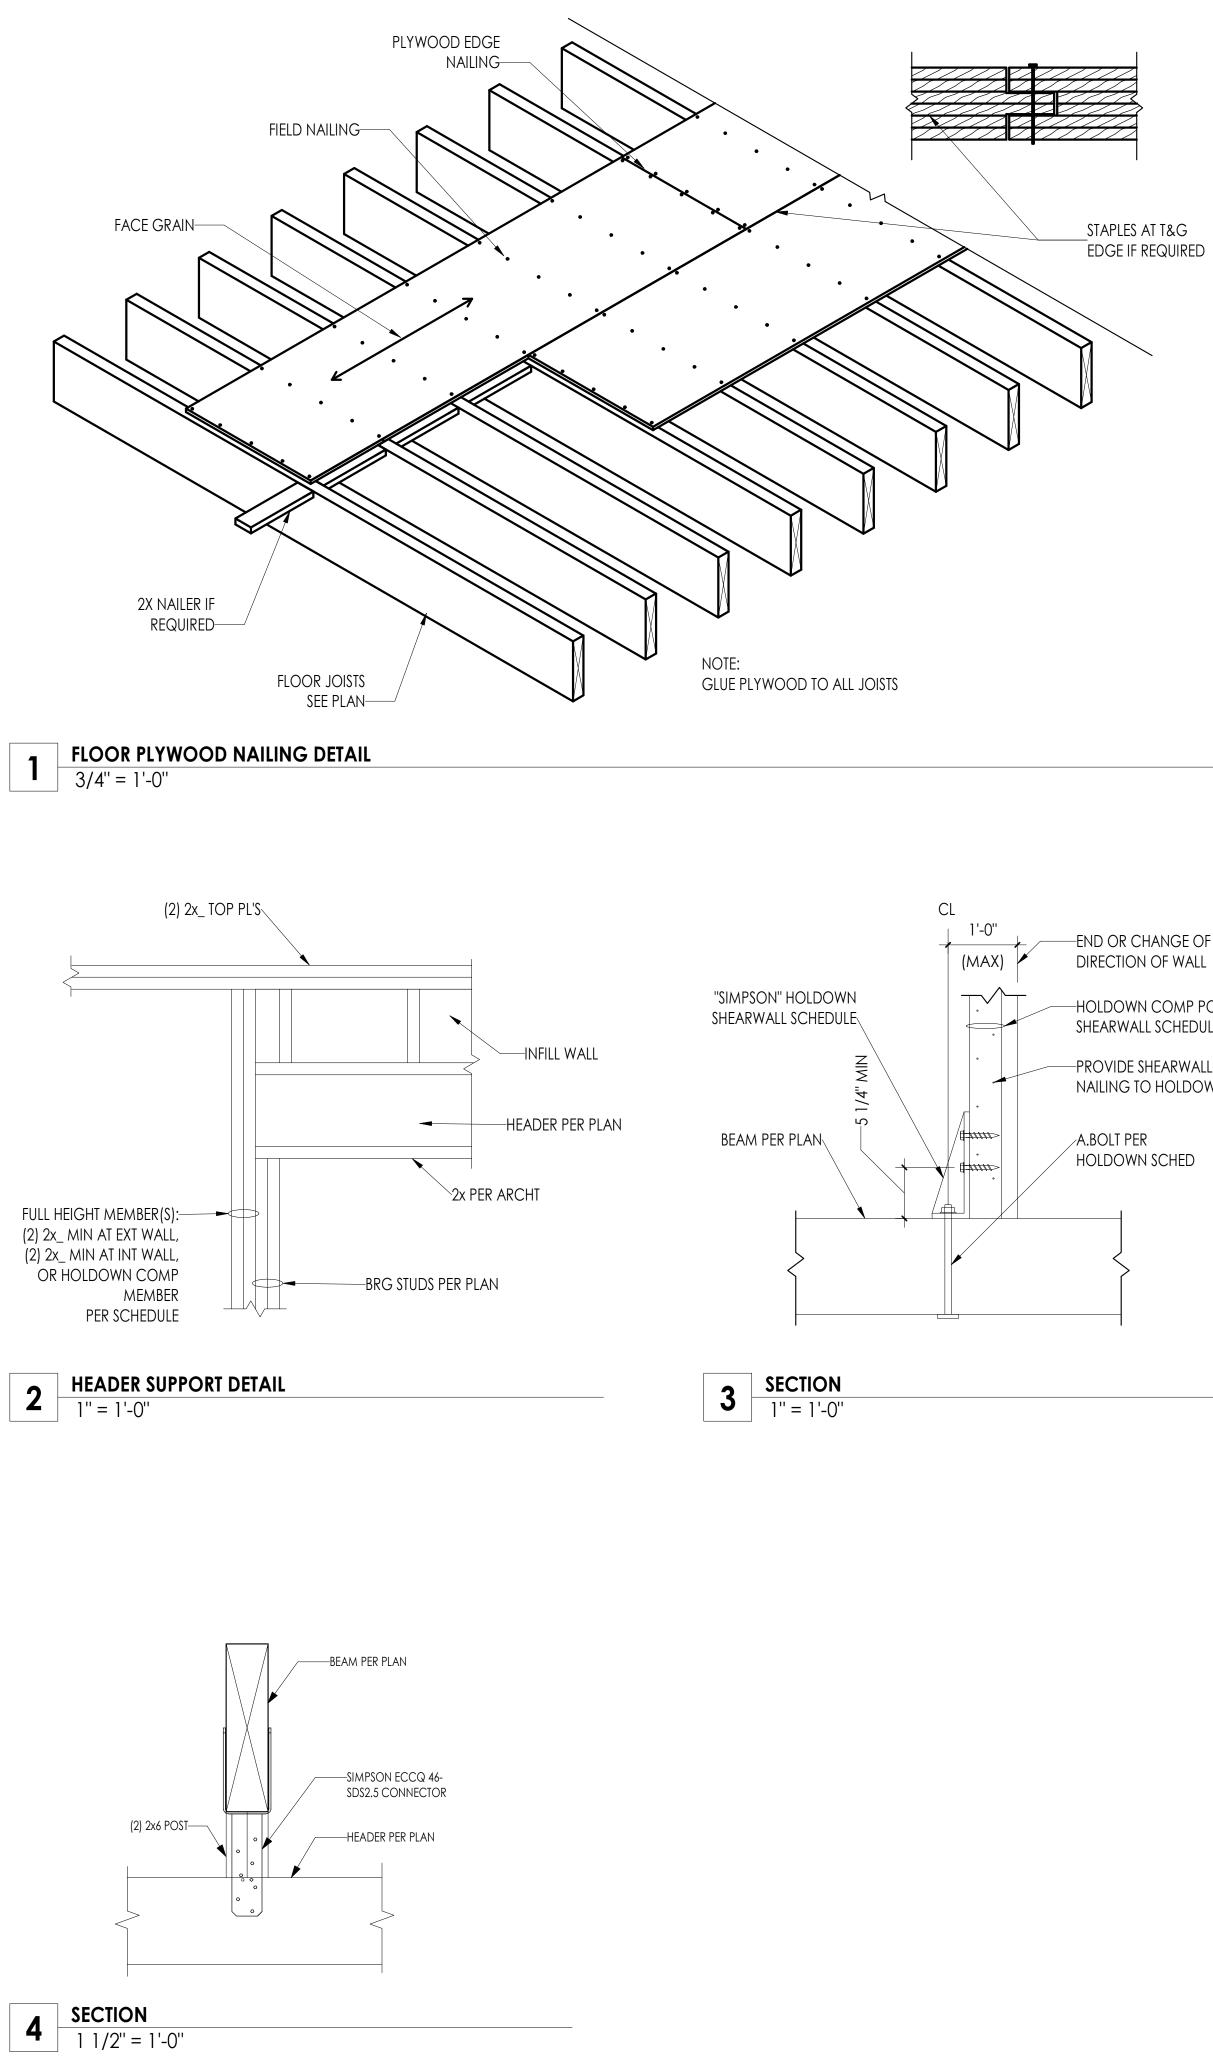
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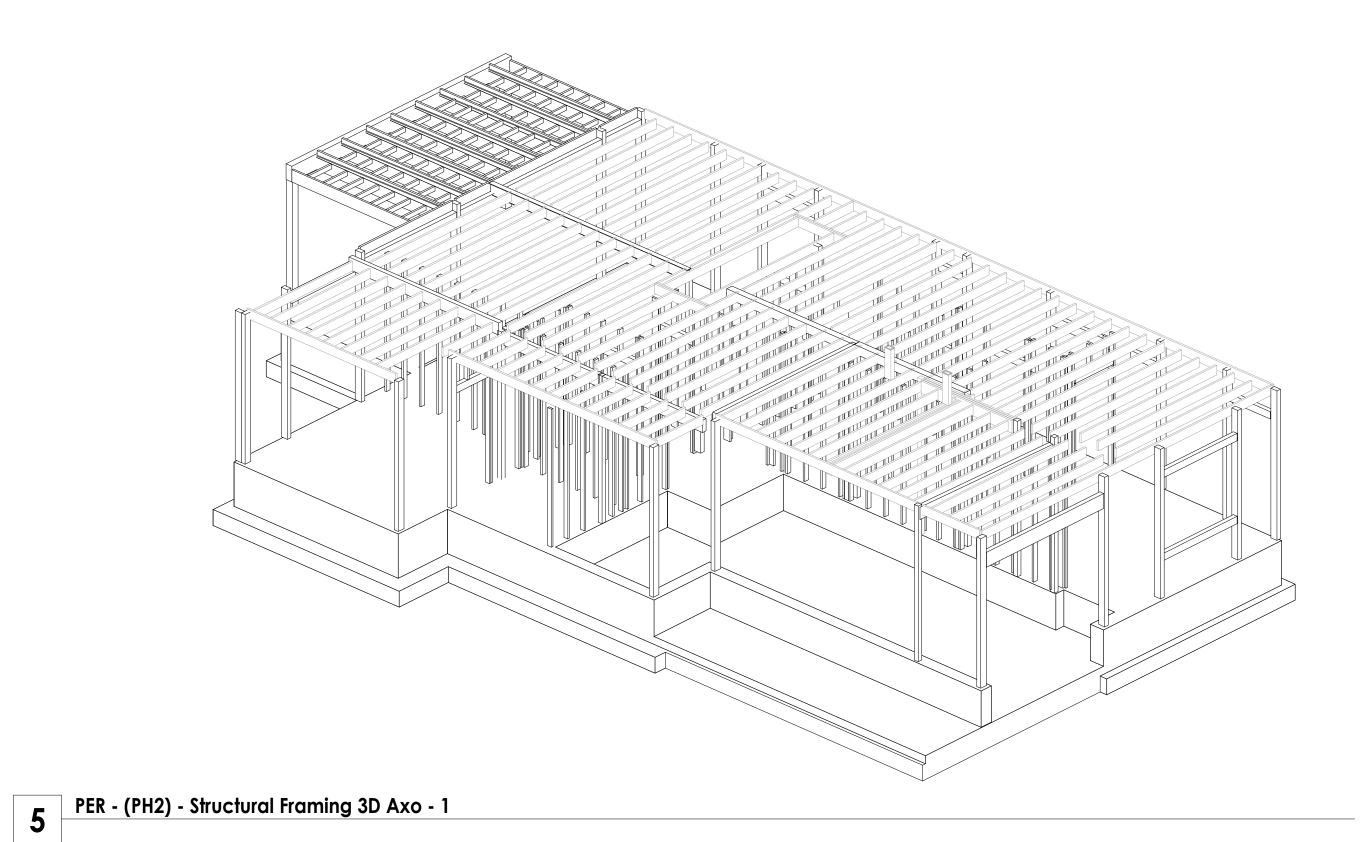
	2	TOWN COUNCIL	03/02/23
	1	CITY COMMENTS REV 1	01/11/23
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FLOOR FRAMING DETAILS

S-543



_staples at t&g EDGE IF REQUIRED




----------------------END OR CHANGE OF

-HOLDOWN COMP POST PER SHEARWALL SCHEDULE

NAILING TO HOLDOWN POSTS

A.BOLT PER HOLDOWN SCHED

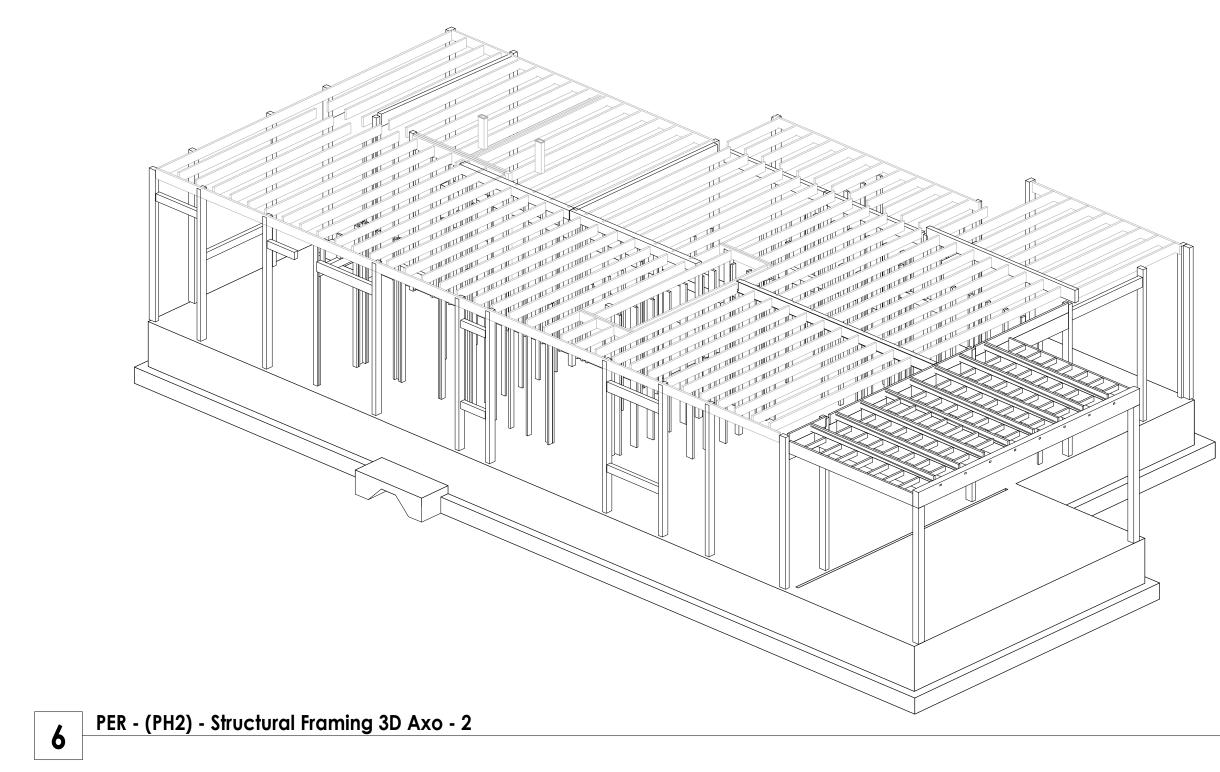

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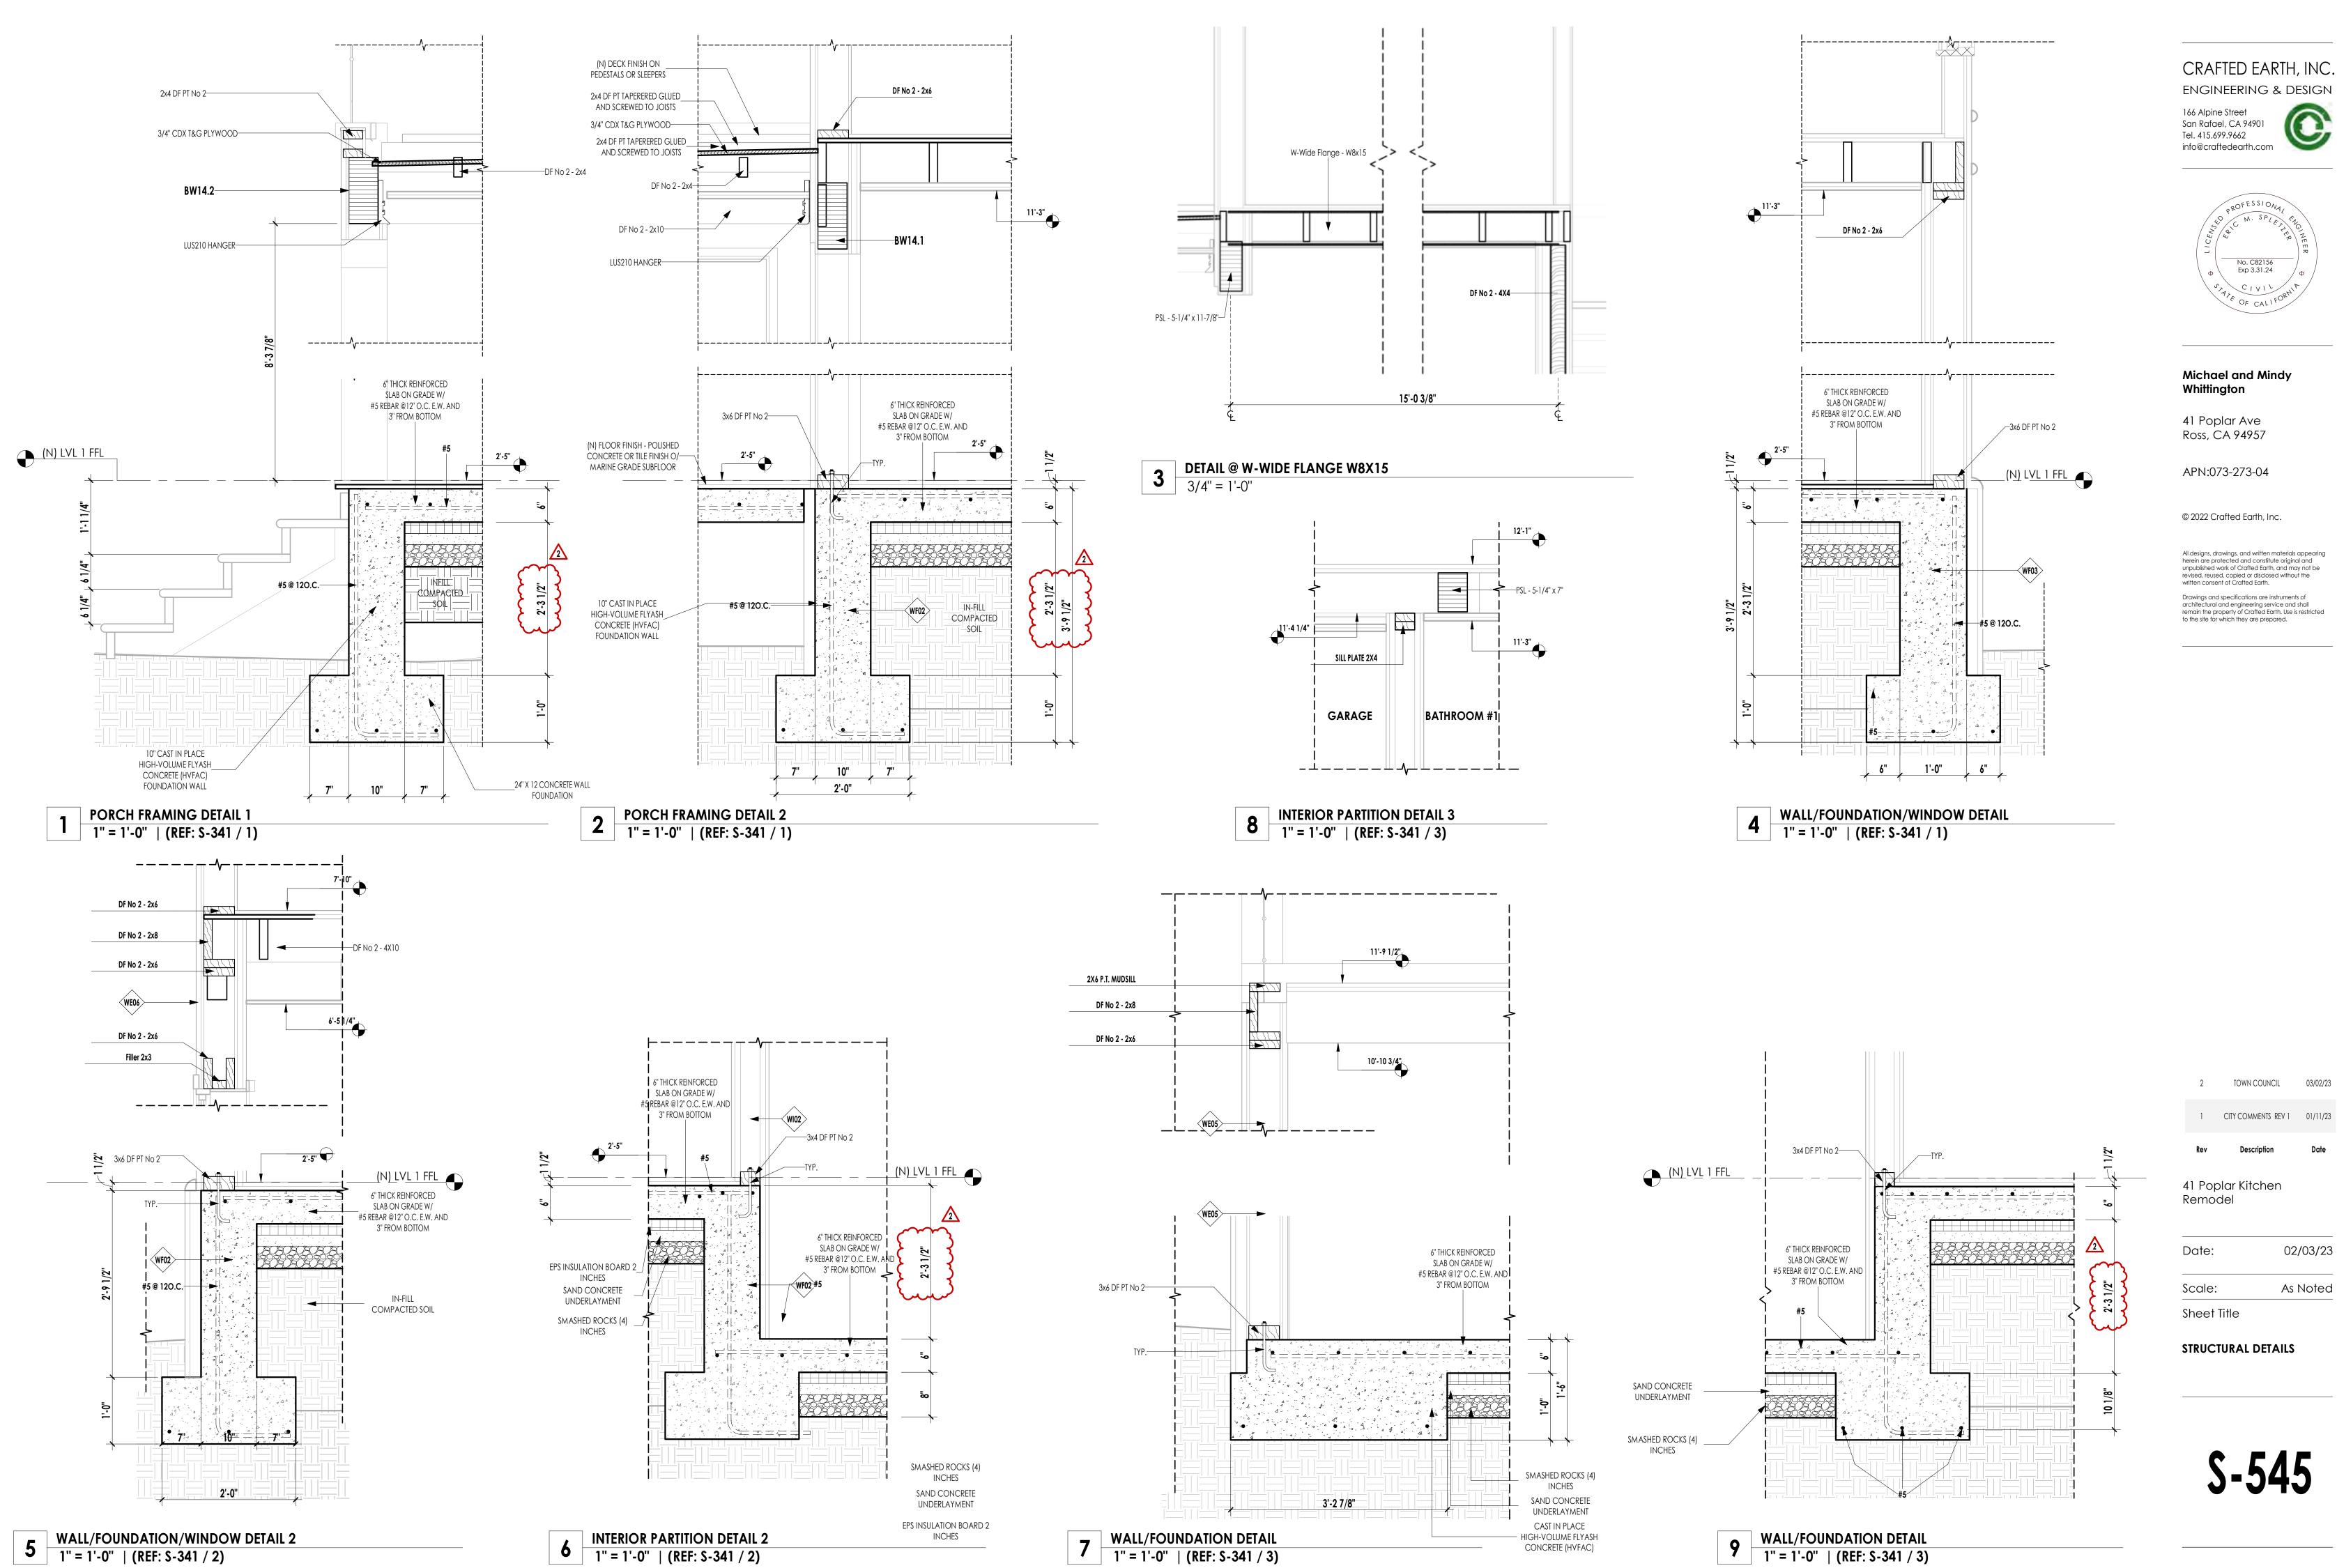



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FLOOR FRAMING DETAILS

S-544







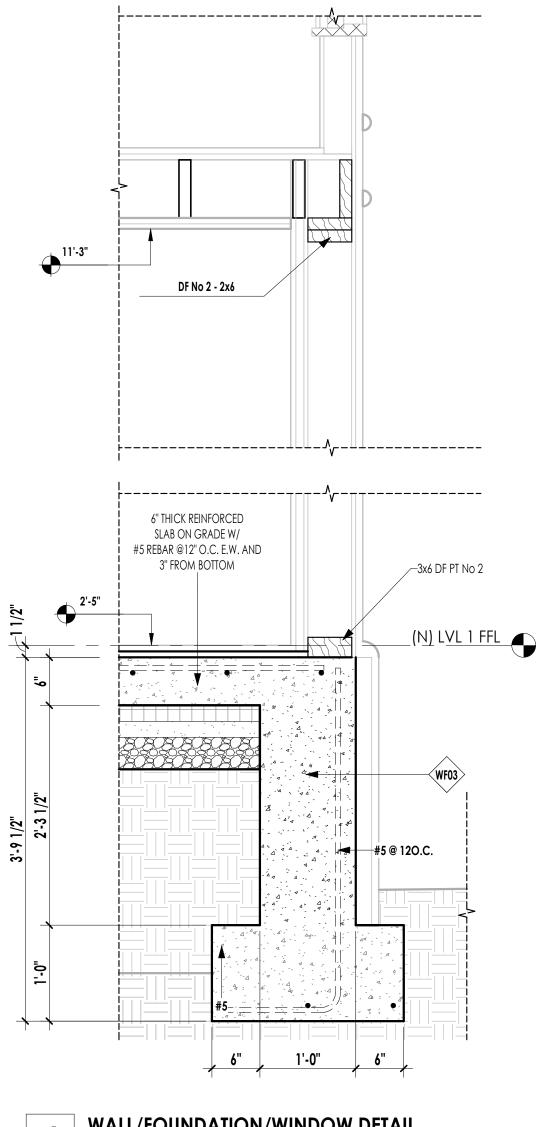

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	01	02	03	04	05	0	6 07 dth Heigh	08	Area	10	11 U-factor	12	13 SHGC	14 Exterior	15 Vt
	Name	Туре	Surface	Orientatio	on Azimu	ALC: NOTE: N	t) (ft)	6 Mult.	(ft ²) U-4	lactor	Source	SHGC I	Source	Shading 5	Status Ex Cor
	000r-n-DE08 Wind-a 1	Window	-	Left Back	55	11		1		1.58	NERC				New
	Wind-a 2	Window		Back	155		4.5	1		0.58	NFRC		2004		litered
v		t has been generi viet guarantice, th	163485A-000-000 and by CariSel Home for ectorizity of comple undiards - 2019 Ref	Energy Effici teness of the	ency Rating 5 estumation	ieston Ser	vices, the (CAE) in this document Repo	RS) using in rt Version: ma Version	2019.2.000 nev 20200	oater oy 901 2/Time	12 13:11 thore parties in 1: 2022-10-1 oplar_addit	6T20:22:0	th or related Report Ge 3-07:00	vider: CHEERS /here	hyne, Chéteikis (g
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V Regist CA Bu CERTII Projec Calcul SLAB F	FICATE OF 1 ct Name: 43 lation Desc FLOORS 01 Name On Grade-n Slab On rade-ex	COMPLIANCE I Poplar addit ription: Title 02 Zone Addition Garage & M	tion 24 Analysis 03 Area (f 1 389 toch 304 0NS		Perimeter 54 42	(ft)	Edge Insul. R-value and Depth none none	Edi R-v	File Name 06 ge Insul. alue and Depth 0		90% 0%	Near No	ted o	New Existing	Condi n/
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CERTII Projec Calcul SLAB F	FICATE OF 1 ct Name: 43 lation Desc FLOORS 01 Name On Grade-n Slab On rade-ex	COMPLIANCE I Poplar addit ription: Title 02 Zone Addition Garage & M room	tion 24 Analysis 03 Area (f 1 389 toch 304 0NS		Perimeter 54 42	(ft)	Edge Insul. R-value and Depth none none	Edi R-v	File Name 06 ge Insul. alue and Depth 0	Carpe	90% 0% 0% 06	Mear Ni Ni rior	ted	New	Condi n/
CERTII Projec Calcul SLAB F	FICATE OF 4 ct Name: 41 lation Desc FLOORS 01 Name On Grade-n Slab On rade-ex UE SURFACE 01	COMPLIANCE I Poplar addit ription: Title 02 Zone Addition Garage & M room CONSTRUCTIO	tion 24 Analysis 03 Area (1 5 5 5 5 5 5 5 5 5 5 5 5 5 5 5 5 5 5 5	Constru	Perimeter 54 42 03		Edge Insul. R-value and Depth none none	Ed, R-y	06 ge Insul. alue and Depth 0 0 0 0 0 0 0 0 0 0 0 0 0 0 0 0 0 0 0	Carpe	90% 0% 0% 06 nterior / Exte Continuou	Mear Ni Ni rior s U-fau	ted	New	Condi n/ Nr 08 08 Oly Layers Cypsum Boar
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V Regist Norrice respond CA Bu CERTII Projec Calcul SLAB F	Pile document be for, and comp le for, and comp FICATE OF (ct Name: 4) lation Desc FLOORS 01 Name 01 Name 01 Slab On rade-ex 01 estruction N Wall ex	COMPLIANCE Poplar addit ription: Title 02 Zone Addition Garage & M room CONSTRUCTIO ame S E	tion 24 Analysis 03 Area (1 5 500 00 00 00 00 00 00 00 00 00 00 00	Constru Wood Fr	Perimeter 54 42 03 ction Type amed Wall		Edge Insul. R-value and Depth none 04 Framing 2x4 @ 16 in. 1	Edi B-y	06 ge Insul. alue and Depth 0 0 0 0 0 0 0 0 0 0 0 0 0 0 0 0 0 0 0	Carpe dity II	eted Fraction 90% 0% 0% 06 nterior / Exte Continuous R-value None / Non	Hear No No No No No No No No No No No No No	ted	New Existing Assemt Inside Finish: Cavity / Fran Sheathing / In Siding/shea Exterior finish Cavity / Fran Sheathing / In	Condi n/ N/ N/ N/ N/ N/ OS OS OS OS OS OS OS OS OS OS OS OS OS

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CERTIFICATE OF COMPLIANCE

Project Name: 41 Poplar addition Calculation Description: Title 24 Analysis Calculation Date/Time: 2022-10-16T20:22:03-07:00 Input File Name: 41 Poplar addition v20.ribd19

CF1R-PRF-01E (Page 2 of 13)

REQUIRED SPECIAL FEATURES

The following are features that must be installed as condition for meeting the modeled energy performance for this computer analysis. Non-standard duct location (any location other than attic) HERS FEATURE SUMMARY The following is a summary of the features that must be field-verified by a certified HERS Rater as a condition for meeting the modeled energy performance for this computer analysis. Additional detail is provided in the building tables below. Registered CF2Rs and CF3Rs are required to be completed in the HERS Registry. Building-level Verifications: - None --Cooling System Verifications: Minimum Airflow Verified Refrigerant Charge Fan Efficacy Watts/CFM sating System Verifications: Verified heat pump rated heating capacity

WAC Distribution System Verifications: Duct loakage testing Ducts located within the conditioned space (except < 12 lineal ft)

Domostic Hot Water System Verifications: –None –

01	01 02		03	04	05	06	07
Project Name	Conditioned Floor Ar	rea (ft ²) Numb	er of Dwelling Units	Number of Bedrooms	Number of Zones	Number of Ventilation Cooling Systems	Number of Water Heating Systems
41 Poplar addition	41 Poplar addition 2408		1	5	3	0	1
DNE INFORMATION		2.44		17.6			
01	02	03	ū	04	05	06	07
Zone Name	Zone Type	HVAC System	n Name 2	Cone Floor Area (ft ²)	Avg. Ceiling Height	Water Heating System 1	Water Heating System 2
	Souther States	10063	- 1116	1000	6	DHW atr	N/A
House 1st floor	Conditioned	HVAC n	ew	635	-9	[NU W 40]	inter a
House 1st floor House 2nd floor	Conditioned	HVAC n	201	1383	8	DHW alt	N/A

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Calculation Descrip	tion: Title 24	i Analysis					input	File Na	ame: 41_P	oplar_add	ition_v20	ribd19			
FENESTRATION / GLA	ZING	2	a – .	2		s - 2	8 8			0	2 - 3				
01	02	03	04	05	05	07	08	09	10	11	12	13	14	15	16
Name	Туре	Surface	Orientation	Azimuth	Width (ft)	Height (ft)	Mult.	Area (ft²)	U-factor	U-factor Source	SHGC	SHGC Source	Exterior Shading	Status	Verified Existing Condition
Wind-a-WN24	Window	Wall-a-D	Back	155	- 4	4.5	1	18	0.58	NFRC	0.67	NFRC	Bug Screen	Altered	No
Wind-a-WN201	Window	Wall-a-B	Back	155	2	4,5	1	9	0.58	NERC	0,67	NERC	Bug Screen	Altered	No
Wind-a-WN20.2	Window	Wall-a-fi	Back	155	2	4.5	1	9	0.58	NFRC	0.67	NFRC	Bug Screen	Altered	No
Wind-a-WN22	Window	Wall-a-R	Right	245	5	3.33	1	19.98	0.58	NFRC	0.67	NFRC	Bug Screen	Altered	No
Wind-ex-WN08 1	Window	Wall-ex-F	Front.	135	3.75	4	1	15	1.28	Table 110.6-A	0.8	Table 110,6-6	Bug Screen	Existing	No
Wind-ex-WN14	Window	Wall-ex-F	Front	335	7.82	3.5	1	27.37	1.28	Table 110.6-A	0.8	Table 110.6-B	Bug Screen	Existing	No
Wind-ex-WN02 1	Window	Wall-ex-F	Front	335	2,5	3,42	1	11.55	1.28	Table 110.6-A	0.8	7ablo 110.6-B	Bug Screen	Existing	No
Wind-the WN02 2	Window	Wall-ex-F	Feget	335	2,5	3.42	1	8.55	1.28	Table 110.6-A	0.8	Table 110.6-8	Bug Screen	Existing	Nà
Wind-ex-WN01	Window	Wall-ex-L	Left	65	2.4	3.65	_1	8,76	1,28	Table 110.6-A	0.8	Table 110.6-B	Bug Screen	Existing	No
Wind-ex-WN04	Window	Wall-ex-L	Lett	65	2.5	3	1	7.5	1.28	Table 110.6-A	0.8	Table 110.6-8	Bug Screen	Existing	No
GIDoor-ex-DE07	Window	Wall-es-L	Left	65	5.33	6.67	1	35.55	1.25	Table 110.6-A	8.0	Table 110.6-B	Bug Screen	Existing	No
Wind-ex-WN17	Window	Wall-ex-8	Back	155	4.92	3.37	î	16.58	1.28	Table 110.6-A	0.8	Table 110.6-8	Bug Screen	Existing	No
Wind-ex-WN05	Window	Wall-ex-8	Back	155	1.75	2.5	1	4.38	1.28	Table 110.6-A	0.8	Table 110.6-8	Bug Screen	Existing	No
Wind ex-WN181	Window	Wall-co-8	Back	155	5.83	4.37	1	25.48	1.28	Table 110.6-A	0.8	Table 110.6-B	Bug Screen	Existing	No
Wind-ex-WN18.2	Window	Wulf-ex-B	Back	155	5.83	4.37	1	25,48	1.28	Table 110.6-A	0.8	Table 110-5-8	Bug Screen	Existing	No
Wind-tee-WN10	Window	Wall-ex-R	Right	245	11.25	5.6	1	63	1.28	Table 110.6-A	0.8	Table 110.8-8	Bug Screen	Existing	Nò

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oject Name: 41 Popla Iculation Description				감정 마라 연락하기	me: 2022-10-16T20 Poplar addition		영상에 관심하는 것은 것은 것을 알았다.
AQUE SURFACE CONST							
01	02	03	04	05	06	07	80
Construction Name	Surface Type	Construction Type	Framing	Total Cavity R-value	Interior / Exterior Continuous R-value	U-factor	Assembly Layers
Skylight area alt	Cathedral Ceilings	Wood Framed Celling	2x4 Top Chard of Roof Truss @ 24 in. O. C.	R-19	None / None	0.057	Roofing: Light Roof (Asehalt Shingle) Roof Deck: Wood Siding/sheathing/decking Cavity / Frame: R-19 / 2x4 Top Chrd Inside Finish: Gypsom Board
Wall int RD	Interior Walls	Wood Framed Wall	2x4 @ 16 in. D. E.	R-0	None / None	0.277	Inside Finish: Gypsom Board Cavity / Frame: no insul. / 2x4 Other Side Finish: Gypsom Board
Wall int alt	Interior Walls	Wood Framed Wall	2×4 @ 16 m 0. C	R-13	None / None	0.092	Inside Finish: Gypsum Board Cavity / Frame: R-13 / 2x4 Other Side Finish: Gypsum Board
Well Int new	Interior Walls	Wood Framed Wall	2x4 @ 16 m. 0. C.	R-13	None / None	0.092	Inside Finish: Gypsum Board Cavity / Frame: R-13 / 2x4 Other Side Finish: Gypsum Board
Roof ex	Aitic Roofs	Wood Framed Ceiling	2x4 Top Chard of Root Truss @ 24 in: O. C	R-D	Notie / None	0.644	Roofing: Light Roof (Asphalt Shingle) Roof Deck: Wood Siding/sheathing/decking Cavity / Frame: no insul. / 2x4 Top Chro
Ceiling attic ex	Ceilings (below attic)	Wood Framed Ceiling	2x4 @ 24 in. O. C.	R-0	None/None	0.481	Cavity / Frame: no insul. / 2x4 Inside Finish: Gypsum Board
Floor Raised ex	Exterior Floors	Wood Framed Floor	2x6 @ 16 in. O. C.	R-0	None / None	0.244	Floor Surface: Carpoted Floor Deck: Wood Siding/sheathing/decking Cavity / Frame: no insul. / 2x8

CERTIFICATE OF COMPLIANCE Project Name: 41 Poplar addition

Calculation Description: Title 24 Analysis

OPAQUE SURFACES

01 02 Zone Name Wall-a-# House 1st floor Wall-a-L House 1st floor Wall-a-B House 1st floor Wall-a-R House 1st floor Wall-ex-F House 2nd floor Wall-ex-L House 2nd floor Wall-ex-B House 2nd floor Wall-ex-R House 2nd floor Wall-n-F Addition Wall-n-L Addition Wall-n-R Addition Interior Wail-a House 1st to Garage & Roor>>Garage & Mech room Mech room interior Wall to House 1st Addition loor>>Addition Interior Wall-n Addition>>Gera to Garage & ge & Mech room Mech room Ceiling-e House 2nd floor Ceiling attic ex Exterior Floor-ex House 2nd floor Floor Raised ex terior Floone over Garage & House 2nd floor Mech room Interior Floor over House 1st House 2nd floor floor

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CERTIFICATE OF COMPLIANCE Project Name: 41 Poplar addition

FENESTRATION / G	LAZING		2
01	02		03
Name	Туре		Surfac
Wind-ex-WN08 2	Windo	w	Wall-m
Wind-ex-WN08 3	Windo	~	Wall-ex
Wind-ex-WN02 3	Windo	~	Waß-en
Wind-n-WN21	Windo	w.	Wall-n
Wind-n-WN23	Windo	w	Wall-n
Skylights-n-WN19	9 Skyligt	it :	Skylight/
OPAQUE DOORS		3	
01			
Name	eê		Side
Door-e	K)		
Door-n	1	1.1	nterior W Mi
Door-n	I	-te	nteriar W
GarDoor-ex	-DE05		61
SLAB FLOORS			
01	02		
Name	Zone	0	
	-		-

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oject Name: 41	oplar addition						Calcula	tion Date/Tir	ne: 2022-10-16T2	2.22:03-07	00	0	Page 9 of
alculation Descrip	tion: Title 24 A	nalysis				1	Input Fi	ile Name: 41	Poplar_addition	v20.ribd19	f"		alla nerror r
PAQUE SURFACE O	DINSTRUCTIONS												
01	1 2	02	2	03		04		05	06	07	8	08	
Construction Nar	ne Surfa	сө Туре	Const	ruction Type	Fr	aming		Total Cavity R-value	Interior / Exterior Continuous R-value	U-factor		Assembly Layer	*
Floor Int RD	Interic	# Floors	Wood	Framed Floor	2x6 @	16 in. O. C		R-0	None / None	0.199	Sid Cavite	oor Surface: Carp Floor Deck: Woo ing/sheathing/de y / Frame: no Insi Jelow Finish: Gyp	od ocking ut. / 2x6
Floor Int es	Interic	er Floors	Wood	Framed Floor	2x6.@	2x6 @ 16 m, D, C		18-0	None / None	0.199	Floor Surface: Carpeted Floor Deck: Wood Siding/shearthing/decking Cavity / Frame: no insul. / 2x5 Ceiling Below Finish: Gypsum Board		
JILDING ENVELOPI		TION			-		7			_		04	
	01			02			03			CFM50			
Country insulat	ion Installation ((III)	нg	R-value Spray F	oam insulat	ion	Building Envelope Air Leakage			-			
Not	Requintd			Not Regu	red	E.)	11	Not P	bequired			n/a	
ATER HEATING SYS	TEMS						_						
01	02	03		04		05	i i	06	07		08	09	10
Name	System Type	Distributio	n Type	Water Heater 1	Name (II)	Solar H Syste		Compac Distributi	HERS WHITE	ation	Status	Verified Existing Condition	Existing Water Heating System
DHW alt	Domestic Hot Water (DHW)	Standa Distribu Syster	tion	Tankiloss	- (1) n/a			None	n/a		Altered	No	

Registration Number: 422-P010163485A-000-000-0000000-0 MOTICE: This deciment has been generated by Carbon Awne Energy Effor responsible fix, and carbon guarantee, the assurace or completeness of the CA Building Energy Efficiency Standards - 2019 Residential Co

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CF1R-PRF-01E 13) Calculation Description: Title 24 Analysis

Calculation Date/Time: 2022-10-16T20:22:03-07:00
Input File Name: 41_Poplar_addition_v20.ribd19

CF1R-PRF-01E

(Page 3 of 13)

03 04 05 06 07 08 09 10 11 Verified Existing Window and Azimuth Orientation Gross Area (ft²) Tilt (deg) Wall Exceptions Status Construction Door Area (ft2) Condition Wall sit .535 front 42 0 -90 none Altered No Wall alt 112 88.7139 Liste 90 65 -none Altered No Wall alt 155 Back 441 63 -90 none Altered No Right Wall alt 245 119 19.95 90 none Altered No 79,47 Existing 392 Waltex 335 Frant none Na : 90 Wall ex. Left 265 51.8111 none -50 Existing No 65 Wallex 155 Back 392 71.9096 90 none Existing No Right 265 101,229 90 none Walles No 245 Existing Wall new 335 Front 193 90 Ex: w/ Siding New n/a 0 Wall new Left 185 22.68 90 Ex. w/ Siding New n/a 65 Right 35 7.5 Ex. w/ Siding Wallnew 245 90 New n/a Wall let alt n/a n/a___ 195 20 n/n Altored Nn Wall init R0 203 n/a n/e n/a Existing No 0 Wall int new n/a n/a 172 20 11/0 New n/an/a r/a 1383 n/a 1/2 Existing No 62 n/a n/a Existing No n/a n/a Floor Int ex n/a 304 Existing n/a n/a No n/a Floor int R0 n/a n/a 636 n/a n/a Existing No

			l,ribd19	ition_v20	oplar_add	me: 41_P	File Na	input					is
16	15	14	13	12	11	10	09	08	07	06	05	04	3
Verified Existing Condition	Status	Exterior Shading	SHGC Source	SHGC	U-factor Source	U-factor	Area (ft²)	Mult.	Height (ft)	Width (ft)	Azimuth	Orientation	ace
No	Existing	Bug Screen	Table 110.6-8	0.8	Table 110.6-A	1.28	14.82	1	3.92	3.78	245	Right	ex-R
No	Existing	Bug Screen	Table 110.6-8	0.8	Table 110.6-A	1.28	14,82	1	3.92	3,78	245	Right	ex-R
No	Existing	Bug Screen	Table 110.6-8	0.8	Table 110.6-A	1.28	8.59	1	3.37	2.55	245	Right	eio-R
n/a	New	Bug Screen	NERC	0.67	NERC	0.58	22.68	1	- 4	5.67	- 65	Left	-n=L
n/a	New	Bug Screen	NERC	0.67	NFRC.	0.58	7.5	1	1	2.5	245	Right	-n-R
n/a	New	None	NERC	0.25	NERC	0.43	. 8	1		1. 1.18	335	Front	tArea

02		03	04	8	05		06
le of Building	A	rea (ft²)	U-fact	tor	Status	Verified	Existing Condition
Wall-ex-F		20 -	0.5		Existing		No
Wall-a to Garag Mech room	p &	20			New		n/a
Wall-n to Garag Viech room	P &	20 0.5		Ŵ	New		n/a
SWall-ex-II	/all-ex-ii 63		1		Existing		No
03	04	05	05	07	08	09	10
Area (ft ²)	Perimeter (ft)	Edge Insul. R-value and Depth	Edge Insul. R-value and Depth	Carpeted Fraction	raction Heated		Verified Existing Condition
636	88	0000	0	80%	No	Existing	No

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Compliance	Report Version: 2019.2.000	Report Generated: 2022-10-16 20:22:50
	Schema Version: rev 20200901	

Project Nam		lar ad	No. Contraction	s.								한편이 가슴을	2022-10-167 plar_addition					F1R-PRF-0
WATER HEAT	ERS	-											<i></i>					
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CERTIFICATE OF COMPLIANCE Project Name: 41 Poplar addition

Calculation Description: Title 24 Analys DOCUMENTATION AUTHOR'S DECLARATIO

1. I certify that this Certificate of Compliance Documentation Author Name Igor Pichko Company. Energy Consult LLC Address: 1252 W 22nd St Unit #2

City/State/Zip: San Pedro, CA 90731

RESPONSIBLE PERSON'S DECLARATION STAT I certify the following under penalty of perjury, un Lettry the following under penalty of pervery, and Lettry the following under Division 3 of the Bail Lettry that the energy features and pi The building design features or system calculations, plans and specifications as Responsible Designer Name; Eds Solid Designer Name; Eric Spletzer npany: Crafted Earth, Inc.

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ATTACHMENT 3



CRAFTED EARTH, INC. 166 ALPINE ST SAN RAFAEL, CA 94901 TEL: 415.699.9662 E-MAIL: ERIC@CRAFTEDEARTH.COM

To:	TOWN OF ROSS – PLANNING DEPARTMENT
Attn:	ALEX LOPEZ – ASSISTANT PLANNER
RE:	WHITTINGTON RESIDENCE, 41 POPLAR AVENUE, APN 073-273-04 APPLICATION DRP22-0037
Date:	1/11/23
Applicant:	Crafted Earth, Inc. Eric Spletzer, PE 526 Third Street, Suite A2 San Rafael, CA 94901 Phone: 415-699-9662 Email: <u>eric@craftedearth.com</u>

The following comments were received on Dec 22nd, 2022. The comments follow in black, and the responses are in green bold print.

COMMENTS FROM PLANNING:

Provide a Zoning Parameters table. The table should have three columns, allowed, existing, and proposed. (Example below):

Please see the table on the sheet A-040 already provided.

Sheet A-201 and A-241 are showing elevations measurements from finish level to roof level. Provide the correct elevations for the planning department, showing the measurements from grade to the highest point of the roof, clearly showing the existing and proposed roof height.

18.12.080 Building height. "Building height" means the vertical distance as measured in a straight line from any point to either existing or finished grade, whichever is lower.

Sheets A-201 and A-241 were updated.

Can you provide the measurements for the proposed rear porch? It may be counted as floor area and building coverage.

Exterior measurements for the proposed rear porch are: Width **18'-8"**, **Depth: 9'-11"**. The reference view is A-142/1. The proposed rear porch is not counted as floor area and is already included in Lot Coverage calcs on sheet A-101 and summarized on the cover sheet A-040

Sheet A-101 shows the proposed rear porch encroaching to the side yard setback. A Variance is required. It is the continuation of an existing encroachment line on an onerous setback requirement.



CRAFTED EARTH, INC. 166 ALPINE ST SAN RAFAEL, CA 94901 TEL: 415.699.9662 E-MAIL: ERIC@CRAFTEDEARTH.COM

COMMENTS RECEIVED FROM BUILDING:

California Residential Code 305.1 ceiling height minimum of 7 feet. A-541/3 shows 6'10". 6'10 is at a landing. Room height downstairs is 8'9 7/8"

CRC 311.7.1 stair width of 3 feet minimum. A-541/1 shows a width of 30 inches.

New risers and threads necessary for the lift will be added at the bottom of the "existing legal not conforming stair run." Existing legal not conforming interior stair hole will be kept as it is. New treads will have a width of 30 inches min as shown on A-541/1.

Provide a handrail where four or more rises exist. A543/1 shows no handrail. The handrail was added. See sheet A541

COMMENTS RECEIVED FROM PUBLIC WORKS:

All work shall comply with the requirements of the Town of Ross Section 15.36 Flood Damage Prevention Code.

A pre-construction Elevation Certificate (EC) shall be provided prior to issuance of the Building Permit verifying that the design F elevation is 1.0' minimum above the 100-YR base flood elevation. A "during construction" EC shall be provided demonstrating that the F elevation will comply with the design F elevation. A "finished construction" EC will be required prior to Permit Final.

All three ECs will be provided by Adobe Assoc Engineers.

ATTACHMENT 4

MINUTES

Special Meeting of the Ross Advisory Design Review Group 7:00 PM, Tuesday, February 15, 2023

Video and audio recording of the meeting is available online at the Town's website at: townofross.org/meetings.

1. 7:00 p.m. Commencement

ADR Group Chair Kruttschnitt called the meeting to order. Present: Laura Dewar, Josefa Buckingham, Stephen Sutro and Mark Fritts. Director Rebecca Markwick and Assistant Planner Alex Lopez-Vega were present representing staff.

2. Approval of Minutes.

The ADR Group minutes were unanimously approved.

3. Open Time for Public Comments

No comments were provided.

4. Planning Applications/Projects

a. Property Address:	28 Walnut Avenue
A.P.N.:	073-171-03
Applicant:	Bressack and Wasserman Architects
Property Owner:	John and Gabrielle Bressack Gantus
Zoning:	R-1:B-10
General Plan:	ML (Medium Low Density)
Flood Zone:	X (Moderate Risk)

Project Summary: The applicant requests approval of Demolition and Design Review applications. The project includes remodeling and a renovation of the existing single-family home, removing the office and deck in the side yard setback, replacing the various roof structures with one coherent roof design, and demolition of the carport at Walnut Avenue. New landscaping and hardscape is also being proposed throughout the property

Director Markwick presented the project, as well as the project architect, Phoebe Bressack.

Andrew Bassick, Hanson Bridgett LLP spoke on behalf of the owners of 15 Walnut and 10 Olive, he mentioned the email that was sent previously. He indicated that the project applicant did not change anything to the design, instead changed the permitting strategy. There are still privacy issues for his client into their pool area. would impact his clients

privacy. He suggested continuing the item so that the architect can go back to the drawing board.

<u>Laura Dewar</u>

- Does not fee that the comments were heard that the applicant found a work around instead.
- Bridge increases bulk and mass.

Joey Buckingham

- Removed the ADU and the ADR is not allowed to comment, however the total development has a large feeling/
- Against the bridge, thinks the buildings would be better separated which would provide more breathing room.
- Bridge goes away and the fenestration could be better addressed.
- ADR typically does not allow second story decks, however it is very far away so there would be no privacy issues. The posts of the deck look spindly.
- Disappointed in the size of the ADU.
- Front door can be more celebrated, change the scale of the it to make it a grand front door.

Mark Kruttschnitt

- Mass is still too large.
- Does not like the bridge.
- Second story decks are never favorable, this one is not supported.

<u>Mark Fritts</u>

- Mass of the project is too large.
- If deck remains more detailing is needed and different railing treatment
- Agrees with the comments about the deck by Mark and Joey
- Shed roofs could use more details, including the whole façade.
- Agrees on the bridge, adds to bulk and mass.
- Eliminate the deck, although it is pretty far from the property line, the glazing needs to be worked out.

Stephen Sutro

- Thinks the deck is okay, however needs some more architectural details.
- Bridge is a little large but will defer to the rest of the ADR members.

b. Property Address: 10 Southwood Avenue

A.P.N.:	073-151-23
Applicant:	Julie Johnson/ JMJ Studios
Property Owner:	Ron Abta
Zoning:	R-1:B-20
General Plan:	L (Low Density)
Flood Zone:	X (Moderate Risk)

Project Summary: The applicant requests approval for Design Review, and a Variance. The project includes demolishing the existing carport between the main house and the cottage and construction of a new pergola style carport, as well as relocating the driveway, and adding a new dormer. The project also proposes new landscaping and hardscape throughout the property.

Mark Kruttschnitt recused himself because he lives within 500 feet of the property. Assistant Planner Lopez gave the staff report and presentation. Julie Johnson presented the project on behalf of her clients.

The public hearing was opened, and no one wished to speak.

Stephen Sutro

- Project looks great.
- Suggested some design changes for the trellis, mock it up, larger posts.

<u>Laura Dewar</u>

- Supports project, moving the driveway makes sense.
- The Trellis color might make it stick out, love the house color.
- Changes to guest house seem fine.

Joey Buckingham

- Love the green of the house color.
- Trellis color is too bright and having it white will be a maintenance nightmare.
- Suggests painting the parking trellis the same color as the house.
- The guest house should match the main house.

Mark Fritts

- Supports the project as designed.
- Front door trellis can be white.
- Parking trellis should be darker.
- The green is very dark; however it is a personal opinion
- Successful project

c. Property Address:	41 Poplar Avenue
A.P.N.:	073-273-04
Applicant:	Eric M. Spletzer
Property Owner:	Michael and Mindy Whittington
Zoning:	R-1:B7_5
General Plan:	ML (Medium Low Density)
Flood Zone:	AE (Floodway)

Project Summary: The applicant is requesting approval of Design Review and a Variance. The project includes lifting the existing two-story single-family residence 3'8" so that the home is compliant with FEMA. The project includes expanding the second story deck and removing the

existing stairs. A new first story porch is proposed below the new second story deck which will encroach into the side yard setback.

Assistant Planner Lopez presented the staff report and Eric Spletzer presented on behalf of his clients, the homeowners.

The public hearing was opened, and no one wished to speak.

Steven Sutro

- Supports the project as designed.
- Suggests even adding more height if it helps prevent further flooding.
- Height is fine from an architectural critique standpoint.
- Supports the Variance given the 15-foot setbacks.
- Design of terrace is really cool.
- Upper deck is a little close to the neighbor, suggest a planter at the side for privacy.

Joey Buckingham

- Supports the project as designed.
- Should raise it even more if the fenestration changes to match the scale of the walls. Windows should be taller.
- Normally ADR does not support second story decks, if there was a second means of egress, she could support it.

<u>Mark Fritts</u>

- Height is supportable.
- Agrees with Joey about the windows.
- Look at proportions of garage and windows.
- Can't make a finding for the second story deck especially making it larger.
- Support ground floor deck.

Laura Dewar

- Supports the height increase.
- Supports the second story deck especially because it is already there.

Mark Kruttschnitt

- Supports the height increase.
- Does not support the second story deck.
- Ground floor deck is okay.

d. Property Address: 34 Poplar Avenue

A.P.N.:	073-272-05
Applicant:	Tristan Warren Architect
Property Owner:	Jeff and Cassie Shouger
Zoning:	R-1:B7_5

General Plan:ML (Medium Low Density)Flood Zone:AE (Floodway)

Project Summary: The applicant is requesting approval of an Accessory Dwelling Unit (ADU) Permit to construct a 710 square foot attached ADU over the existing garage and patio with a new deck. Due to the location of the proposed ADU, the ADU is encroaching into the side yard setback, therefore requiring an ADU Permit.

Assistant Planner Lopez presented the staff report. Tristan Warren introduced the project on behalf of the homeowners. THE ADR members asked the architect questions and he answered them to provide clarification.

The public hearing was opened and Michael Lind supported the project and the location of the ADU above the garage. Jeff Shouger spoke about the project, reduction of the massing and façade from the street. Jeff indicated that he did a lot of public outreach and the neighbors were all supportive.

<u>Mark Kruttschnitt</u>

- Supports the project.
- Likes the ADU over the garage, likes where it is set.
- Does not like the second story deck, thinks it is impactful to the people on the street.
- Lots of glazing on one side of the ADU especially if there is not a deck.
- No reason to shorten the garage, will not make a difference in the actual mass of the structure.
- Supports the project as is with the second story deck removed and the glazing removed.

Steven Sutro

- Generally, supports the project with some modifications.
- Move the garage 2 feet back.
- Move the ADU 2 feet back.
- The third skylight closest to the street should be removed.
- Wishes that the roof shapes were more cohesive, maybe a hip at the front.
- Thinks deck is okay, given the business of the street.
- Is okay with widening the garage.
- The architect asked a question about the hipped roof suggestion.

Joey Buckingham

- Would like to see the ADU pushed back as far as possible.
- Is fine with the 2 feet setback.
- The ADU is well placed.
- The propose ADU is dwarfing the existing house, would like to see the ADU and main house match.
- Is okay with widening the garage.

• Change the roof to a hip roof.

Mark Fritts

- Likes the location of the ADU.
- Would like to see the ADU pulled back.
- Supports the deck.
- Would like to see the roof change from a gable roof to a hip roof.
- Would like to see the ADU match the existing home.
- Likes the materials of the ADU.

<u>Laura Dewar</u>

- Generally, supports the project.
- Want the ADU pushed back more.
- Supports the deck.

5. Conceptual ADR

- 6. Information and Discussion.
- 7. New Agenda Items.

Adjournment, 9:15 PM.

Next scheduled regular meeting date and time: March 21, 2023, at 7:00 PM.